Community Care Clinic - Dental

ABBREVIATIONS

ABBREVIA	ATIONS		
1R1S	(1) ROD + (1) SHELF	NCSBC	NORTH CAROLINA STATE BUILDING CODI
ACI	AMERICAN CONCRETE INSTITUTE	N.I.C.	NOT IN CONTRACT
ACT	ACOUSTICAL CEILING TILE	NO.	NUMBER
AFF	ABOVE FINISH FLOOR	NOM.	NOMINAL
AFG	ABOVE FINISH GRADE	O.C.	ON CENTER
AHU	AIR HANDLING UNIT	O.D.	OVERFLOW DRAIN/OUTSIDE DIAMETER
ALUM.	ALUMINUM	O.H.	OPPOSITE HAND
AM	ANTE MERIDEN	OPNG.	OPENING
ARCH.	ARCHITECTURAL	O/S	OUTSIDE
ASTM	AMERICAN SOCIETY FOR TESTING AND MATERIALS		OPEN TO BELOW
BFE	BASE FLOOD ELEVATION	PC	PLUMBING CONTRACTOR
B.O.	BOTTOM OF	PH	PHASE
CJ	CONTROL JOINT	PJ	PANEL JOINT
CAB.	CABINET	PL	POINT LOAD
CLG	CEILING	P-LAM	PLASTIC LAMINATE
CMU	CONCRETE MASONRY UNIT	PME	PLUMBING, MECHANICAL, & ELECTRICAL
CO	CLEANOUT	PP	PUSH PAD
CONC.	CONCRETE	PSF	POUNDS PER SQUARE FOOT
CONT.	CONTINUOUS	PSI	POUNDS PER SQUARE INCH
CPET	COMMON PATH OF EXIT TRAVEL	PSL	PARALLEL STRAND LUMBER
CW	COLD WATER	P.T.	PRESSURE TREATED
DBL	DOUBLE	PNTD	PAINTED
DR.	DOOR	P.W. / PWD	PLYWOOD
DWG.	DRAWING	RC	REINFORCED CONCRETE
DWV	DRAIN/ WASTE/ VENT	RCP	REFLECTED CEILING PLAN
DS	DOWNSPOUT	RD	ROOF DRAIN
DTL.	DETAIL	REINF	REINFORCED OR REINFORCING
EC	ELECTRICAL CONTRACTOR	REQ'D	REQUIRED
EJ.	EXPANSION JOINT	RL	ROOF LEADER
ELECT.	ELECTRICAL	RUB	RUBBER
ELEV.	ELEVATION	SAN	SANITARY
ETC.	ETCETERA	SF	SQUARE FOOT OR SQUARE FEET
E.T.R.	EXISTING TO REMAIN	SIM	SIMILAR
EWC	ELECTRIC WATER COOLER	SP	SOUTHERN PINE
EXIST.	EXISTING	SPF	SPRUCE/ PINE/ FIR
EXT.	EXTERIOR	SS	STAINLESS STEEL
FBGLS.	FIBERGLASS	STOR	STOREFRONT
FCP	FIBER CEMENT PANEL	STL.	STEEL TRAVEL BIOTANIOS
FD	FLOOR DRAIN	TD	TRAVEL DISTANCE
FF	FINISH FLOOR	TME	TO MATCH EXISTING
FEC	FIRE EXTINGUISHER CABINET	T.O.	TOP OF DIATE
FJ	FALSE JOINT	T.O.P.	TOP OF PLATE
FLR.	FLOOR	TRD. TYP.	TREAD
GC GA.	GENERAL CONTRACTOR GAUGE		TYPICAL UNLESS NOTED OTHERWISE
GA. GALV.		U.N.O. V	VOLT/ VOLTAGE
GEN	GALVANIZED	V VCT	VINYL COMPOSITE TILE
GS	GENERAL GANG STUD	VERT.	VERTICAL
GWB	GYPSUM WALL BOARD	VERT. VIF	VERTICAL VERIFY IN FIELD
H/C	HANDICAPPED	W/	WITH
HDWR	HARDWARE	WGL	WIRE GLASS
HM	HOLLOW METAL	WD	WOOD
HORIZ.	HORIZONTAL	VVD	WOOD
HP	HEAT PUMP		
IM	ICEMAKER		
INSUL.	INSULATION		
INT.	INTERIOR		
KW	KILOWATT		
LOCS.	LOCATIONS		
LSL	LAMINATED STRAND LUMBER		
MAX.	MAXIMUM		
MBT	MARBLE THRESHOLD		
MC	MECHANICAL CONTRACTOR		
MCJ	MASONRY CONTROL JOINT		
MEJ	MASONRY EXPANSION JOINT		
MECH.	MECHANICAL		
MFR.	MANUFACTURER		
MIN.	MINIMUM		
MT	METAL THRESHOLD		
MTL.	METAL		
IVI I L.	1VIL 17 \L		

GENERAL CONSTRUCTION NOTES

- 1. THESE DRAWINGS CONTAIN THE MINIMUM INFORMATION NECESSARY FOR ANY REPUTABLE CONTRACTOR TO UNDERTAKE CONSTRUCTION. THE CONTRACTOR SHALL FURNISH ALL LABOR, MATERIALS, EQUIPMENT AND SERVICES NECESSARY FOR THE COMPLETION OF THE PROJECT. HE SHALL COMPLETE THE WORK IN THE BEST AND MOST WORKMANLIKE MANNER, AND DO EVERYTHING PROPERLY INCIDENTAL THERETO, AS SHOWN ON THE PLANS, REQUIRED BY ALL APPLICABLE CODES, AS RECOMMENDED BY PRODUCT MANUFACTURERS, AND IN ACCORDANCE WITH CONTRACT DOCUMENTS.
- ALL WORK SHALL BE IN COMPLIANCE WITH THE CURRENT NORTH CAROLINA BUILDING CODE THE CONTRACTOR SHALL VERIFY DIMENSIONS BEFORE BEGINNING WORK. DIMENSIONS FOR NEW CONSTRUCTION SHOULD BE HELD TO THE MAXIMUM EXTENT POSSIBLE. 4. PREMISES OF THE ENTIRE JOB SITE WILL BE MAINTAINED IN A NEAT AND ORDERLY CONDITION DURING THE ENTIRE CONSTRUCTION PERIOD. THE CONTRACTOR SHALL CONFORM TO ALL
- 5. PRIOR TO THE FINAL PAYMENT THE CONTRACTOR SHALL GIVE TO THE OWNER A LABELED BINDER CONTAINING A LIST OF ALL SUPPLIERS AND SUBCONTRACTORS WITH ADDRESSES AND PHONE NUMBERS, GUARANTEES, AND OPERATION AND MAINTENANCE MANUALS OF ALL EQUIPMENT. THE
- CONTRACTOR SHALL WARRANT THE WORK FOR A PERIOD OF ONE YEAR. 6. IF A PORTION OF THE WORK HAS BEEN COVERED WHICH THE ARCHITECT HAS NOT SPECIFICALLY REQUESTED TO OBSERVE PRIOR TO ITS BEING COVERED, THE ARCHITECT MAY REQUEST TO SEE SUCH WORK AND IT SHALL BE UNCOVERED BY THE CONTRACTOR. IF SUCH WORK IS IN ACCORDANCE WITH THE CONTRACT DOCUMENTS, COSTS OF UNCOVERING AND REPLACEMENT SHALL, BY APPROPRIATE CHANGE ORDER, BE CHARGED TO THE ARCHITECT. IF SUCH WORK IS NOT IN ACCORDANCE WITH THE CONTRACT DOCUMENTS. THE CONTRACTOR SHALL PAY SUCH COSTS UNLESS THE CONDITION WAS CAUSED BY THE OWNER OR A SEPARATE CONTRACTOR IN WHICH EVENT THE OWNER SHALL BE RESPONSIBLE FOR PAYMENT OF SUCH COSTS. THE CONTRACTOR SHALL PROMPTLY CORRECT THE WORK REJECTED BY THE ARCHITECT OR FAILING TO CONFORM TO
- THE REQUIREMENTS OF THE CONTRACT DOCUMENTS. . ALL CONCRETE SHALL BE 3000 PSI MINIMUM, AND ALL WORK SHALL BE PERFORMED IN
- ACCORDANCE WITH THE APPLICABLE REQUIREMENTS OF THE ACI AND ASTM. 8. LIGHT GAUGE STEEL FRAMING SHALL BE IN ACCORDANCE WITH THE LIGHT-GAUGE STEEL FRAMING
- CONSTRUCTION MANUAL AND AS PER ASTM A446, A570, OR A611. 9. REINFORCING BARS FOR CONCRETE WORK SHALL BE GRADE 60, DEFORMED AS PER ASTM A615. 10. WELDED WIRE FABRIC SHALL BE AS PER ASTM A185 OF SIZES AND TYPE AS SHOWN ON DRAWINGS. 11. METAL TIE DOWN STRAPS, ANCHORS AND CLIPS SHALL BE AS PER "SIMPSON STRONGTIE" OR
- 12. WOOD FRAMING AND BLOCKING SHALL BE #2 SPF OF THE SIZES INDICATED AND SHALL HAVE A MIN.
- 13. THE CONTRACTOR SHALL BE RESPONSIBLE FOR ALL ROOFING IN ACCORDANCE WITH NRCA REQUIREMENTS AND THE ROOFING PRODUCT MANUFACTURER'S RECOMMENDATIONS INCLUDING WATERPROOFING OF ALL PENETRATIONS AND SUPPORTS FOR MECHANICAL EQUIPMENT, AND AS SHOWN ON DRAWINGS
- 14. THE CONTRACTOR SHALL DETERMINE BEFORE BEGINNING WORK WHETHER AN ELEVATION CERTIFICATE WILL BE REQUIRED AND SHALL OBTAIN THE CERTIFICATE AT THE EARLIEST
- OPPORTUNITY. ONE COPY MUST BE PROVIDED FOR THE OWNER. 15. THE CONTRACTOR SHALL BE RESPONSIBLE FOR ALL INSULATION. INSULATION SHALL BE INSTALLED IN FULL CONTACT WITH SHEATHING AND GWB OF WALL CAVITY. FLOOR AND CEILING INSULATION SHALL BE IN FULL CONTACT WITH GWB. INSULATION SHALL BE INSTALLED TO MANUFACTURER'S SPECIFICATIONS, WITH NO SUBSTANTIAL GAPS, VOIDS, COMPRESSION OR WIND
- 16. SOIL SHALL BE FREE OF ORGANIC MATERIAL AND CONSOLIDATED TO BE CAPABLE OF 1,500 PSF
- AND LIMIT LONG TERM SETTLEMENT. 17. CAULK ALL GAPS IN FRAMING AND SHEATHING AT FRAMING ROUGH-IN. CAULK GAPS IN GWB NOT SEALED BY TAPE AND JOINT COMPOUND. AIR TIGHTNESS SHALL BE LESS THAT OR EQUAL TO .30 CFM50 PER SQUARE FOOT OF CONDITIONED ENVELOPE AREA.




DEMOLITION NOTES

- 1. THESE DRAWINGS ARE BASED ON FIELD OBSERVATIONS AND MEASUREMENTS OF THE EXISTING STRUCTURE. DIMENSIONS FOLLOWED BY A +/- MAY BE ADJUSTED TO MEET ACTUAL DISCREPANCIES IN THE DRAWINGS SHOULD BE ANTICIPATED. THE GENERAL CONTRACTOR SHALL RESOLVE SUCH DISCREPANCIES WITH REGARD TO THE BUILDING'S STRUCTURAL INTEGRITY.
- 2. ELECTRICAL SERVICE SHALL BE TERMINATED AS APPROPRIATE PRIOR TO THE COMMENCEMENT OF DEMOLITION.
- TERMINATION OF GAS SERVICE SHALL BE VERIFIED PRIOR TO THE COMMENCEMENT OF 4. THE GENERAL CONTRACTOR SHALL SEQUENCE THE WORK SO AS TO PROTECT THE
- EXISTING STRUCTURE FROM EXCESSIVE WATER DAMAGE, UNAUTHORIZED ACCESS, ETC. 5. THE GENERAL CONTRACTOR SHALL TAKE APPROPRIATE MEASURES TO MAINTAIN THE
- BUILDING'S STRUCTURAL INTEGRITY. 6. IT SHALL BE THE OWNER'S OPTION TO SALVAGE ANY REMOVED STRUCTURES, ARCHITECTURAL COMPONENTS, WINDOWS, FIXTURES, EQUIPMENT OR HARDWARE FOR SALE OR RE-USE. IT WILL BE THE CONTRACTOR'S RESPONSIBILITY TO COORDINATE WITH THE OWNER'S REPRESENTATIVE ALL ITEMS TO BE SALVAGED PRIOR TO DEMOLITION AND REMOVAL OF MATERIALS FROM THE SITE.
- 7. EXISTING STRUCTURAL COLUMNS, BEAMS AND WALLS SHALL REMAIN U.N.O. 8. TEMPORARY SUPPORT OF RAFTERS SHALL BE PROVIDED WHERE ROOF STRUCTURE OR WALLS SUPPORTING ROOF STRUCTURE ARE TO BE REMOVED. 9. TEMPORARY SUPPORT OF JOISTS SHALL BE PROVIDED WHERE BEARING WALLS ARE TO
- BE REMOVED. 10. TEMPORARY SUPPORT OF THE FLOOR STRUCTURE SHALL BE PROVIDED WHERE FLOOR AREAS ARE PARTIALLY REMOVED.
- 11. SOME PLUMBING FIXTURES AND PIPING SHALL BE REMOVED. PLUG ALL ABANDONED PIPING AND FLOOR DRAINS EVEN WITH THE FLOOR OR WALL SURFACE.
- 12. ALL GAS EQUIPMENT AND PIPING SHALL BE REMOVED. GAS-TORCH CUTTING OF GAS
- PIPING SHALL NOT BE PERMITTED. 13. DISCONNECT EXISTING ELECTRICAL SERVICE AT SERVICE ENTRY AND PROPERLY CAP ALL
- EXPOSED WIRING AS PER CODE. 14. ALL UTILITIES MUST BE CUT, CAPPED, TERMINATED, AND PROPERLY ISOLATED SO THAT NO DAMAGE OCCURS TO PARTS OF ANY SYSTEM THAT ARE TO REMAIN OR SERVE OTHER BUILDINGS THAT ARE NOT PART OF THE DEMOLITION. CONDITIONS.
- 16. INASMUCH AS THE REMODELING AND/OR REHABILITATION OF AN EXISTING BUILDING REQUIRES THAT CERTAIN ASSUMPTIONS BE MADE REGARDING EXISTING CONDITIONS, AND BECAUSE SOME OF THESE ASSUMPTIONS MAY NOT BE VERIFIABLE WITHOUT EXPENDING ADDITIONAL SUMS OF MONEY, OR DESTROYING OTHERWISE ADEQUATE OR SERVICEABLE PORTIONS OF THE BUILDING THE OWNER AGREES THAT, EXCEPT FOR NEGLIGENCE ON THE PART OF THE DESIGN PROFESSIONAL, THE OWNER WILL HOLD

15. INFILL AT DOOR OPENINGS SHALL MATCH SURROUNDING CONSTRUCTION AS NEARLY AS

AND ALL CLAIMS ARISING OUT OF THE PROFESSIONAL SERVICES PROVIDED UNDER THIS 17. WHERE NEW CONSTRUCTION IS SHOWN IN ALIGNMENT WITH EXISTING COLUMNS OR THE EDGE OF AN EXISTING MASONRY OPENING THE ALIGNMENT SHOULD BE MAINTAINED. ANY EXISTING CONDITIONS WHICH PROHIBIT NEW CONSTRUCTION IN CONFORMANCE WITH THE DRAWINGS SHALL BE BROUGHT TO THE ATTENTION OF THE ARCHITECT.

HARMLESS, INDEMNIFY AND DEFEND THE DESIGN PROFESSIONAL FROM AND AGAINST ANY

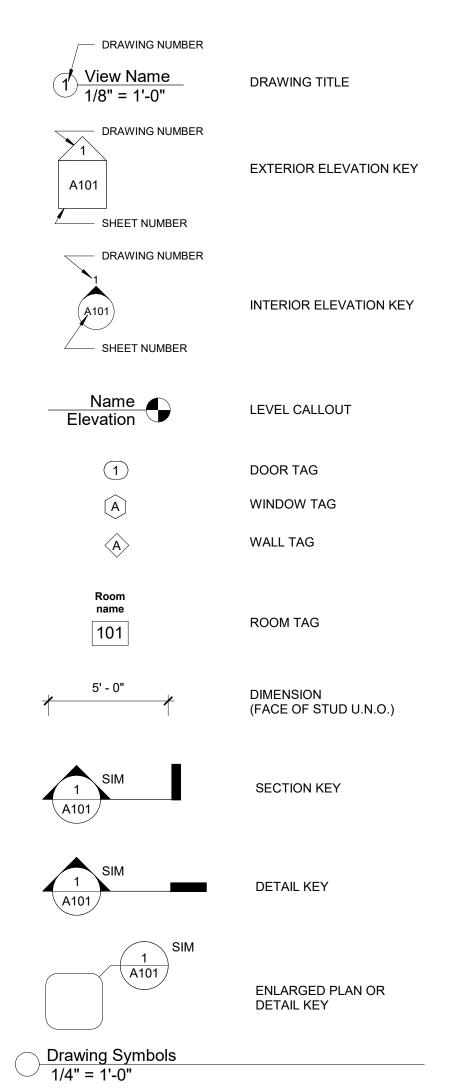

Drawing Index									
Sheet Number Sheet Name									
A001	Cover Sheet								
A002	Appendix B								
A003	Life Safety & Area Plans								
A101	First Floor Plan								
A102	Ramp Plan and Details								
A401	Enlarged Plans & Interior Elevations								
P101	Plumbing Supply Plan								
P102	Plumbing Waste Plan								
P103	Plumbing Air & Vacum Plan								
P201	Plumbing Schedule & Riser								
P202	Plumbing Notes & Details								
DM101	Mechanical Demolition Plan								
M101	Mechanical Plan								
M202	Mechanical Notes & Details								
E101	Electrical Demolition Plans								
E102	Electrical Plans								
E103	Electrical Low Voltage Plans								
E201	Electrical Power Riser & Panel Schedule								
E301	Electrical Notes & Light Fixture Schedule								
DA001	Dental Equipment Supplier Drawing								
DA111	Dental Equipment Supplier Drawing								
DA113	Dental Equipment Supplier Drawing								
DB110	Dental Equipment Supplier Drawing								
DE110	Dental Equipment Supplier Drawing								
DP110	Dental Equipment Supplier Drawing								
DX110	Dental Equipment Supplier Drawing								



Community Care Clinic -


425 Health Center Dr. Nags Head, NC

December 12, 2022

Cover Sheet

1/4" = 1'-0"

Drowing Indov	ן
Drawing Index	
	1
Sheet Name	
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endix B	The designer shall not be responsible for any omission, defect or deficiency in the contract
Safety & Area Plans	("error") prepared by the designer or its cons
Floor Plan	which in any way impacts the schedule of the
p Plan and Details	results in a lack of coordination among the co
rged Plans & Interior Elevations	documents, delays the completion of the projection of the projecti
bing Supply Plan	which in any other way causes any damage of the owner, contractor, subcontractors, or other
bing Waste Plan	involved in the project, unless: (i) designer is
bing Air & Vacum Plan	notified of such error, in any event within 14 d
bing Schedule & Riser	date such error was discovered or could reas
bing Notes & Details	have been discovered; and (ii) designer is give
nanical Demolition Plan	opportunity at the time of discovery to addres error, and, if appropriate, take such steps as
nanical Plan	necessary to correct and resolve it. Failure to
nanical Notes & Details	with the provisions of this paragraph shall cor
rical Demolition Plans	waiver of any claim for damages, or a right to
rical Plans	against designer by owner, contractor or othe
rical Low Voltage Plans	shall in no event cause or allow a reduction in
rical Power Riser & Panel Schedule	otherwise due designer for services provided project.
rical Notes & Light Fixture Schedule	1 ' '
al Equipment Supplier Drawing]
al Equipment Supplier Drawing	WIND AREA TO TEN 40
al Equipment Supplier Drawing	HILLER STEREDAROW OF THE CTURAL STEEL OF THE C
al Equipment Supplier Drawing	AREY 170 TILL STEN ARE ARCHITECTURAL RECTURAL

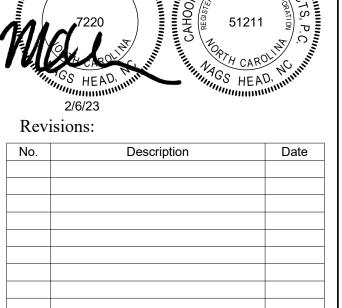

Reviewed: Checker

2018 APPENDIX B

BUILDING CODE SUMMARY FOR ALL COMMERCIAL PROJECTS

Name of Project: Community Care Clinic - Dental

Owner/Authorized Agent: Lyn Jenkins

Nags Head, NC

Code Enforcement Jurisdiction: x City Nage Head

Address:

Owned By:

425 Health Center Dr.

x City/County

(EXCEPT 1 AND 2-FAMILY DWELLINGS AND TOWNHOUSES) (Reproduce the following data on the building plans sheet 1 or 2

Private

State State

CONTA	CT: Mark h	Kasten, AIA						
DESIG	NER	FIRM		NAME	LIC#	TELEPHONE #	E-MA	IL
Archite	ctural	Cahoon + Kasten Arcl	hitects	Mark Kasten	7220	252.441.0271	mark@ob	karchitects.com
Civil								
Electric		Atlantec Engineers, P	.A.	David J. Whitney	17382	919.571.1111	david@atla	antecengineers.com
Fire Ala Plumbii		Atlantas Engineers D	^	James B. Delpapa	22025	919.571.1111	:: O -#	
Mechar		Atlantec Engineers, P Atlantec Engineers, P		James B. Delpapa		919.571.1111		tecengineers.com tecengineers.com
	er-Standpipe	Atlantec Engineers, F	.л.	заптез В. Беграра	22033	919.371.1111	Jimwalian	tecengineers.com
Structur								
	ng Walls >5'h							
Other								
1010 NG	DITH DING	CODE						
	EBUILDING		Shell ocal inspec	/ Core*	for poss riptive	Construction*	ocedure evel I	nterior Completion s and requirements. Historic Property Change of Use
RENOV	ATED: (date)		CURREN PROPOS	ED OC	Alteration Lecupancy(S) (Claudin Cupancy(S)) (Claudin Cupancy(S))	n. 3):	
		Γable 1604.5):	Curi	rent:	Pro	posed:		
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(check al Sprinkle Standpir Primary	l that apply) rs: X nes: X Fire District	I-B No Partial No Class : X No	I	II-B] III-B] NFPA] Wet Hazard	. 13R		X V-B
Special I	Inspections R	equired: x			n for ad	ons are required, on ditional procedure		he local inspection equirements.
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2nd Flo Mezzar								
1st Floo				5190 SF				5190 SF
Baseme				0100 01				0100 01
Total				5190 SF				5190 SF
			ΔI	LOWABLE AR	EΔ			
Assen	nbly			A-3 A-4] A-5			
Busin Educa		X						
Factor		F-1 Mode	erate 🔲 I	F-2 Low				
Hazar	•	H-1 Deto		H-2 Deflagrate	H-3 C	ombust 🔲 H-4 I	Health	H-5 HPM
Institu	tional	I-1	I-2	I-1 & I-2 Cond	=	1 2		
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Storag	ge	S-1 Mode		S-2 Low	′ [High Pile Enclosed	□ n	
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-	` .	4 - List Code Section hapter 5 - List Code S						
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		Area of Occupancy A Area of Occupancy		Actual Area o Allowable Area			≤ 1	
	Allowable	Area of Occupancy	А	Allowable Area	oj Occi	ирансу В		
			- +				=	≤ 1
			·					
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		(AC	CTUAL)			INCREAS	H1,3	OR UNLIMITED ^{2,3}
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	Buil	ding Area	5190 SF	Maxi	imum A	llowable Building	Area	9000 SF
Г 4		C C 4: 506	2	4 141				
_	•	ses from Section 506. n fronts a public way			at mainim		(E)	
		-	or open sp	_	et 111111111	num widin —	(F)	
		(F/P)		_ (1)				
		width of public way	=	(W)				
		age increase If = 10				(%)		
² Unlimit	ed area applic	able under condition	s of Section	on 507.				
	_	Area = total number o		-		, ,	6.2).	
		f open parking garag				•		
Frontag	ge increase is l	pased on the unsprint	klered area	value in Table 5	06.2.			
			ALLOV	WABLE HEIGH	T			
				LOWABLE		WN ON PLANS	СО	DE REFERENCE ¹
Buildin	g Height in Fe	eet (Table 504.3) ²		2'		1		
		ories (Table 504.4) ³		40		20		_
1. Provid 2. The m	le code reference aximum height o	if the "Shown on Plans" of air traffic control tower	quantity is n	ot based on Table 50	4.3 or 50	4.4.		
		of open parking garages						
		PERCENT	AGE OF	WALL OPENIN	IG CAI	CULATIONS		
	WALL	FIRE SEPA		DEGREE OF			ABLE	ACTUAL SHOWN
		DISTANCE		PROTE		ARE	A	ON PLANS
		1				(0/)		(0/)
		PROPERTY LI	NES (FEE	(TABLE	£ 705.8)	(%))	(%)

Exit Signs: No X Yes Fire Alarm: X No Yes Smoke Detection Systems: X No Yes Carbon Monoxide Detection: X No Yes LIFE SAFETY PLAN REQUIREMENTS Life Safety Plan Sheet #: Fire and/or smoke rated wall locations (Chapter 7) Assumed and real property line locations (if not on the site plan) Exterior wall opening area with respect to distance to assumed property lines (705.8) Occupancy Use for each area as it relates to occupant load calculations (Table 1004.1.2) Occupant loads for each area Exit access travel distances (1017)	BUILDING ELEMENT													
PRESENTED PRESENTED PROVIDED PROVIDE	BUILDING ELEMENT		FIRE P	ROTECTION	I REOUIREN	MENTS								
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Shafts Enclosures - Other Corridor Separation Corridor Separa	Columns Supporting Roof		0											
Cocupancy Fire Barrier Separation Smoke Detail of Separation Smoke														
Cocupancy Fire Barrier Separation														
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Exit Signs: No X Yes Simoke Detection Systems: No Yes Carbon Monoxide Detection: No Yes LIFE SAFETY PLAN REQUIREMENTS Carbon Monoxide metal property line locations (Chapter 7) Assumed and real property line locations (if not on the site plan) Exterior wall opening area with respect to distance to assumed property lines (705.8) Cocupant loads for each area as it relates to occupant load calculations (Table 1004.1.2) Cocupant loads for each area Exit access travel distances (1017) Common path of travel distances (1006.2.1 & 1006.3.2(1)) Dead end lengths (1020.4) Clear exit widths for each exit door Maximum calculated occupant load capacity each exit door can accommodate based on egress width (1005.3) Actual occupant load for each exit door A separate schematic plan indicating where fire rated floor/ceiling and/or roof structure is provided for purposes of occupancy separation Location of doors with genic hardware (1010.1.10) Location of doors with electromagnetic egress locks (1010.1.9.9) Location of doors with electromagnetic egress locks (1010.1.9.9) Location of doors with electromagnetic egress locks (1010.1.9.9) Location of doors with beleaved egress locks and the amount of delay (1010.1.9.7) Location of doors with beleaved egress locks and the amount of delay (1010.1.9.7) Location of doors with beleaved egress locks (1010.1.9.9) Location of doors with electromagnetic egress locks (1010.1.9.9) Location of doors with electromagne	LIFE SAFETY SYSTEM	REQUIRE	MENTS											
Eire Alarm:	Emergency Lighting:] No	x Yes										
Smoke Detection Systems: X No Yes Partial Carbon Monoxide Detection: X No Yes LIFE SAFETY PLAN REQUIREMENTS Life Safety Plan Sheet #: Fire and/or smoke rated wall locations (Chapter 7) Assumed and real property line locations (if not on the site plan) Exterior wall opening area with respect to distance to assumed property lines (705.8) Occupancy Use for each area as it relates to occupant load calculations (Table 1004.1.2) Occupant loads for each area Exit access travel distances (1017) Common path of travel distances (1006.2.1 & 1006.3.2(1)) Dead end lengths (1020.4) Clear exit widths for each exit door Maximum calculated occupant load capacity each exit door can accommodate based on egress width (1005.3) Actual occupant load for each exit door A separate schematic plan indicating where fire rated floor/ceiling and/or roof structure is provided for purposes of occupancy separation Location of doors with delayed egress locks and the amount of delay (1010.1.9.7) Location of doors with delayed egress locks and the amount of delay (1010.1.9.7) Location of doors with delayed egress locks (1010.1.9.9) Location of emergency escape windows (1030) The square footage of each fire area (202) The square footage of each fire area (202) The square footage of each smoke compartment for Occupancy Classification I-2 (407.5) Note any code exceptions or table notes that may have been utilized regarding the items above ACCESSIBLE DWELLING UNITS (SECTION 1107) TOTAL ACCESSIBLE ACCESSIBLE TYPE A TYPE B TYPE B TOTAL UNITS UNITS UNITS UNITS UNITS UNITS UNITS UNITS	Exit Signs:		==											
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LOT OR PARKING TOTAL # OF PARKING SPACES | # OF ACCESSIBLE SPACES PROVIDED | TOTAL #

PLUMBING FIXTURE REQUIREMENTS (TABLE 2902.1)

SPECIAL APPROVALS

Special approval: (Local Jurisdiction, Department of Insurance, OSC, DPI, DHHA, etc., describe below)

MALE FEMALE UNISEX

EXIST'G

REQ'D

SPACE NEW

REQUIRED PROVIDED REGULAR WITH VAN SPACES WITH ACCESSIBLE

WATERCLOSETS | URINALS | LAVATORIES | SHOWERS | DRINKING FOUNTAINS |

AISLE

5' ACCESS | 132" ACCESS | 8' ACCESS | PROVIDED

MALE FEMALE UNISEX /TUBS REGULAR ACCESSIBLE

AISLE AISLE

Ground Snow Load:

SEISMIC DESIGN CATEGORY:

Provide the following Seismic Design Paramet

Occupancy Category (Table 1604.5)

Basic structural system (check one)

Data Source:

Architectural, Mechanical, Components anchored?

LATERAL DESIGN CONTROL: Earthquake

Field Test (provide copy of test report)

Bearing wall

Building Frame

Simplified

Moment Frame

Spectral Response Acceleration

Site Classification (ASCE-7)

Analysis Procedure:

SOIL BEARING CAPACITIES:

Presumptive Bearing capacity

Pile size, type, and capacity

Floor

Basic Wind Speed Exposure Category

Dual w/Special Moment Frame

Inverted Pendulum

Dual w/Intermediate R/C or Special Steel

Yes No

Wind

Equivalent Lateral Force

Live Loads:

ENERGY SUMMARY	MECHANICAL SUMMARY
ENERGY REQUIREMENTS: The following data shall be considered minimum and any special attribute required to meet the energy code shall also be provided. Each Designer shall furnish the required portions of the project information for the plan data sheet. If performance method, state the annual energy cost for the standard reference design vs annual energy cost for the proposed design.	MECHANICAL SYSTEMS, SERVICE SYSTEMS AND EQUIPMENT Thermal Zone winter dry bulb:
Existing building envelope complies with code: [(If checked the remainder of this section is not applicable.)	summer dry bulb:
Exempt Building: Provide code or statutory reference:	Interior design conditions
Climate Zone: 3A 4A 5A Method of Compliance:	winter dry bulb: summer dry bulb: relative humidity: Building heating load: Building cooling load:
Energy Code Performance Prescriptive ASHRAE 90.1 Performance Prescriptive	Building heating load:
Other Performance (specify source)	Building cooling load:
THERMAL ENVELOPE (Prescriptive method only) Roof/ceiling Assembly (each assembly) Description of assembly: U-Value of total assembly: R-Value of insulation: Skylights in each assembly: U-Value of skylights: total s.f. of skylights in each assembly: Exterior Walls (each assembly) Description of assembly:	Unitary description of unit: heating efficiency: cooling efficiency: size category of unit: Boiler Size category. If oversized, state reason.: Chiller Size category. If oversized, state reason.: List equipment efficiencies:
U-Value of total assembly: R-Value of insulation: Openings (windows or doors with glazing U-Value of assembly: Solar heat gain coefficient: Projection factor: Door R-Values:	ELECTRICAL SUMMARY ELECTRICAL SYSTEM AND EQUIPMENT Method of Compliance: Energy Code: Prescriptive Performance ASHRAE 90.1: Prescriptive Performar
Walls below grade (each assembly) Description of assembly: U-Value of total assembly: R-Value of insulation: Floors over unconditioned space (each assembly) Description of assembly: U-Value of total assembly:	Lighting Schedule (each fixture type) lamp type required in fixture number of lamps in fixture ballast type used in the fixture number of ballasts in fixture total wattage per fixture total interior wattage specifie total exterior wattage specifie Allowed
R-Value of insulation: Floors slab on grade Description of assembly: U-Value of total assembly: R-Value of insulation: Horizontal/vertical requirement: Slab heated:	Additional Efficiency Packar (When using the 2018 NCE). required for ASHRAE 90.1) C406.2 More Efficient HVAC Equipment Performance C406.3 Reduced Lighting Power Density C406.4 Enhanced Digital Lighting Controls C406.5 On-Site Renewable Energy C406.6 Dedicated Outdoor Air System C406.7 Reduced Energy Use in Service Water Heating
STRUCTURAL DESIGN	

Community Care Clinic -Project No: **22027** Location: **425 Health Center Dr.** Nags Head, NC Title: Appendix B **December 12, 2022** Scale:

cahoon+kasten


118 West Woodhill Drive

Nags Head, North Carolina 27959

P.252.441.0271 F.252.441.8724


E. office@obxarchitects.com

The designer shall not be responsible for any error, omission, defect or deficiency in the contract documents ("error") prepared by the designer or its consultants which in any way impacts the schedule of the project, results in a lack of coordination among the contract documents, delays the completion of the project or which in any other way causes any damage or loss to the owner, contractor, subcontractors, or other entity involved in the project, unless: (i) designer is promptly notified of such error, in any event within 14 days of the date such error was discovered or could reasonably have been discovered; and (ii) designer is given opportunity at the time of discovery to address such error, and, if appropriate, take such steps as are necessary to correct and resolve it. Failure to comply with the provisions of this paragraph shall constitute a waiver of any claim for damages, or a right to offset against designer by owner, contractor or others and shall in no event cause or allow a reduction in the fees otherwise due designer for services provided on the

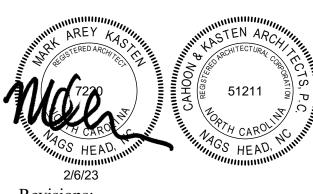


HEAD MANAGES 2/6/23 ions:	HEAD minu
Description	Date
	2/6/23 ions:


Reviewed: Checke

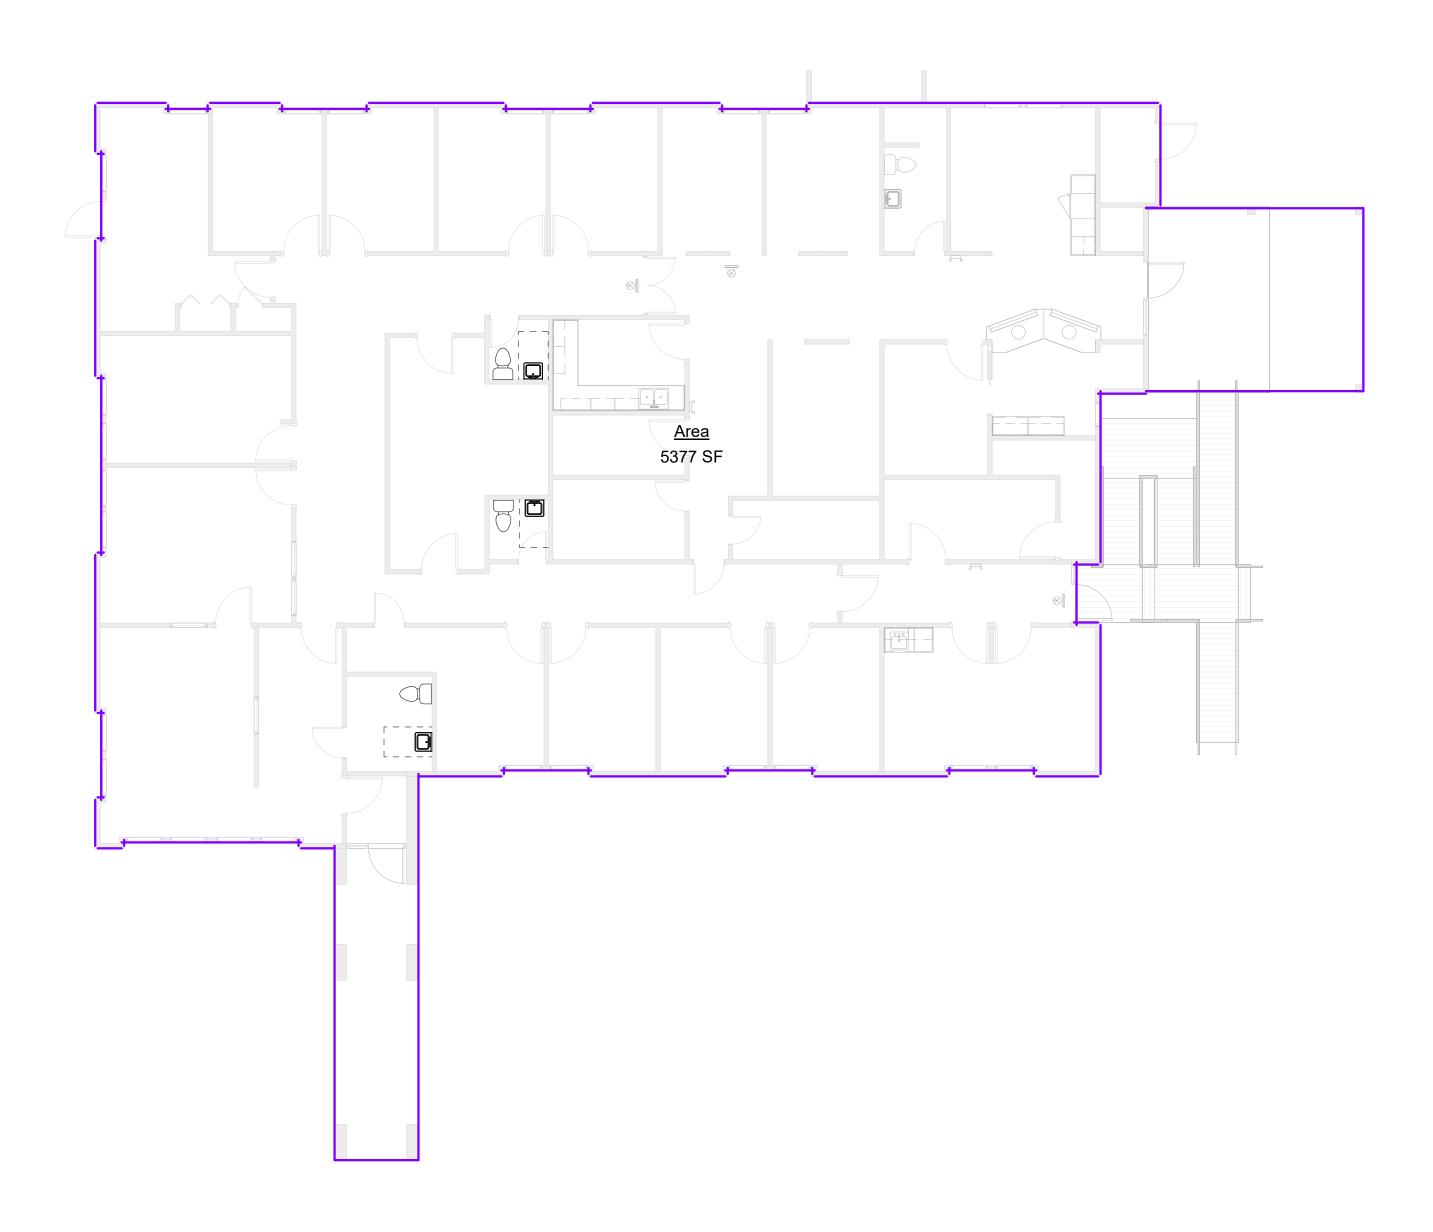

2 (1) First Floor 1/8" = 1'-0"

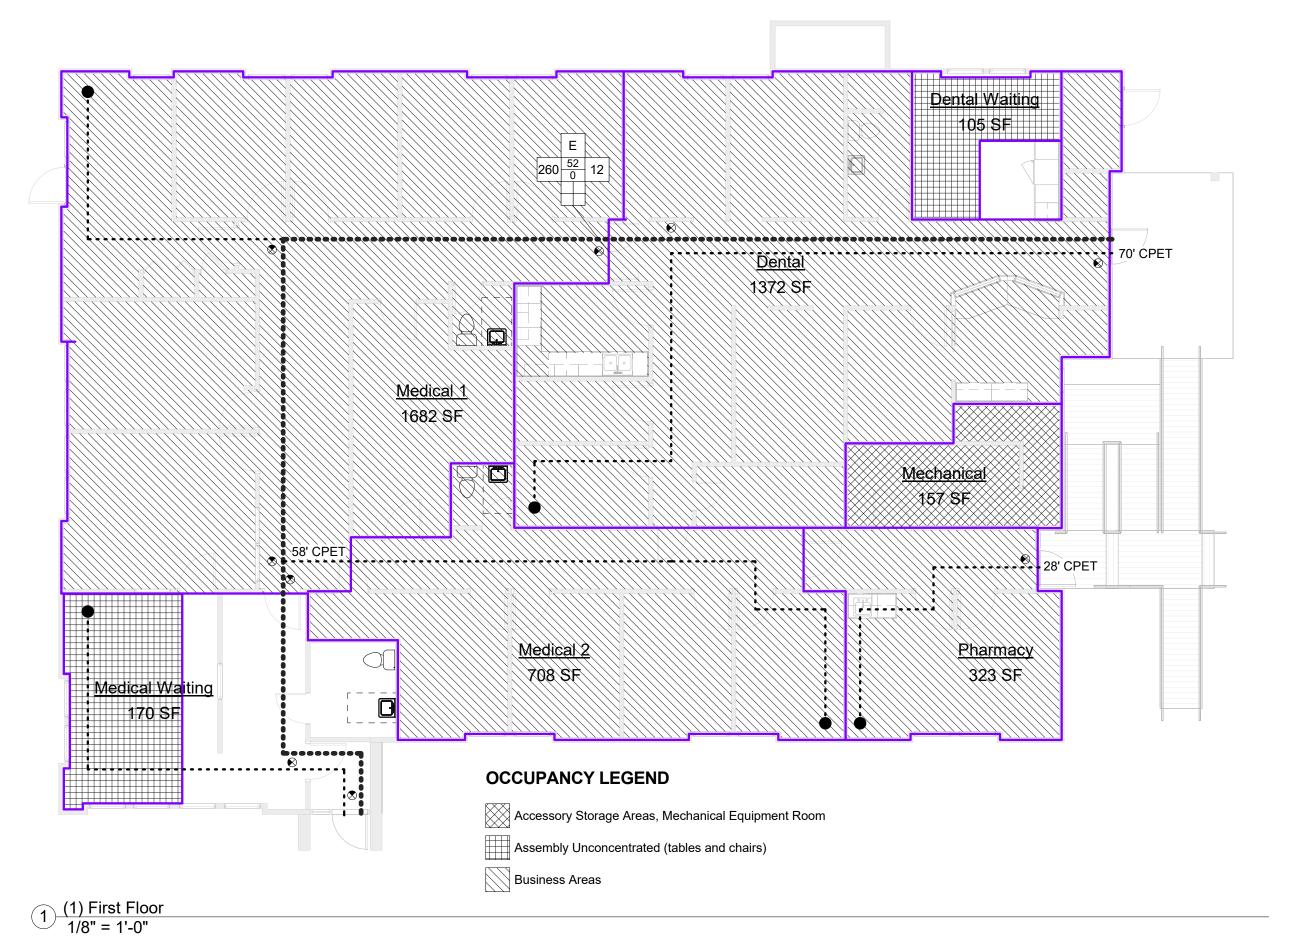

Occupant Schedule Occupancy | Area Per S.F. Type Occupant Occupants Number Area Occupancy Name 100 SF Medical 1 Business Areas Assembly Unconcentrated (tables and chairs) Medical Waiting 170 SF Assembly Unconcentrated (tables and chairs) 100 SF 300 SF Mechanical Accessory Storage Areas, Mechanical Equipment Room Gross 100 SF Medical 2 708 SF 100 SF **Business Areas** Grand total: 7

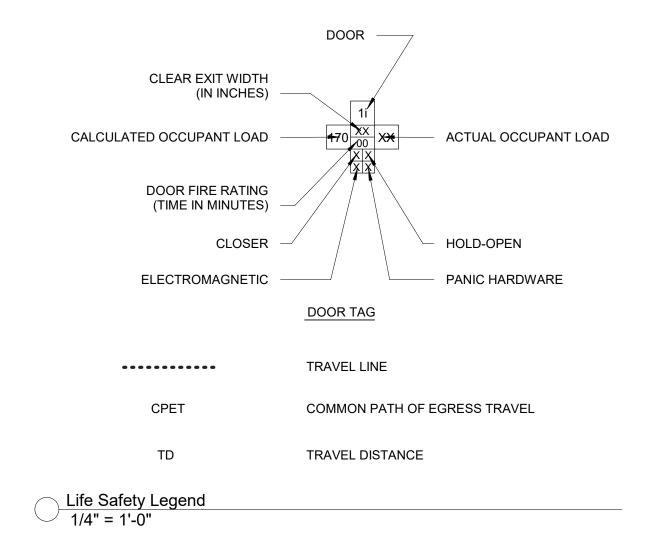



118 West Woodhill Drive Nags Head, North Carolina 27959 P.252.441.0271 F.252.441.8724 E. office@obxarchitects.com

Project: Community Care Clinic - Dental
Project No: 22027

Location: 425 Health Center Dr.


Nags Head, NC
e: Life Safety & Area

Plans

Date: **December 12, 2022**

Scale: As indicated

The designer shall not be responsible for any error, omission, defect or deficiency in the contract documents ("error") prepared by the designer or its consultants which in any way impacts the schedule of the project, results in a lack of coordination among the contract documents, delays the completion of the project or which in any other way causes any damage or loss to the owner, contractor, subcontractors, or other entity involved in the project, unless: (i) designer is promptly notified of such error, in any event within 14 days of the date such error was discovered or could reasonably have been discovered; and (ii) designer is given opportunity at the time of discovery to address such error, and, if appropriate, take such steps as are necessary to correct and resolve it. Failure to comply with the provisions of this paragraph shall constitute a waiver of any claim for damages, or a right to offset against designer by owner, contractor or others and shall in no event cause or allow a reduction in the fees otherwise due designer for services provided on the

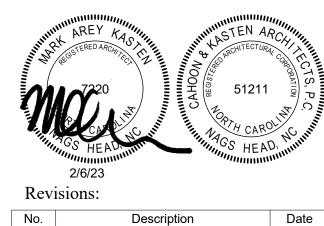


Revisions:

No. Description Date

Designed: Designer
Drawn: Author
Reviewed: Checker

A003

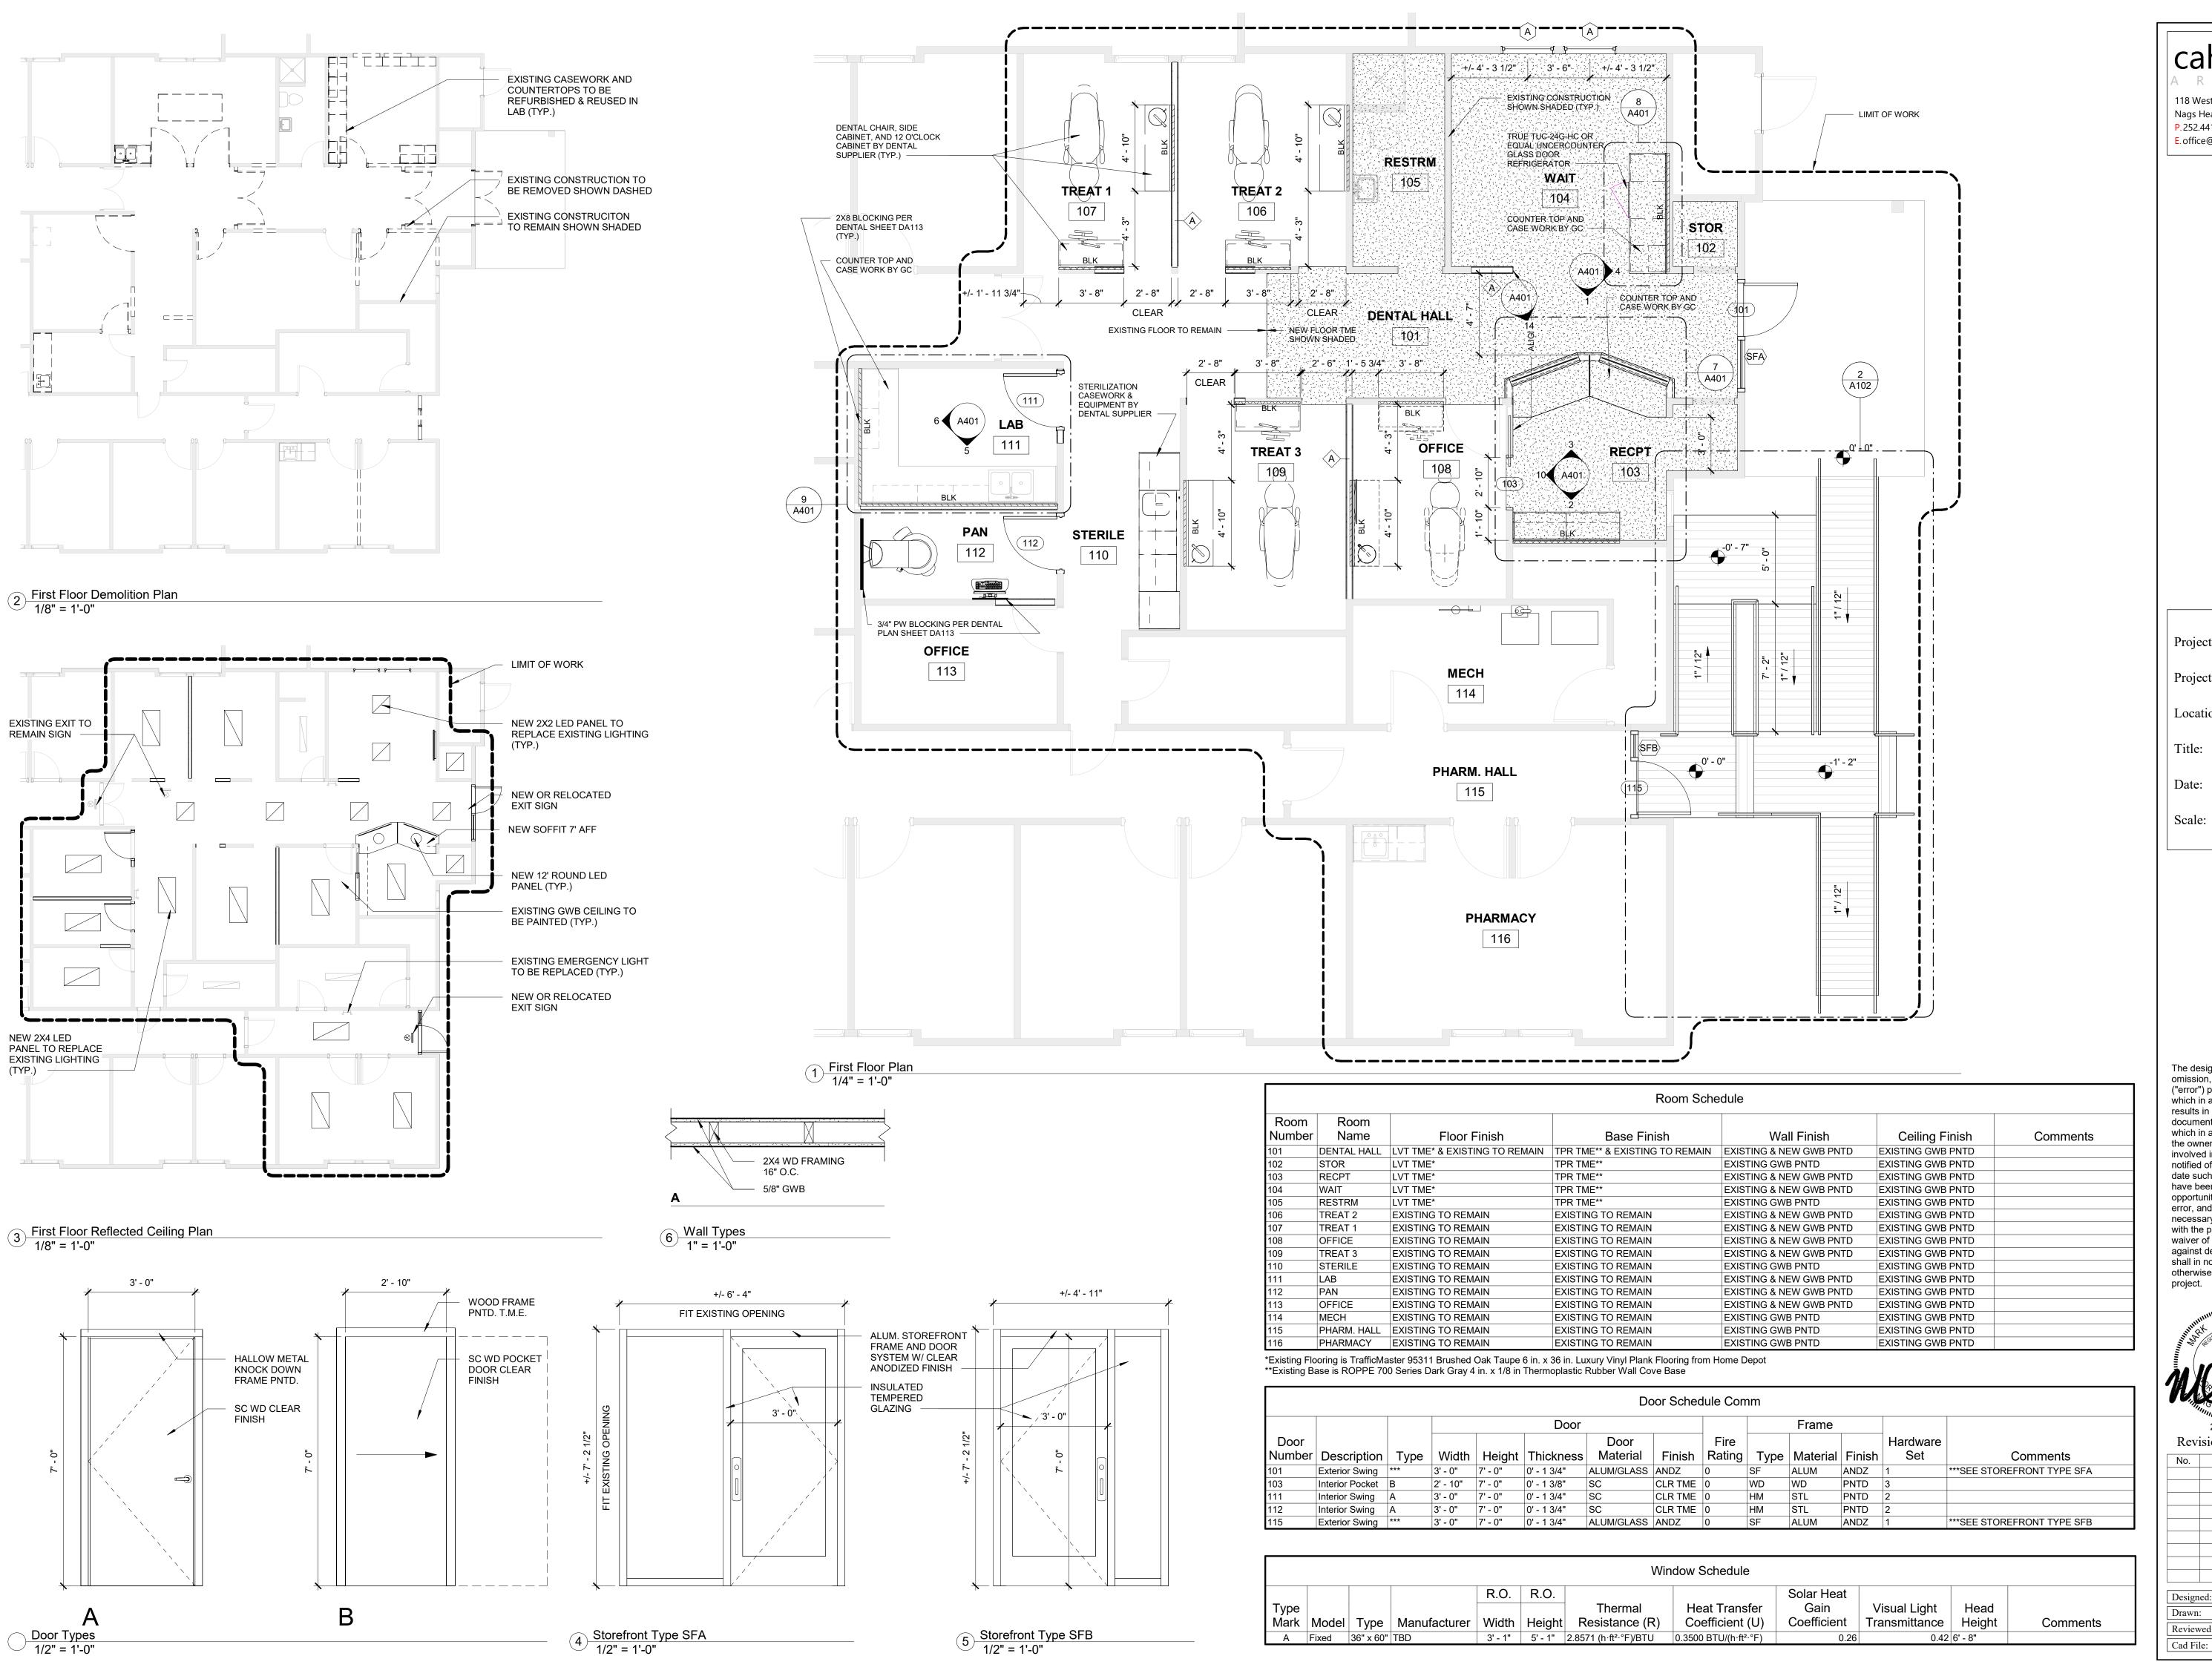

cahoon+kasten

118 West Woodhill Drive Nags Head, North Carolina 27959 P.252.441.0271 F.252.441.8724 E. office@obxarchitects.com

ject: Community Care Clinic Dental

Project No: **22027**


Location: 425 Health Center Dr. Nags Head, NC

First Floor Plan

Date: **December 12, 2022**

Scale: As indicated

The designer shall not be responsible for any error, omission, defect or deficiency in the contract documents ("error") prepared by the designer or its consultants which in any way impacts the schedule of the project, results in a lack of coordination among the contract documents, delays the completion of the project or which in any other way causes any damage or loss to the owner, contractor, subcontractors, or other entity involved in the project, unless: (i) designer is promptly notified of such error, in any event within 14 days of the date such error was discovered or could reasonably have been discovered; and (ii) designer is given opportunity at the time of discovery to address such error, and, if appropriate, take such steps as are necessary to correct and resolve it. Failure to comply with the provisions of this paragraph shall constitute a waiver of any claim for damages, or a right to offset against designer by owner, contractor or others and shall in no event cause or allow a reduction in the fees otherwise due designer for services provided on the

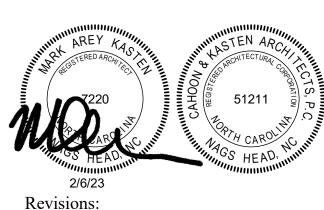



Revisions:

| Description | Date |

Designed: Designer
Drawn: Author
Reviewed: Checker

A101

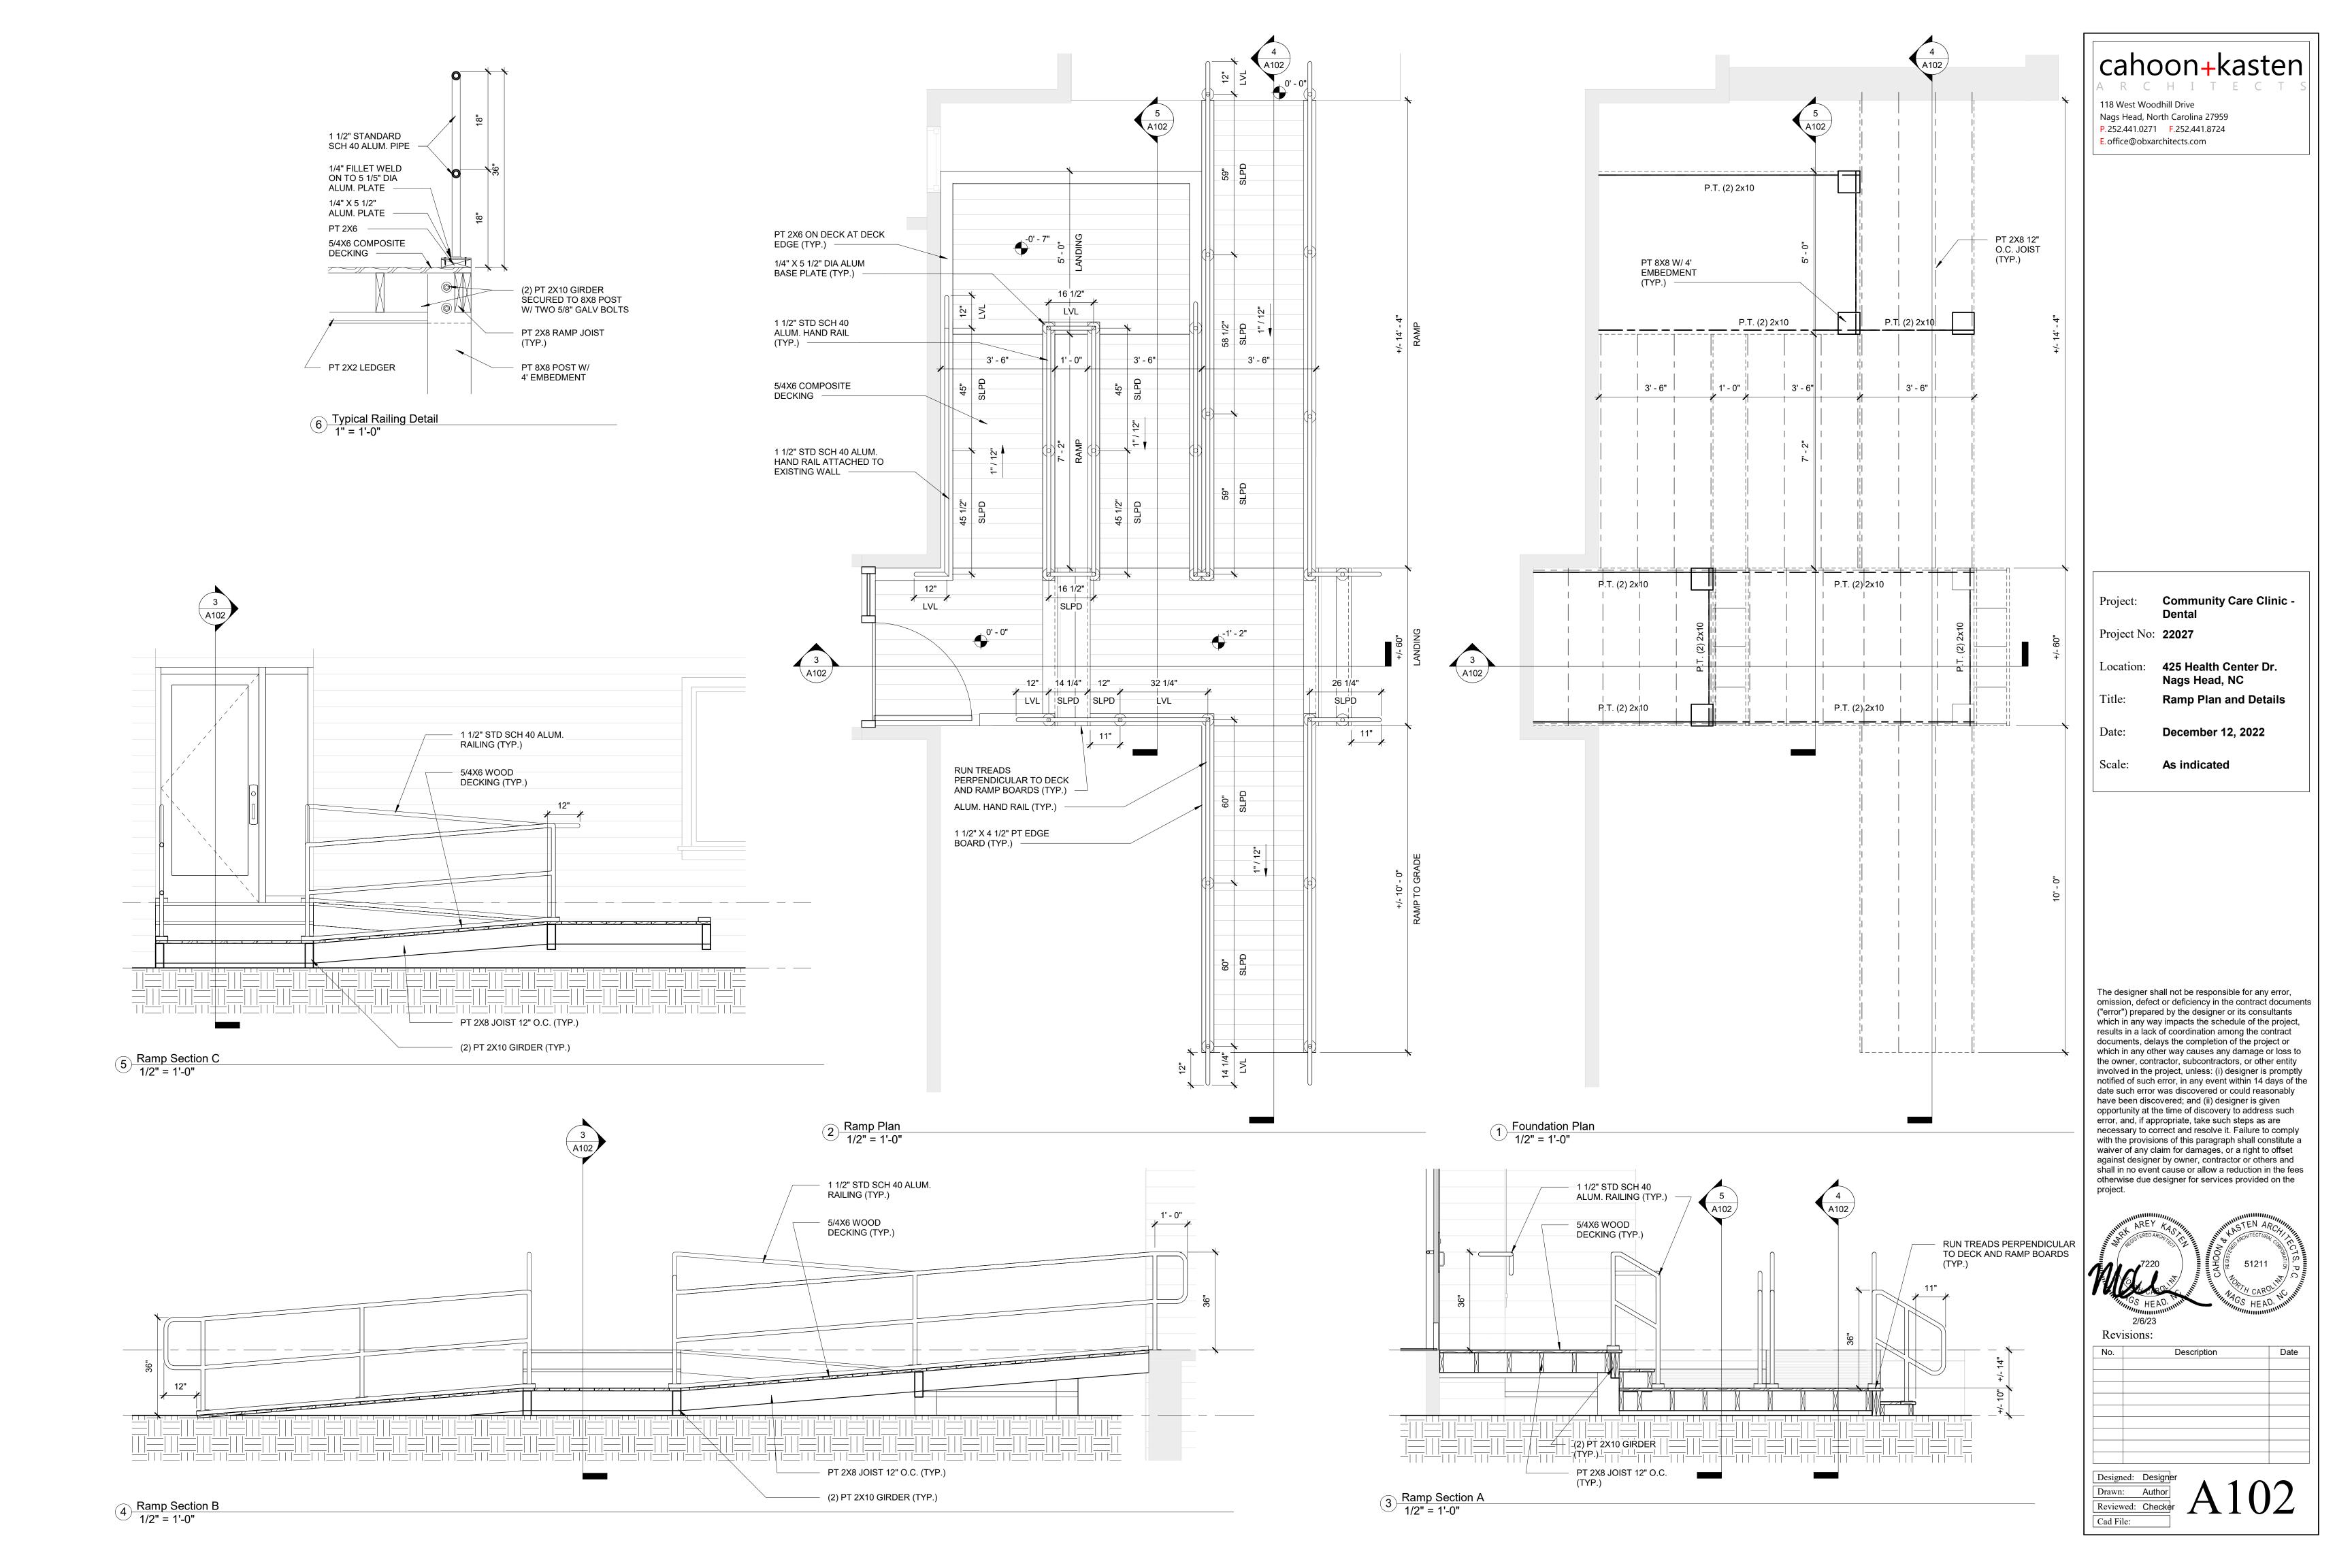


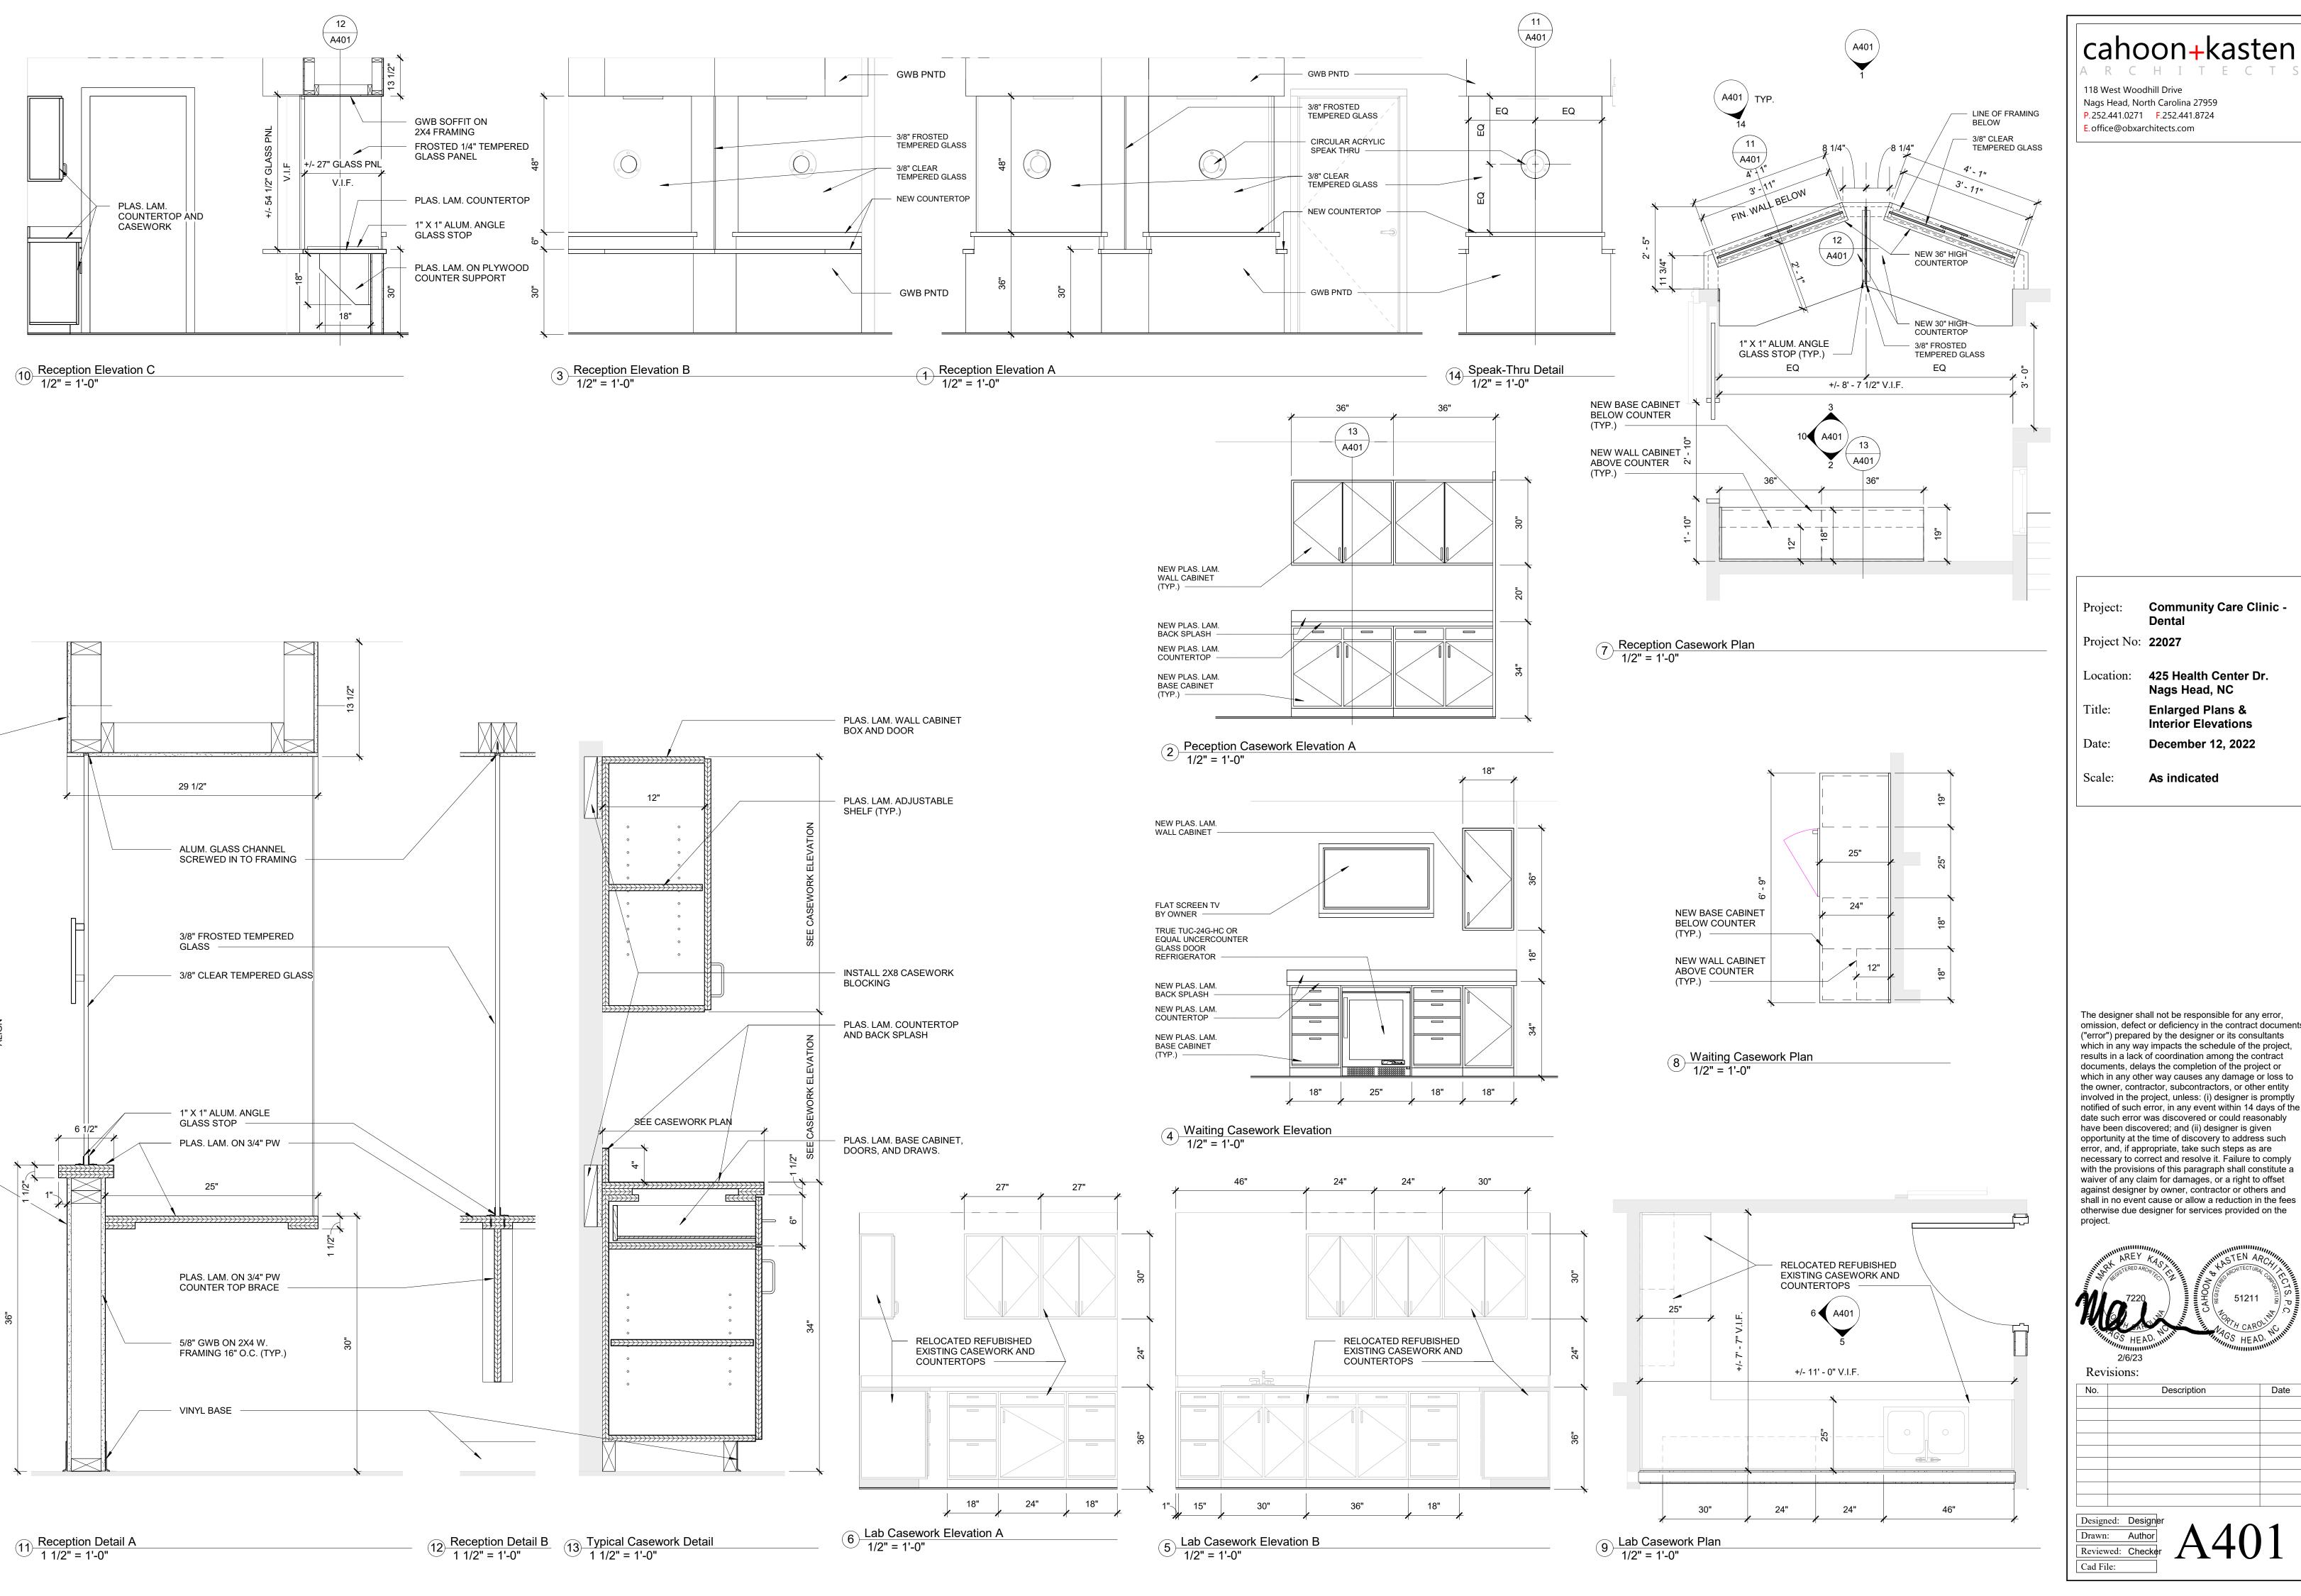


cahoon+kasten

Community Care Clinic -

omission, defect or deficiency in the contract documents ("error") prepared by the designer or its consultants involved in the project, unless: (i) designer is promptly notified of such error, in any event within 14 days of the

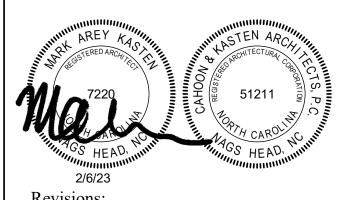

Date

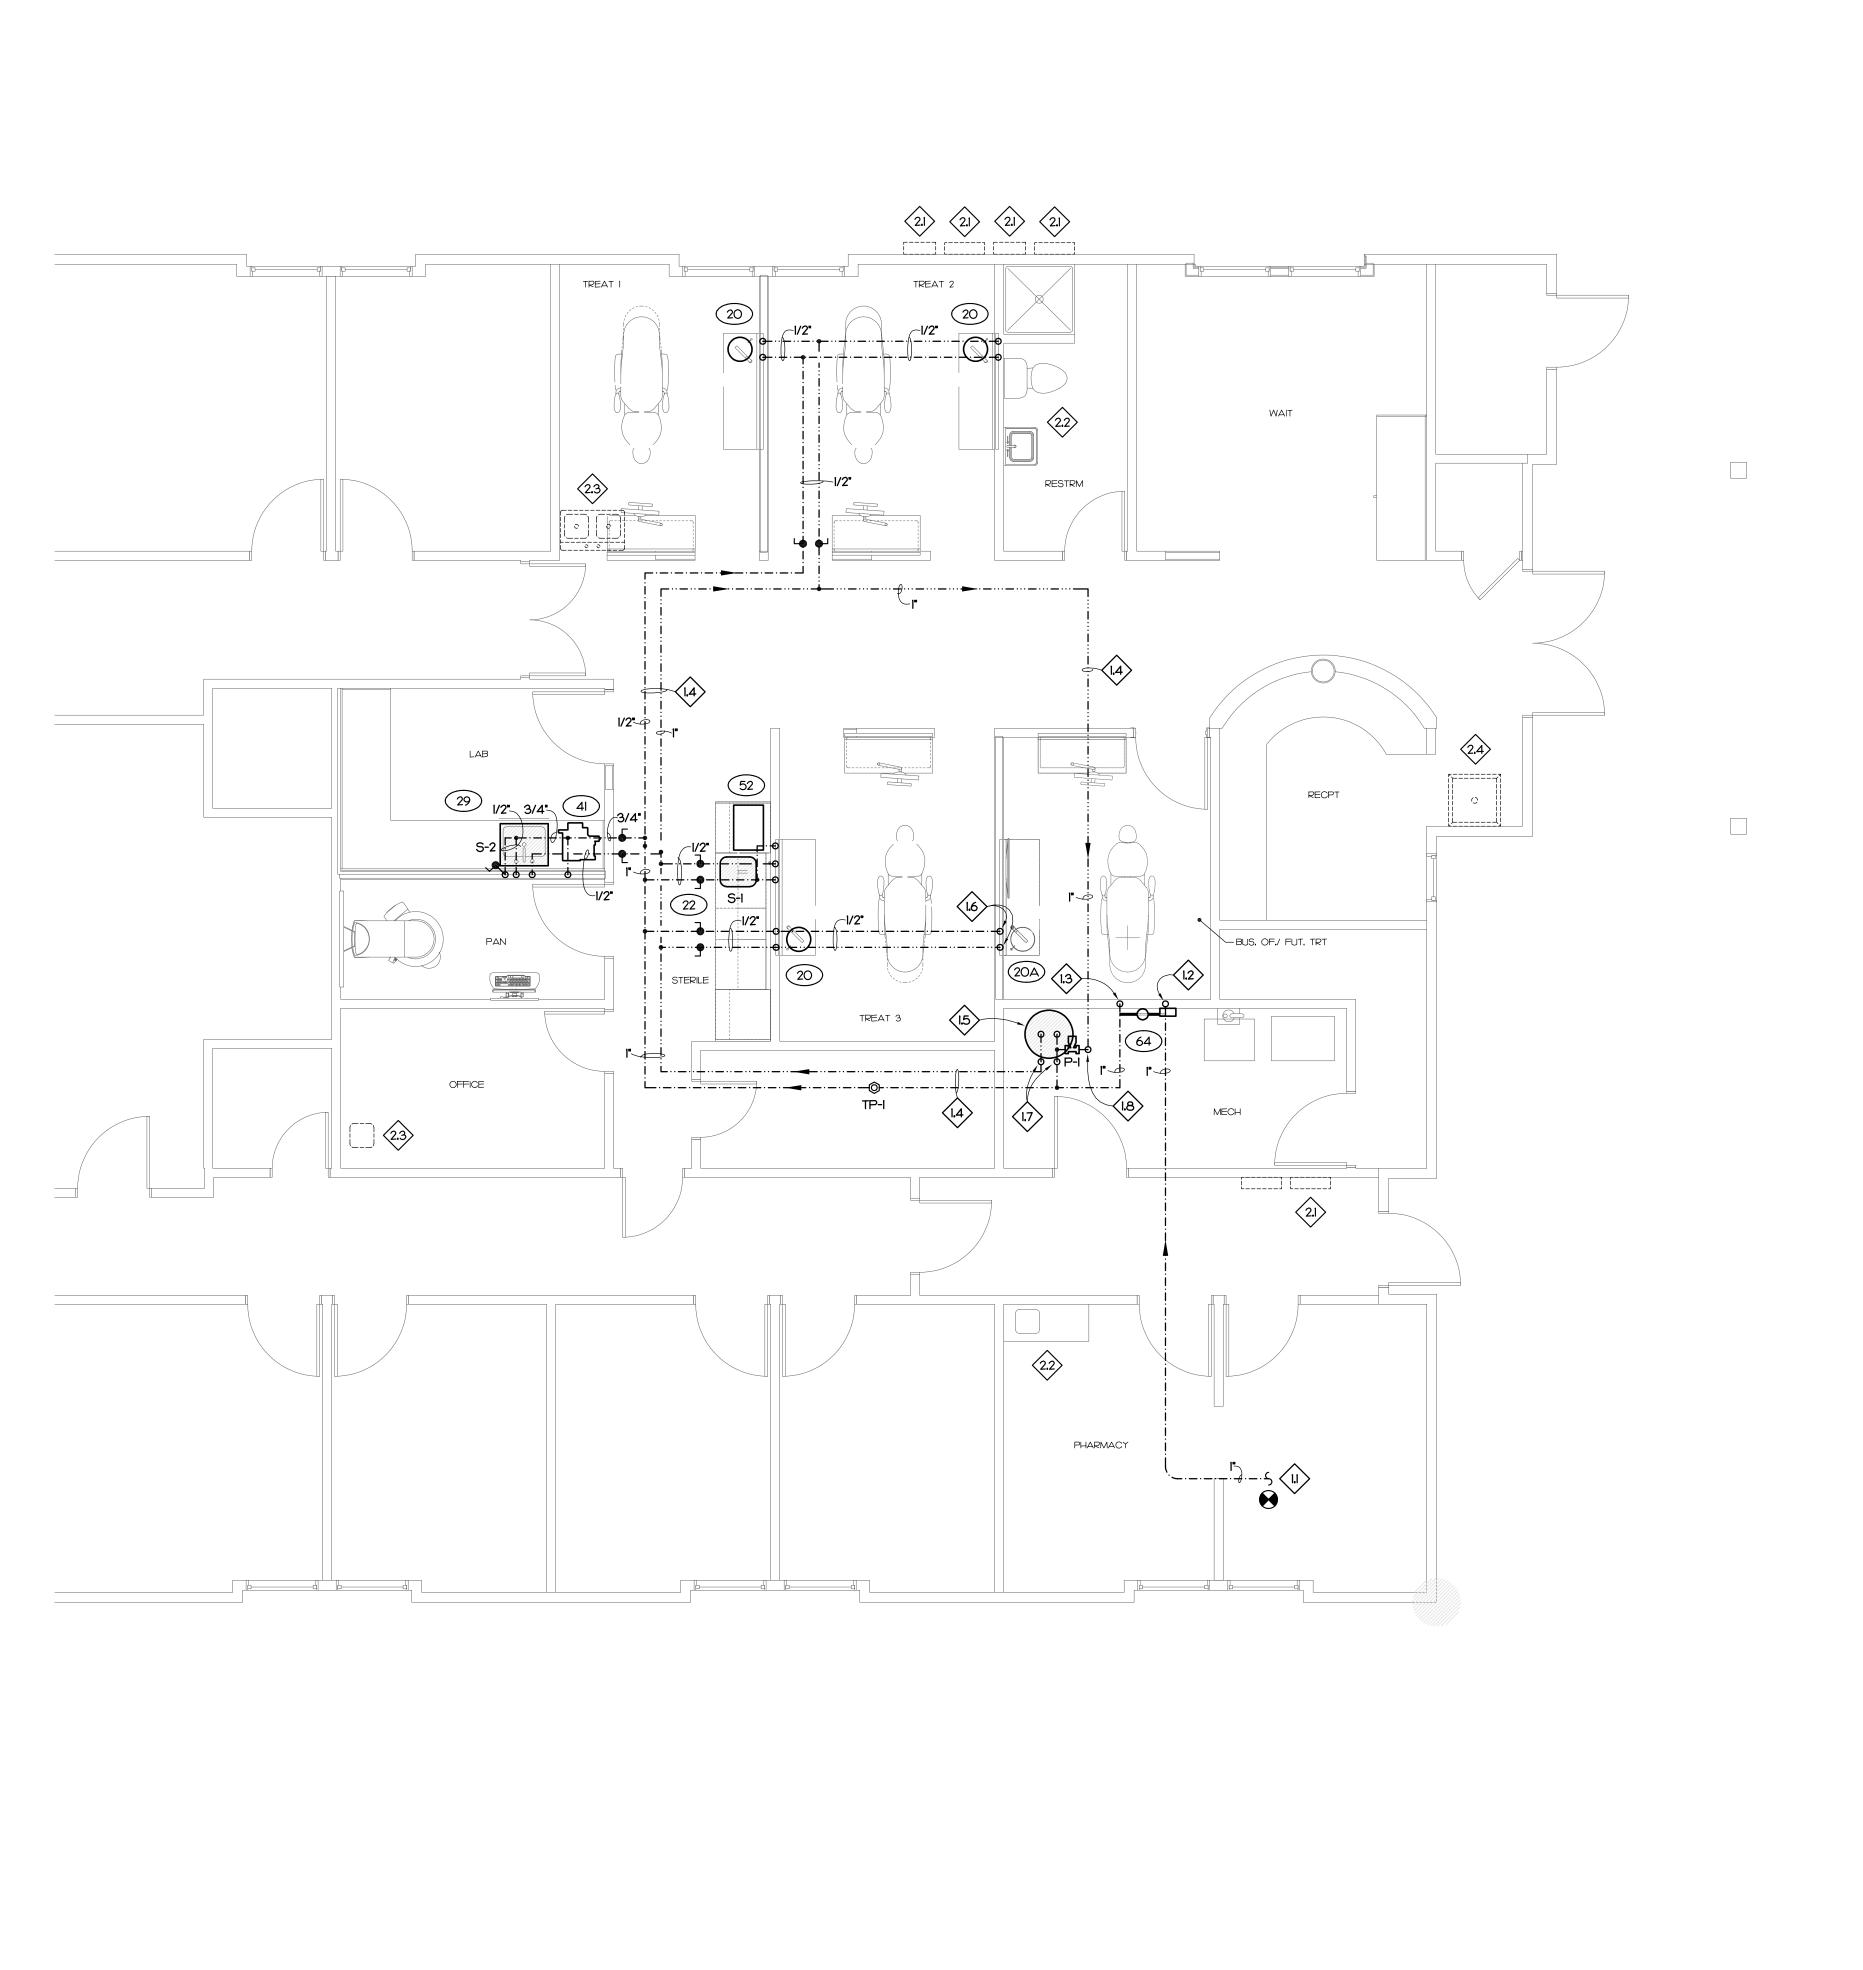

DENTAL EQUIPMENT SCHEDULE

ITEM	DESCRIPTION	C.W.	H.W.	S.S.	Α.	VA.	N ₂ O		NOTES					
II CIVI	DESCRIPTION	C.VV.	H.VV.	3,3,	А.	VA.		Ο ₂	1	2	3	4	5	
	DENTAL CHAIR				1/2"	1/2"								
(\underline{A})	FUTURE DENTAL CHAIR				1/2"	1/2"								
9	SIDE CABINET IN REAR LOCATION				1/2"									
(19A)	FUTURE SIDE CABINET IN REAR LOCATION				1/2"									
20	SIDE CABINET	1/2"	1/2"	1 1/2"	1/2"									
20A)	FUTURE SIDE CABINET	1/2"	1/2"	1 1/2"	1/2"									
22	STERILIZATION CABINET	1/2"	1/2"	1 1/2"	1/2"	1/2"								
29	LAB CABINETS	1/2"	1/2"	1 1/2"	1/2"									
40	PLASTER TRAP			1 1/2"										
41	MODEL TRIMMER	1/2"												
52	ULTRASONIC CLEANER	1/2"		1/2"						0		0		
60	COMPRESSOR				1/2"									
<u>6</u> 1	DRY VACUUM SYSTEM	1/2"		1 1/2"		2"				0		0		
63	AMALGAM SEPARATOR					2"						0		
(64)	WATER SHUT OFF WITH FILTER	X*		1 1/2"		2"								

S: ULL EQUIDMENT DIDECTLY CONNECTED TO THE WATER SYSTEM SHA

. ALL EQUIPMENT DIRECTLY CONNECTED TO THE WATER SYSTEM SHALL BE PROVIDED WITH A VACUUM BREAKER,

EXISTING RELOCATED

SUPPLIED BY PATTERSON DENTAL AND INSTALLED BY PATTTERSON DENTAL, PLUMBING CONTRACTOR TO MAKE CONNECTIONS AS REQUIRED.

SUPPLIED BY DOCTOR AND INSTALLED BY PATTERSON DENTAL, PLUMBING CONTRACTOR TO MAKE CONNECTIONS AS REQUIRED.

PLUMBING CONTRACTOR TO PROVIDE ALL VALVES, PIPING, VENTS, AND CONNECTIONS AS REQUIRED.

SUPPLIED BY GENERAL CONTRACTOR AND INSTALLED BY GENERAL CONTRACTOR, PLUMBING CONTRACTOR TO MAKE CONNECTIONS AS REQUIRED.

SUPPLIED BY PATTERSON DENTAL AND INSTALLED BY PLUMBING CONTRACTOR, PLUMBING CONTRACTOR TO MAKE CONNECTIONS AS REQUIRED.

PLUMBING KEY NOTES

CONNECT TO EXISTING COLD WATER LINE IN CRAWL SPACE. PLUMBING CONTRACTOR TO FIELD VERIFY LOCATION AND MAKE CONNECTION AS REQUIRED.

(1.2) RISE UP FROM CRAWL SPACE TO ITEM 64.

(1.3) RISE UP TO ABOVE FINISHED CEILING.

WATER PIPING ABOVE FINISHED CEILING, COORDINATE LOCATION WITH MECHANICAL AND ELECTRICAL CONTRACTORS.

(1.5) LOCATE WATER HEATER (WH-I) AND RECIRC, PUMP (P-I) IN ATTIC.

(1.6) STUB OUT AND CAP 1/2" COLD AND 1/2" HOT WATER FOR FUTURE SIDE CABINET.

(1.7) COLD AND HOT WATER PIPING TO AND FROM WATER HEATER IN ATTIC.

(1.8) HOT WATER RETURN UP TO WATER HEATER IN ATTIC.

(2.1) ELECTRICAL EQUIPMENT BY ELECTRICAL CONTRACTOR.

(2.2) NO WORK IN THIS AREA. EXISTING PLUMBING FIXTURES AND PIPING TO REMAIN.

2.3 REMOVE EXISTING SINK AND APPURTENANCES. CAP RELATED PIPING AS REQUIRED.


2.4 REMOVE EXISTING MOP SINK AND APPURTENANCES. CAP RELATED PIPING AS REQUIRED.

A R C H I T E C T S

118 West Woodhill Drive Nags Head, North Carolina 27959 P.252.441.0271F252.441.8724 E.office@obxarchitects.com



3221 BLUE RIDGE ROAD, SUITE 113 RALEIGH, NC 27612 (919) 571-1111 22218

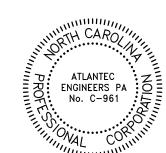



oject: Community Care Clinic -

Project No: 22027

Location: 425 Health Center Dr. Nags Head, NC

Title: Plumbing Plan

Date: 01.31.2023

cale: As indicated

WATER PIPING PLAN


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Revisions:

INO.	Description	Date

Designed: DRD
Drawn: DRD
Reviewed: JBD

P101

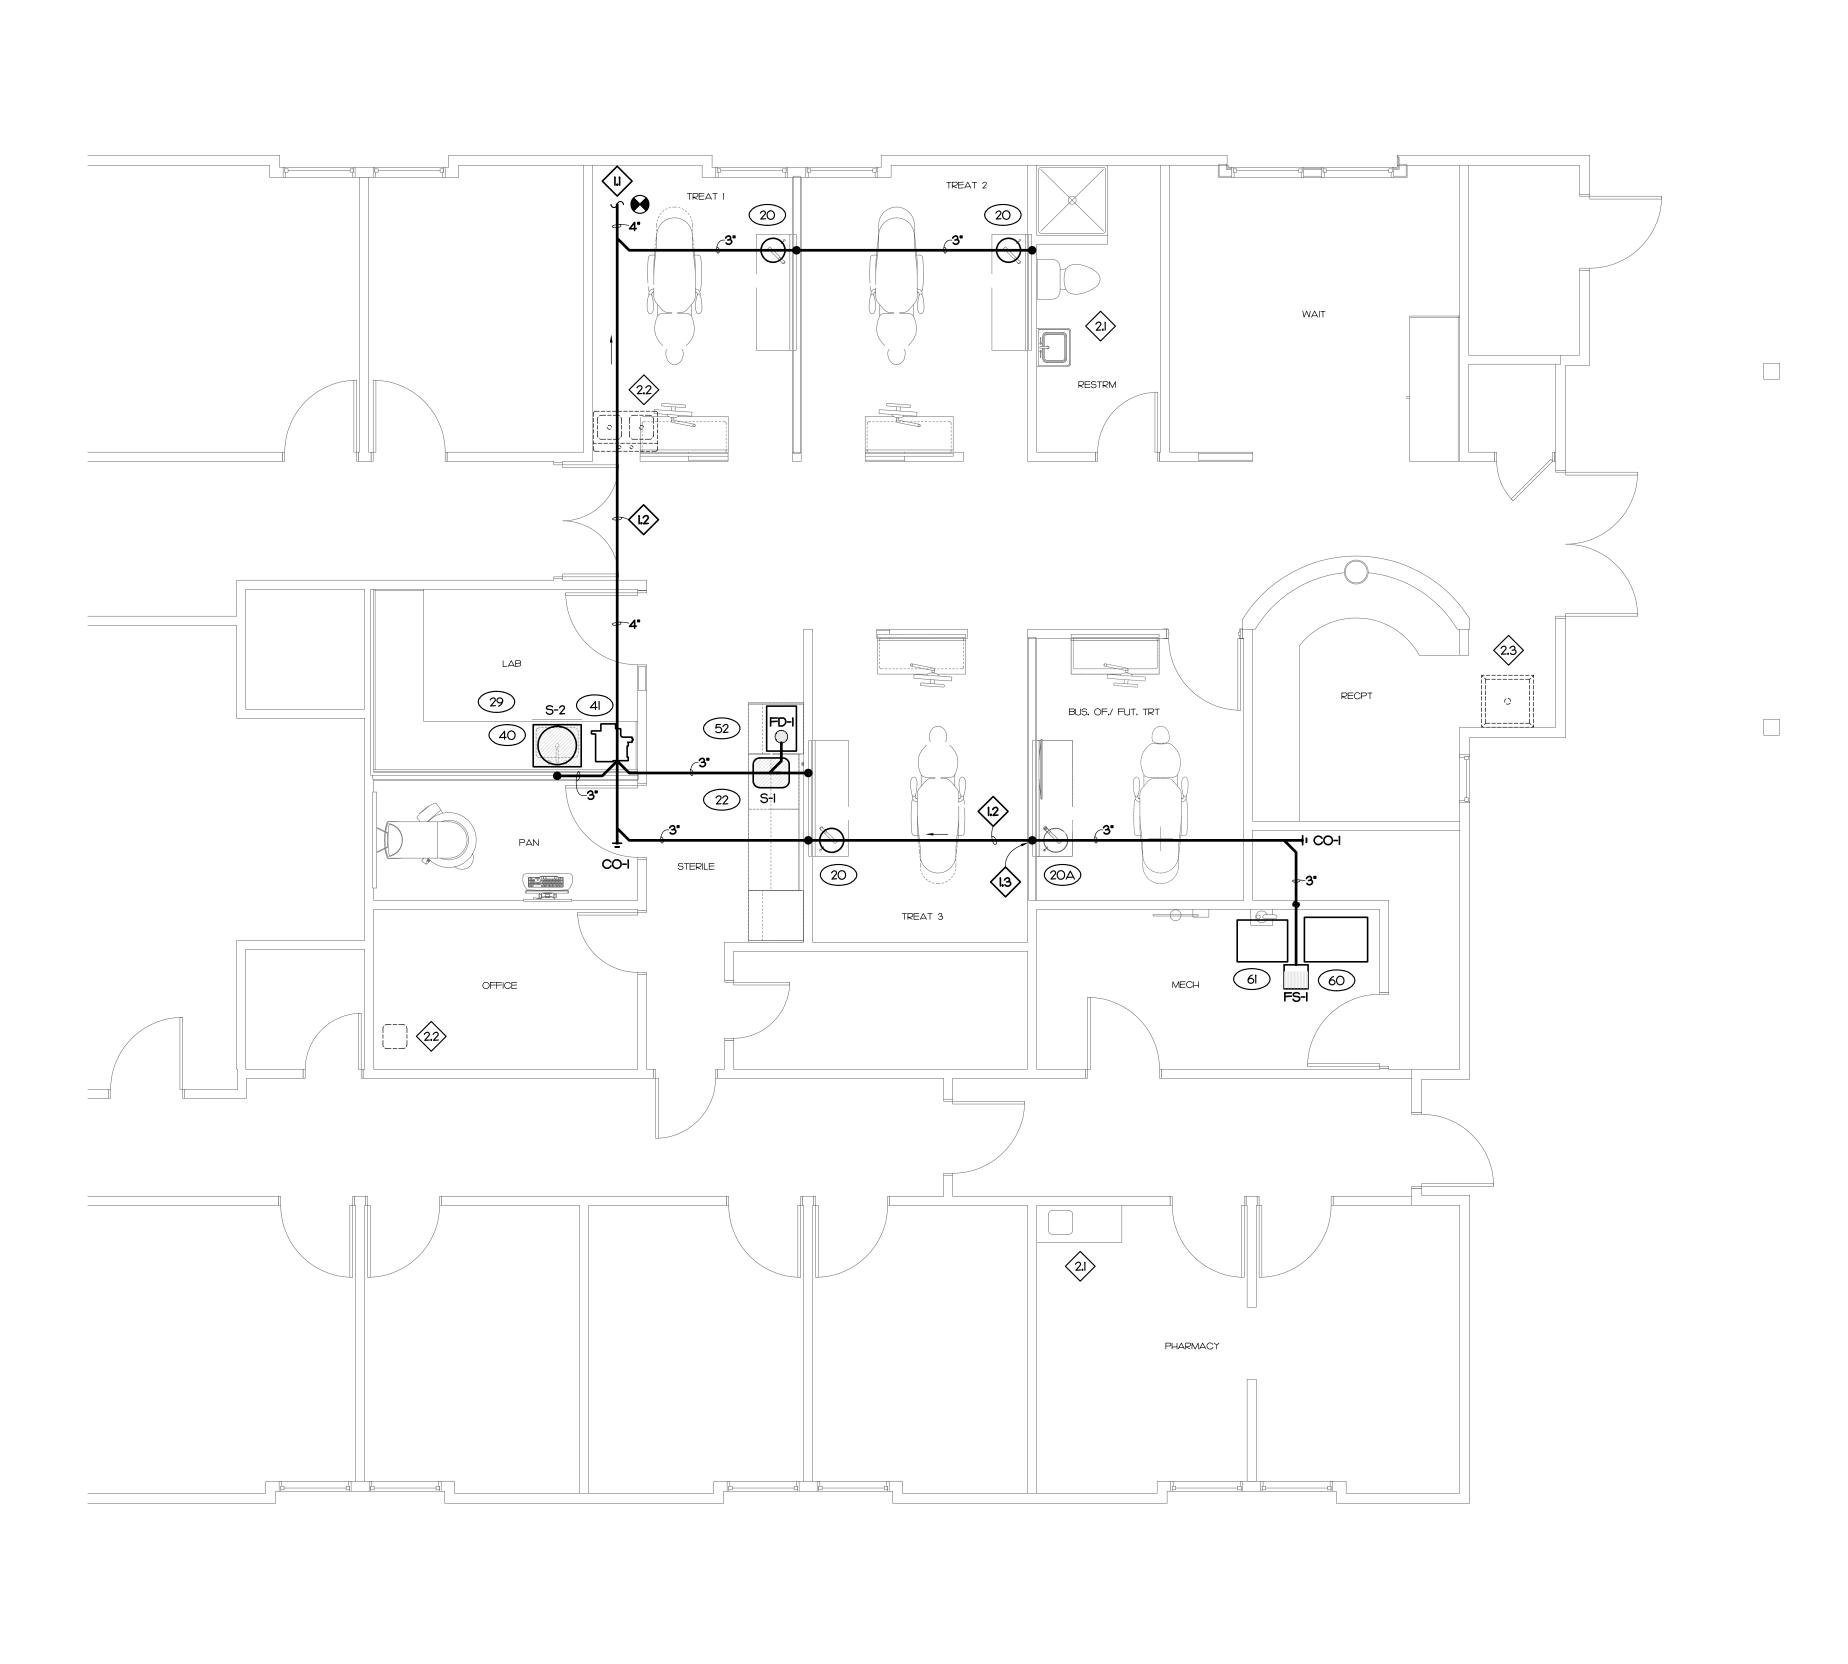

DENTAL EQUIPMENT SCHEDULE

ITEM	DESCRIPTION	C.W.	H.W.	S.S.	Α.	VA.	N O		NOTES						
I I CIVI	DESORIF HON	C.VV.	H.V V.	3,3,	А.	VA.	N ₂ O	O ₂	1	2	3	4	5		
	DENTAL CHAIR				1/2"	1/2"									
$\overline{(\overline{\mathbb{P}})}$	FUTURE DENTAL CHAIR				1/2"	1/2"									
19	SIDE CABINET IN REAR LOCATION				1/2"										
(19A)	FUTURE SIDE CABINET IN REAR LOCATION				1/2"										
20	SIDE CABINET	1/2"	1/2"	1 1/2"	1/2"										
20A)	FUTURE SIDE CABINET	1/2"	1/2"	1 1/2"	1/2"										
22	STERILIZATION CABINET	1/2"	1/2"	1 1/2"	1/2"	1/2"									
29	LAB CABINETS	1/2"	1/2"	1 1/2"	1/2"										
40	PLASTER TRAP			1 1/2"											
41	MODEL TRIMMER	1/2"													
52	ULTRASONIC CLEANER	1/2"		1/2"											
60	COMPRESSOR				1/2"										
<u>(61)</u>	DRY VACUUM SYSTEM	1/2"		1 1/2"		2"									
63	AMALGAM SEPARATOR					2"									
64	WATER SHUT OFF WITH FILTER	X"		1 1/2"		2"									

. ALL EQUIPMENT DIRECTLY CONNECTED TO THE WATER SYSTEM SHALL BE PROVIDED WITH A VACUUM BREAKER.

EXISTING RELOCATED

SUPPLIED BY PATTERSON DENTAL AND INSTALLED BY PATTTERSON DENTAL. PLUMBING CONTRACTOR TO MAKE

SUPPLIED BY DOCTOR AND INSTALLED BY PATTERSON DENTAL, PLUMBING CONTRACTOR TO MAKE CONNECTIONS AS REQUIRED.

PLUMBING CONTRACTOR TO PROVIDE ALL VALVES, PIPING, VENTS, AND CONNECTIONS AS REQUIRED.

SUPPLIED BY GENERAL CONTRACTOR AND INSTALLED BY GENERAL CONTRACTOR, PLUMBING CONTRACTOR TO MAKE CONNECTIONS AS

SUPPLIED BY PATTERSON DENTAL AND INSTALLED BY PLUMBING CONTRACTOR, PLUMBING CONTRACTOR TO MAKE CONNECTIONS AS REQUIRED.

PLUMBING KEY NOTES

CONNECT TO EXISTING WASTE LINE IN THE CRAWL SPACE, PLUMBING CONTRACTOR TO FIELD VERIFY LOCATION, INVERT ELEVATION, AND MAKE CONNECTION AS REQUIRED.

(12) SANITARY SEWER PIPE BELOW FINISHED FLOOR.

(1.3) STUB AND CAP 2" WASTE LINE FOR FUTURE SIDE CABINET.

(2.1) NO WORK IN THIS AREA. EXISTING PLUMBING FIXTURES AND PIPING TO REMAIN.

(2.2) REMOVE EXISTING SINK AND APPURTENANCES. CAP RELATED PIPING AS REQUIRED.

(2.3) REMOVE EXISTING MOP SINK AND APPURTENANCES, CAP RELATED PIPING AS REQUIRED.

118 West Woodhill Drive Nags Head, North Carolina 27959 P.252.441.0271F252.441.8724 E.office@obxarchitects.com



3221 BLUE RIDGE ROAD, SUITE 113 RALEIGH, NC 27612 (919) 571-1111 22218



Community Care Clinic -Project:

Project No: 22027

Location: 425 Health Center Dr. Nags Head, NC

Plumbing Plan

01.31.2023

As indicated


WASTE PIPING PLAN

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Revisions:

Description

WASTE PIPING PLAN

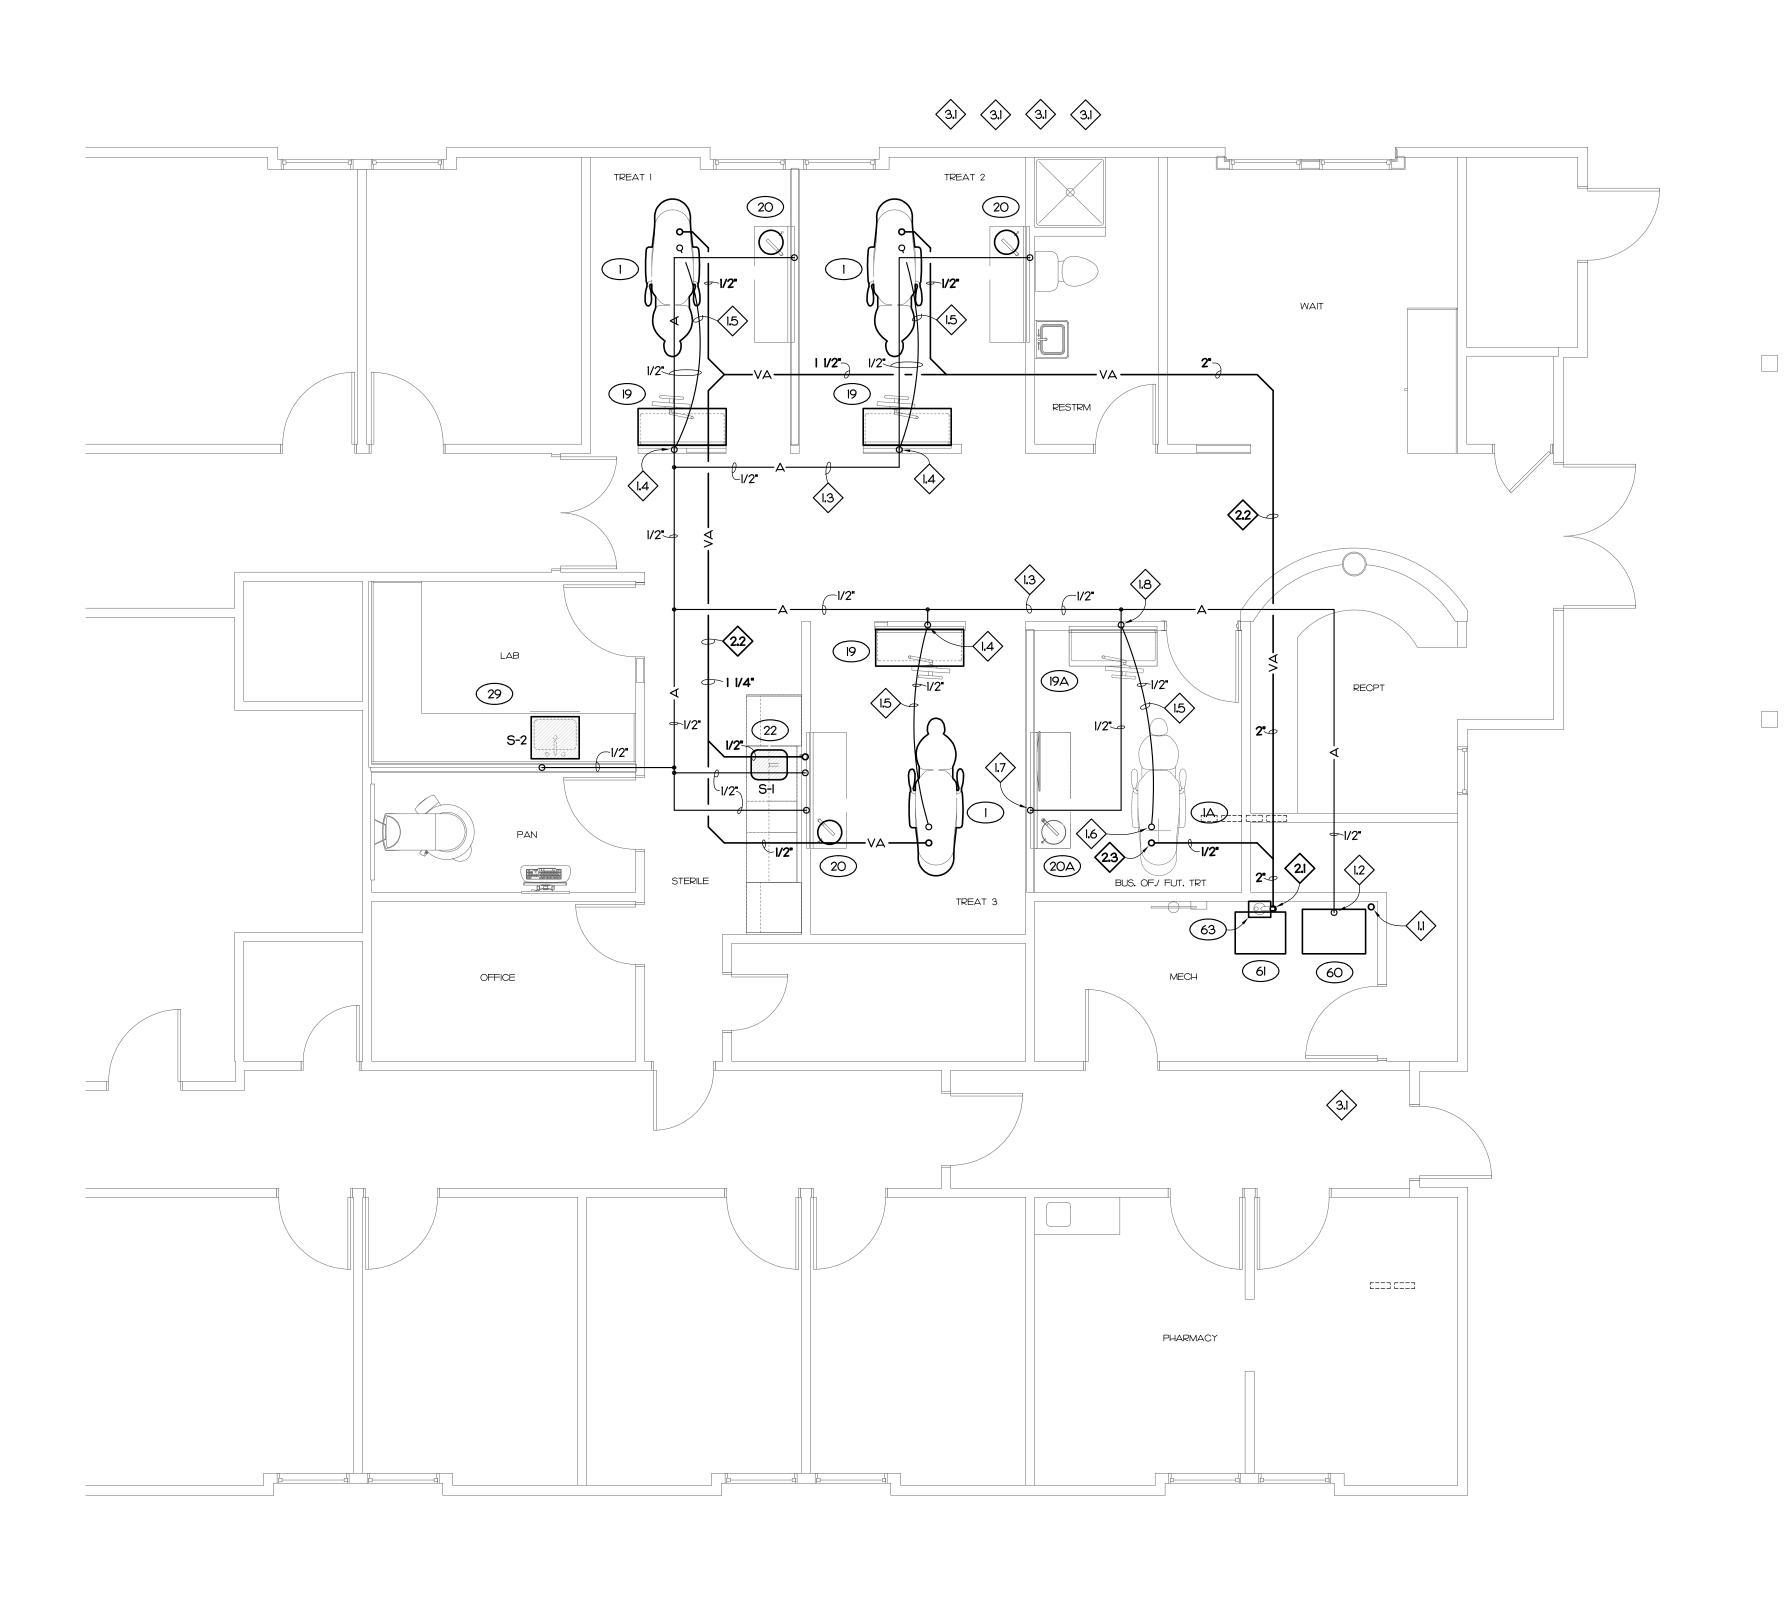

DENTAL EQUIPMENT SCHEDULE

ITEM	DESCRIPTION	C.W.	H.W.	S.S.	Α.	VA.	N ₂ O		NOTES					
11 🗆 🗸	DESCRIPTION	C.VV.	H.VV.	3.3.	ά.	VA.	1420	O ₂	1	2	3	4	5	
$\overline{\left(-\right) }$	DENTAL CHAIR				1/2"	1/2"								
(\underline{A})	FUTURE DENTAL CHAIR				1/2"	1/2"								
9	SIDE CABINET IN REAR LOCATION				1/2"									
(19A)	FUTURE SIDE CABINET IN REAR LOCATION				1/2"									
20	SIDE CABINET	1/2"	1/2"	1 1/2"	1/2"									
20A)	FUTURE SIDE CABINET	1/2"	1/2"	1 1/2"	1/2"									
22	STERILIZATION CABINET	1/2"	1/2"	1 1/2"	1/2"	1/2"								
29	LAB CABINETS	1/2"	1/2"	1 1/2"	1/2"									
40	PLASTER TRAP			1 1/2"										
41	MODEL TRIMMER	1/2"												
52	ULTRASONIC CLEANER	1/2"		1/2"										
60	COMPRESSOR				1/2"									
6	DRY VACUUM SYSTEM	1/2"		1 1/2"		2"								
63	AMALGAM SEPARATOR					2"								
64)	WATER SHUT OFF WITH FILTER	Χ"		1 1/2"		2"								

I. ALL EQUIPMENT DIRECTLY CONNECTED TO THE WATER SYSTEM SHALL BE PROVIDED WITH A VACUUM BREAKER.

EXISTING RELOCATED

SUPPLIED BY PATTERSON DENTAL AND INSTALLED BY PATTTERSON DENTAL. PLUMBING CONTRACTOR TO MAKE

PLUMBING CONTRACTOR TO PROVIDE ALL VALVES, PIPING, VENTS, AND CONNECTIONS AS REQUIRED.

SUPPLIED BY PATTERSON DENTAL AND INSTALLED BY PLUMBING CONTRACTOR, PLUMBING CONTRACTOR TO MAKE CONNECTIONS AS REQUIRED.

PLUMBING KEY NOTES

(I.I) 2" PVC AIR INTAKE TO EXTERIOR. PROVIDE WITH RAIN PROTECTION.

(1,2) ROUTE AIR PIPE UP TO ABOVE FINISHED CEILING.

(1.3) LOCATE AIR PIPE ABOVE FINISHED CEILING. COORDINATE LOCATION WITH MECHANICAL AND ELECTRICAL CONTRACTORS.

(1.4) DROP AIR PIPE DOWN BELOW FINISHED FLOOR.

(1.5) ROUTE AIR PIPE BELOW FINISHED FLOOR.

(1.6) STUB AND CAP AIR PIPE FOR FUTURE DENTAL CHAIR (ITEM IA).

STUB AND CAP AIR PIPE FOR FUTURE SIDE CABINET (ITEM 20A).

(I.8) STUB AND CAP AIR PIPE FOR FUTURE SIDE CABINET IN REAR LOCATION (ITEM 19A).

(2.1) ROUTE VACUUM PIPE DOWN TO BELOW FINISHED FLOOR IN CRAWL SPACE.

(2.2) LOCATE VACUUM PIPING BELOW FINISHED FLOOR IN CRAWL SPACE.

(2.3) STUB UP AND CAP VACUUM PIPING FOR FUTURE DENTAL CHAIR (ITEM IA).


(3.1) ELECTRICAL EQUIPMENT BY ELECTRICAL CONTRACTOR.

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3221 BLUE RIDGE ROAD, SUITE 113 RALEIGH, NC 27612 (919) 571-1111





Community Care Clinic -

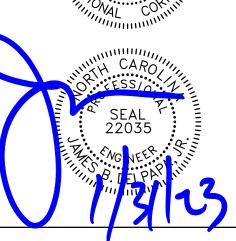Project No: 22027

Location: 425 Health Center Dr. Nags Head, NC

Plumbing Plan

01.31.2023

As indicated

COMPRESSED AIR AND VACUUM PIPING PLAN

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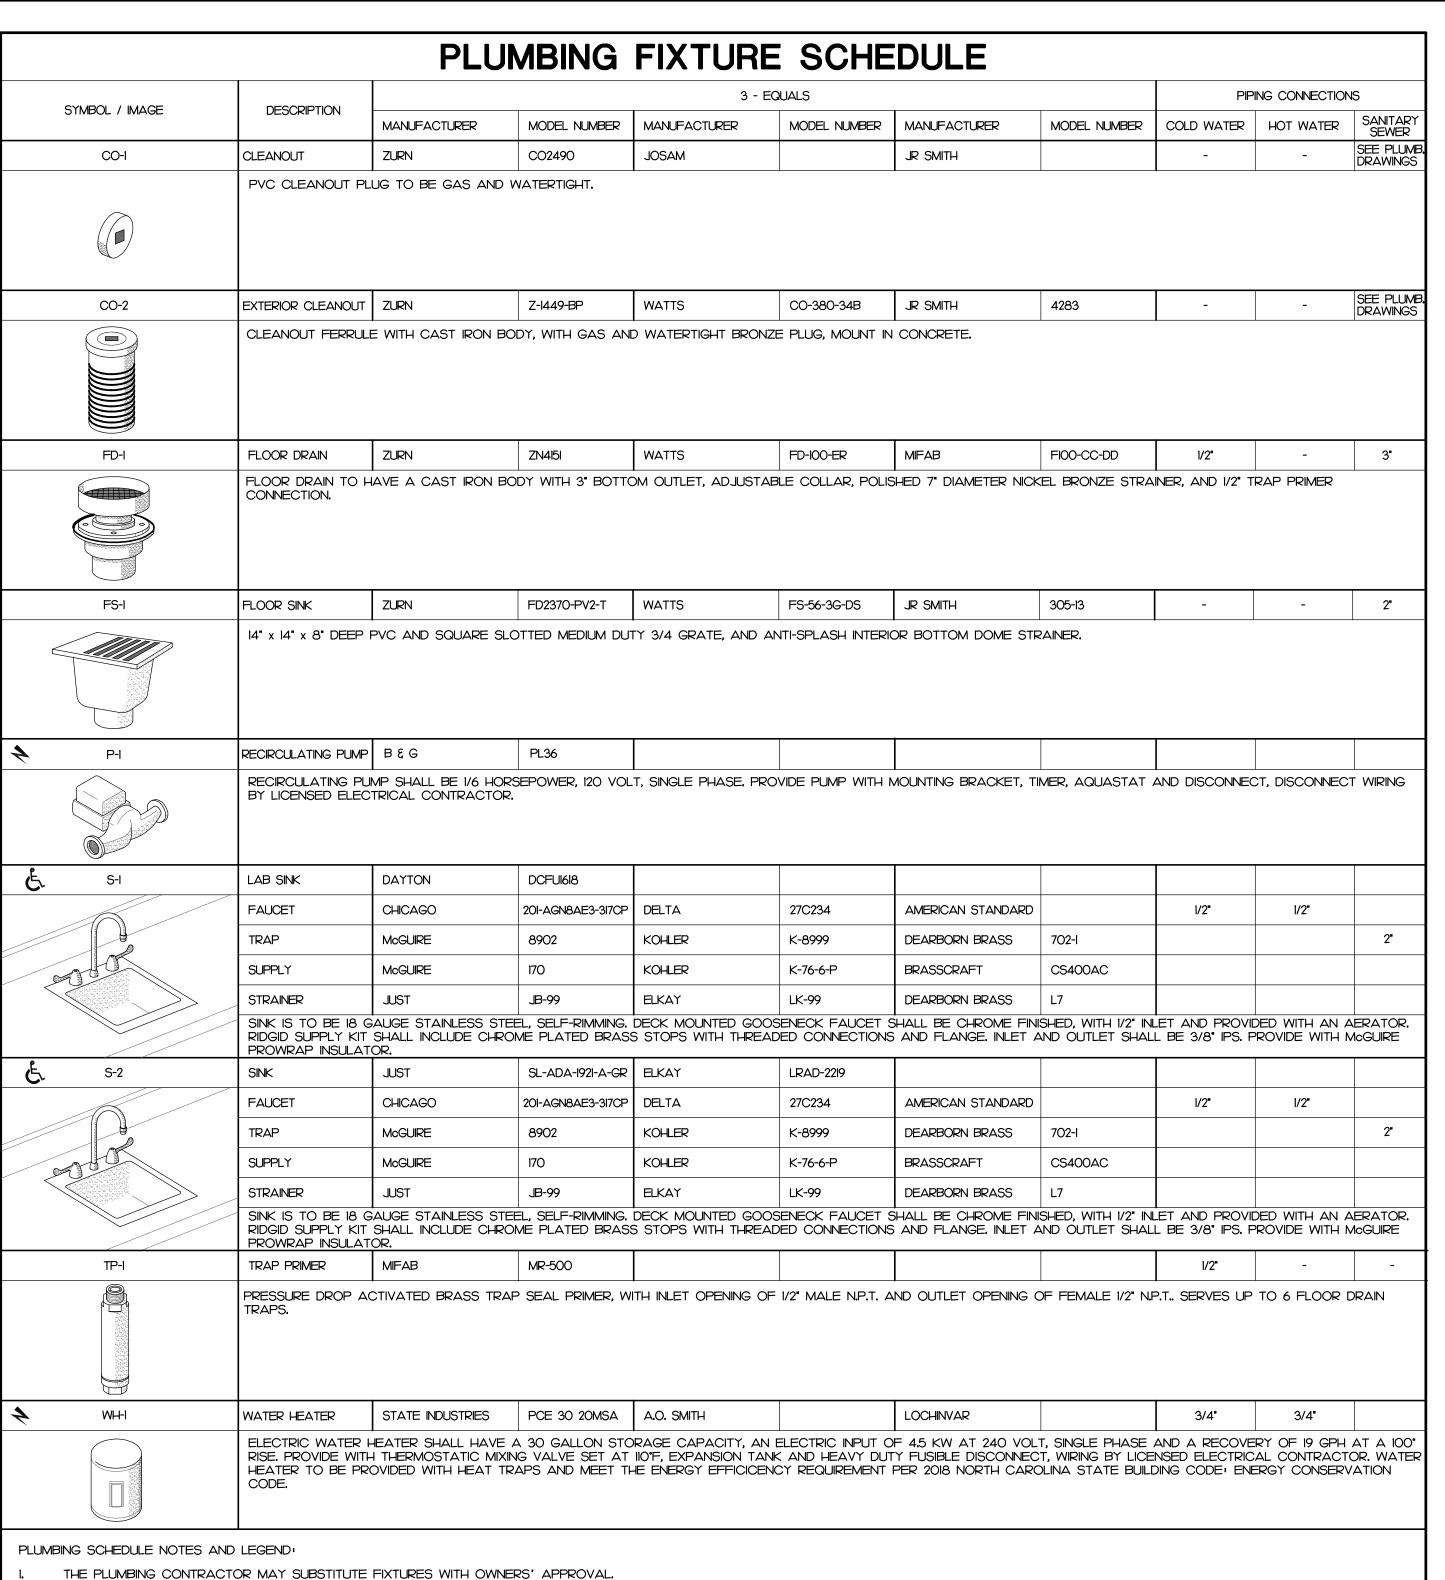
Revisions:

Description

Reviewed: JBD


COMPRESSED AIR AND VACUUM PIPING PLAN

SCALE: 1/4" = 1'-0"



TO BE 2" UNLESS NOTED OTHERWISE.

ALL VENT PIPING IS

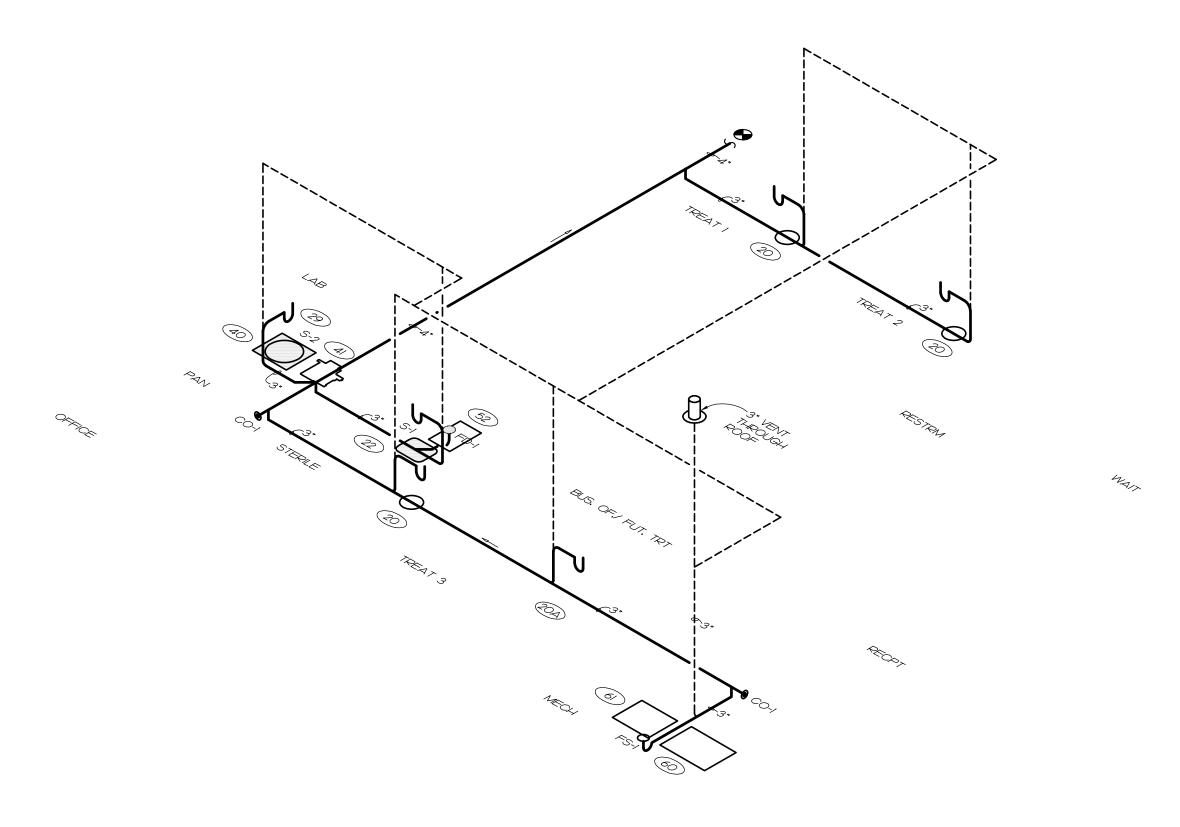

118 West Woodhill Drive

Nags Head, North Carolina 27959 P.252.441.0271F.252.441.8724 E.office@obxarchitects.com

MTLANTEC .

3221 BLUE RIDGE ROAD, SUITE 113 RALEIGH, NC 27612 (919) 571-1111 22218



Project: Community Care Clinic -

Project No: 22027

Location: 425 Health Center Dr. Nags Head, NC

Plumbing Plan

01.31.2023

As indicated

PLUMBING FIXTURE SCHEDULE AND WASTE PIPING RISER

WASTE PIPING RISER

The designer shall not be responsible for any error, omission, defect or deficiency in the contract documents ("error") prepared by the designer or its consultants which in any way impacts the schedule of the project, results in a lack of coordination among the contract documents, delays the completion of the project or which in any other way causes any damage or loss to the owne contractor, subcontractors, or other entity involved in the project, unless: (i) designer is promptly notified of such error, in any event within 14 days of the date such error was discovered or could reasonably have been discovered; and (ii) designer is given opportunity at the time of discovery to address such error, and, if appropriate, take such steps as are necessary to correct and resolve it. Failure to comply with the provisions of this paragraph shall constitute a waiver of any claim for damages, or a right to offset against designer by owner, contractor or others and shall in no event cause or allow a reduction in the fees otherwise due designer for services provided on the project.

Revisions:

Description

Reviewed: JBD

Cad File:


2. SUBMIT CUT SHEETS FOR ALL PROPOSED FIXTURES TO ARCHITECT PRIOR TO BIDDING.


REFER TO MANUFACTURERS WEB SITE FOR CUT SHEETS AND DATA ON THE FIXTURES AND APPURTENANCES USED IN THIS SCHEDULE.

PROVIDE VACUUM BREAKER ON ALL EQUIPMENT REQUIRING PLUMBING.

ADA COMPLIANT

ELECTRICAL POWER

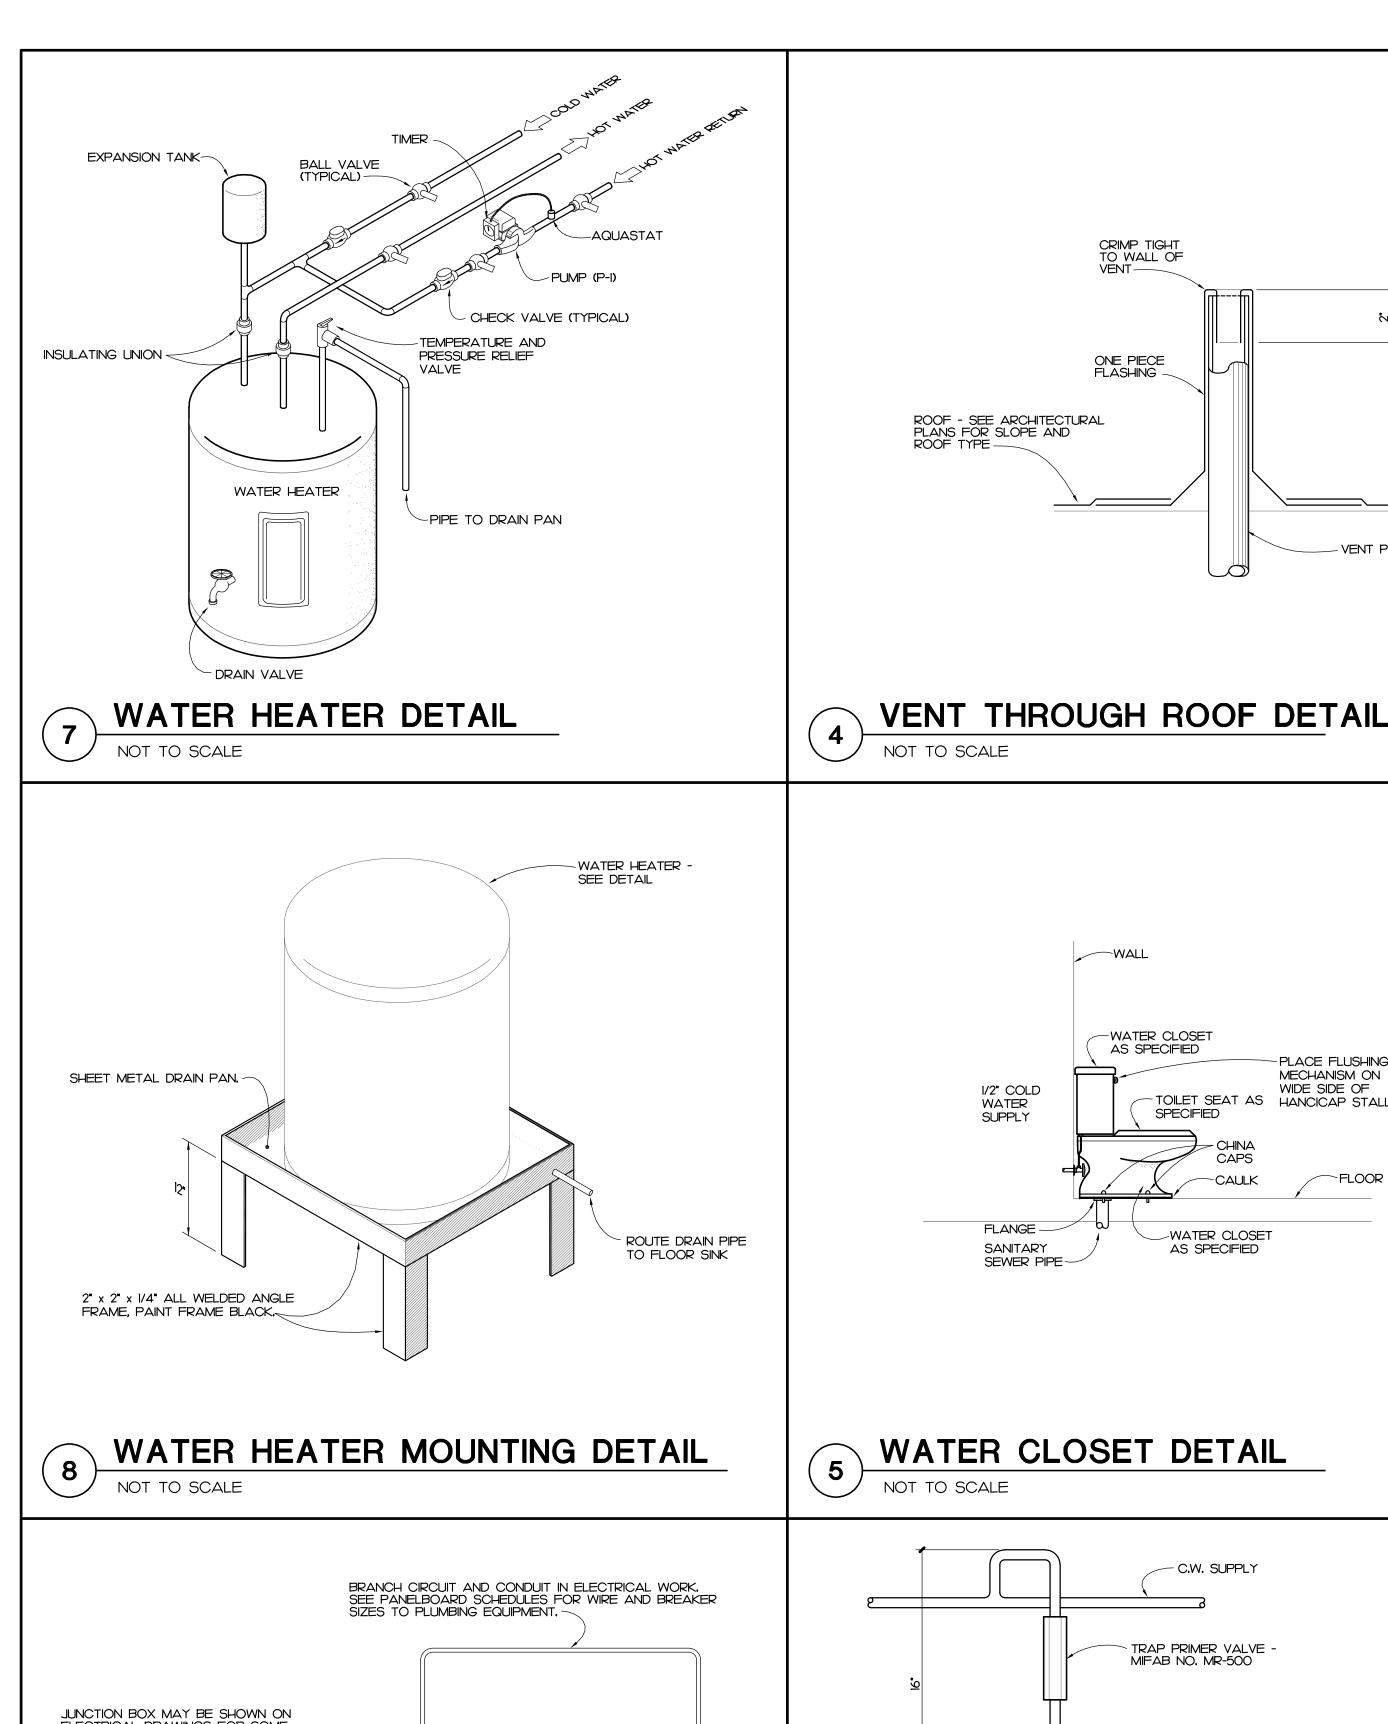

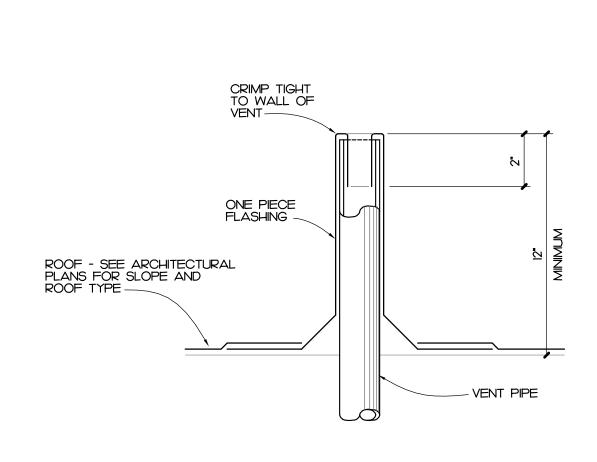

-WATER CLOSET AS SPECIFIED

SPECIFIED

-WATER CLOSET

AS SPECIFIED

1/2" COLD

FLANGE -

SANITARY

NOT TO SCALE

SEWER PIPE-

WATER

MECHANISM ON


WIDE SIDE OF

TOILET SEAT AS HANCICAP STALL


COUNTERSUNK PLUG 18" x 18" x 6" THICK CONCRETE PAD FLUSH WITH GRADE BY PLUMBING CONTRACTOR CLEANOUT FLUSH WITH CONCRETE -SEE PLUMBING FIXTURE SCHEDULE COMBINATION WYE AND 1/8 BEND NOTE: SEE SITE AND/OR UTILITY PLAN FOR LOCATION AND FINISH GRADE ELEVATION

EXTERIOR CLEANOUT DETAIL

NOT TO SCALE

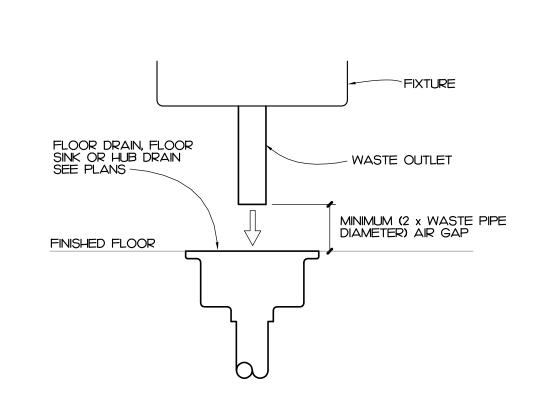

AIR GAP DETAIL

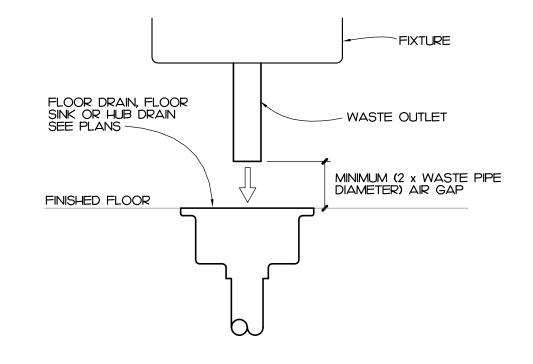

PLUMBING GENERAL NOTES

- I. ALL WORK SHALL BE DONE IN ACCORDANCE WITH THE LATEST EDITION OF THE STATE CODE, ALL LOCAL AND OTHER APPLICABLE CODES.
- 2. ANY PERMITS AND INSPECTION FEES SHALL BE SECURED AND PAID FOR BY THE PLUMBING CONTRACTOR.
- 3. ALL WORK SHALL BE PERFORMED BY EXPERIENCED AND SKILLED CRAFTSMAN, THE PLUMBING
- CONTRACTOR SHALL COORDINATE ALL OF HIS WORK WITH ALL OTHER CONTRACTORS. 4. THE PLUMBING PLANS AND SPECIFICATIONS SHALL BE THOROUGHLY REVIEWED PRIOR TO PURCHASING MATERIALS AND INSTALLATION, ALL DISCREPANCIES OR INTERFERENCE'S SHALL BE BROUGHT TO THE
- 5. THESE PLANS ARE DIAGRAMMATIC AND MAY NOT SHOW MINOR DETAILS AND LOCATIONS. FOR DIMENSIONS,
- REFER TO THE ARCHITECTURAL PLANS.
- 6. THE PLUMBING CONTRACTOR SHALL PROVIDE ALL OPENINGS REQUIRED FOR THE PLUMBING WORK, THE PATCHING SHALL BE BY THE PLUMBING CONTRACTOR AND FINISHING BY GENERAL CONTRACTOR. WATER PIPING BELOW GRADE AND ABOVE GRADE SHALL BE PEX (NO JOINTS BELOW GRADE). SUPPORTED
- AS REQUIRED AND SHALL BE HYDROSTATICALLY TESTED FOR ONE HOUR AT 150 PSI. TEST TO COMPLY WITH ALL EPA STANDARDS. THE ENTIRE WATER DISTRIBUTION SYSTEM SHALL BE DISINFECTED PRIOR TO
- 8. ALL PIPE, FITTINGS, FIXTURES, AND SOLDER TO BE LEAD FREE.
- 9. WATER PIPING LOCATED ABOVE CEILINGS AND IN EXTERIOR WALLS SHALL BE ROUTED ON HEATED SIDE OF CEILING INSULATION (UNDERSIDE) AND WALL INSULATION (INSIDE).
- 10. ALL COLD AND HOT WATER PIPING SHALL BE INSULATED. INSULATE WASTE PIPING AS DESIGNATED ON PLUMBING DRAWINGS. INSULATION SHALL BE I" FIBERGLASS, EXPOSED PIPING TO BE WRAPPED WITH
- II. DO NOT SUPPORT PIPING FROM BAR JOIST BRIDGING AND/OR ROOF DECK.
- 12. WATER SHUT OFF VALVES ABOVE FINISHED CEILING ARE TO BE FREE FROM OBSTRUCTIONS SUCH AS DUCTWORK, LIGHTS, WIRING AND OTHER PIPING SO AS TO PROVIDE EASY ACCESS. MOUNT NO MORE THAN 2'-0" ABOVE FINISHED CEILING.
- 13. IF THE WATER PRESSURE EXCEEDS 80 PSI A PRESSURE REDUCING VALVE SHALL BE INSTALLED WHERE THE WATER ENTERS THE BUILDING.
- 14. PLUMBING CONTRACTOR SHALL PROVIDE A DIELECTRIC UNION WHEN CONNECTING DISSIMILAR MATERIAL.
- 15. WATER HEATERS SHALL HAVE AND EFFICIENCY MEETING REQUIREMENTS OF THE NORTH CAROLINA BUILDING CODE.
- 16. THE PLUMBING CONTRACTOR SHALL BE RESPONSIBLE FOR ALL ELECTRICAL AND CONTROL CONNECTIONS TO THE EQUIPMENT FURNISHED UNDER HIS CONTRACT.
- SANITARY SEWER AND VENT PIPING SHALL BE SCHEDULE 40 PVC. CELLULAR CORE (FOAM CORE) IS NOT ALLOWED, SANITARY SEWER AND VENT PIPING SHALL BE GAS AND AIR TIGHT.
- 18. THE PLUMBING CONTRACTOR SHALL COORDINATE ALL WORK WITH OTHER TRADES PRIOR TO INSTALLATION
- 19. THE PLUMBING CONTRACTOR SHALL REVIEW ALL UTILITY SITE PLANS FOR WORK BY OTHERS, IT SHALL BE THE RESPONSIBILITY OF THE CONTRACTOR TO COORDINATE HIS WORK WITH WORK BY OTHERS AND AVOID ALL CONFLICTS.
- 20. LOCATIONS OF UTILITIES (WASTE AND WATER PIPING, ETC...) PROVIDED BY OTHERS, THAT ARE TO BE CONNECTED TO ARE ASSUMED. IT SHALL BE THE RESPONSIBILITY OF THE PLUMBING CONTRACTOR TO VERIFY THESE LOCATIONS AND MAKE FINAL CONNECTIONS AS REQUIRED.
- 21. VERIFY THE LOCATION OF ALL EQUIPMENT SUPPLIED BY OTHERS.

REAR OF BUILDING.

- 22. COMPRESSED AIR PIPING SHALL BE 1/2" COPPER AND TESTED AT 150 PSI FOR 24 HOURS.
- 23. VACUUM PIPING SHALL BE PVC WITH RADIUS SWEEP ELBOWS. SLOPE PIPING TOWARDS VACUUM PUMP.
- 24. PROVIDE VACUUM BREAKERS ON ALL EQUIPMENT DIRECTLY CONNECTED TO THE WATER SYSTEM.
- 25. THE PLUMBING CONTRACTOR SHALL REFER TO THE DENTAL CONSULTANT FOR EXACT DIMENSIONS AND LOCATIONS OF DENTAL EQUIPMENT.
- 26. ALL VENT PIPING THROUGH THE ROOF SHALL BE A MINIMUM OF 15'-0" FROM ALL MAKE-UP AIR INLETS OR A MINIMUM OF 2'-O' ABOVE THE TOP OF ALL MAKE-UP AIR INLETS, VENTS THROUGH ROOF ARE TO BE ON
- 27. SEE ARCHITECTURAL DRAWINGS FOR PLUMBING MINIMUM FACILITY CALCULATIONS.
- 28. ALL INDIRECT WASTE IS TO BE PROVIDED WITH AN AIR GAP 2 TIMES THE SIZE OF THE WASTE INLET.
- 29. THE PLUMBING CONTRACTOR SHALL VERIFY BUILDING FLOOR ELEVATION IS ABOVE MANHOLE RIM ELEVATION OR PROVIDE A BACKWATER VALVE AS REQUIRED.
- 30. THE PLUMBING CONTRACTOR SHALL BE RESPONSIBLE FOR MINOR DEMOLITION AT NO COST TO THE
- 31. THE PLUMBING CONTRACTOR SHALL PROVIDE THE ENGINEER WITH A SET OF AS-BUILT DRAWINGS UPON COMPLETION OF PROJECT.

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Community Care Clinic -Dental

Project No: 22027

425 Health Center Dr.


Nags Head, NC Plumbing Plan

01.31.2023


As indicated


PLUMBING NOTES. LEGEND, LOAD, AND DETAILS

PLUMBING SYMBOL LEGEND

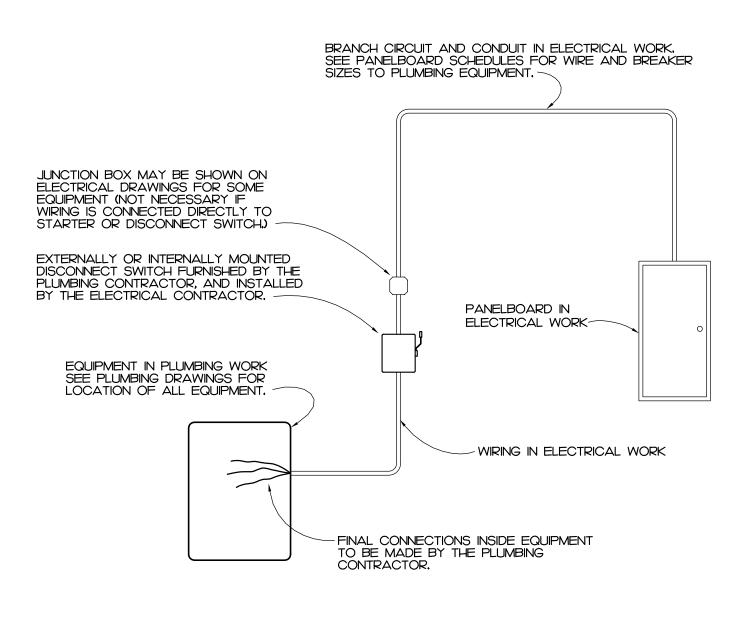

ELECTRICAL WIRING DETAIL

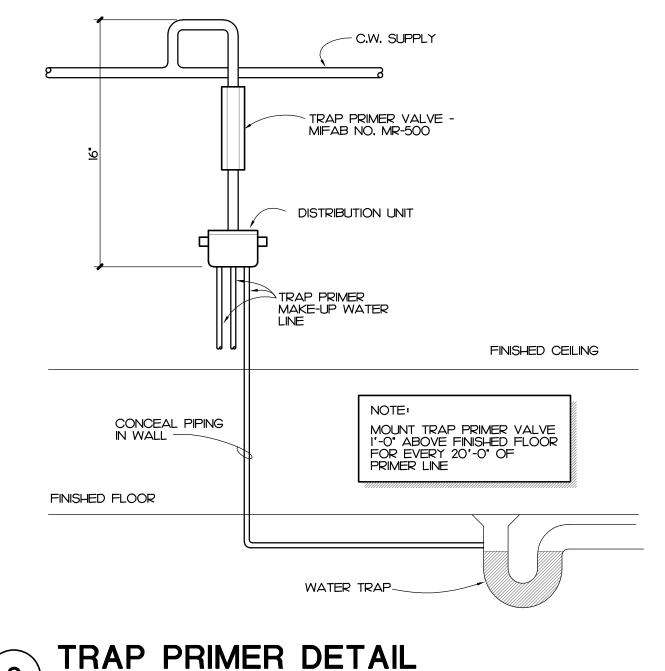

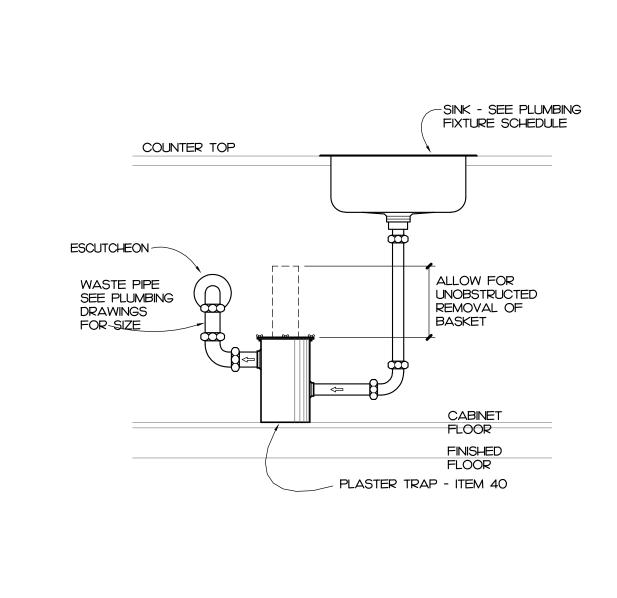

(2)	PLASTER TRAP DETAIL
3	NOT TO SCALE

SYMBOL	DESCRIPTION
	COLD WATER PIPING
	WATER PIPING DIRECTION OF FLOW
	120° F HOT WATER PIPING
	HOT WATER RETURN PIPING
	BALL VALVE
0	PIPING TURNED DOWN
0	PIPING TURNED UP
	PIPING SIDE CONNECTION
A	COMPRESSED AIR PIPING
VA	VACUUM PIPING
	SANITARY SEWER / WASTE PIPING
	SANITARY SEWER / WASTE PIPING DIRECTION OF FLOW
	VENT PIPING
	VENT PIPE UP
	PLUMBING FIXTURE PROVIDED AND INSTALLED BY PLUMBING CONTRACTOR
	PLUMBING FIXTURE PROVIDED BY OTHERS AND INSTALLED BY PLUMBING CONTRACTOR

PLU	IMBING LO	AD SUMMA	RY
	WATER DEMAND FU	WATER DEMAND GPM	SANITARY SEWER DEMAND FU
EXISTING	II	15.4	7
NEW	9	13.7	13
TOTAL	20	19.6	20

defect or deficiency in the contract documents ("error") prepared by the designer or its consultants which in any way impacts the schedule of the project, results in a lack of coordination among the contract documents, delays the completion of the project or which in any other way causes any damage or loss to the own contractor, subcontractors, or other entity involved in the project, unless: (i) designer is promptly notified of such error, in any event within 14 days of the date such error was discovered or could reasonably have been discovered; and (ii) designer is given opportunity at the time of discovery to address such error, and, if appropriate, take such steps as are necessary to correct and resolve it. Failure to comply with the provisions of this paragraph shall constitute a waiver of any claim for damages, or right to offset against designer by owner, contractor or others and shall in no event cause or allow a reduction in the fees otherwise due designer for services provided on the project.


The designer shall not be responsible for any error, omission,

Revisions: Description

Reviewed: JBD

P202

NOT TO SCALE

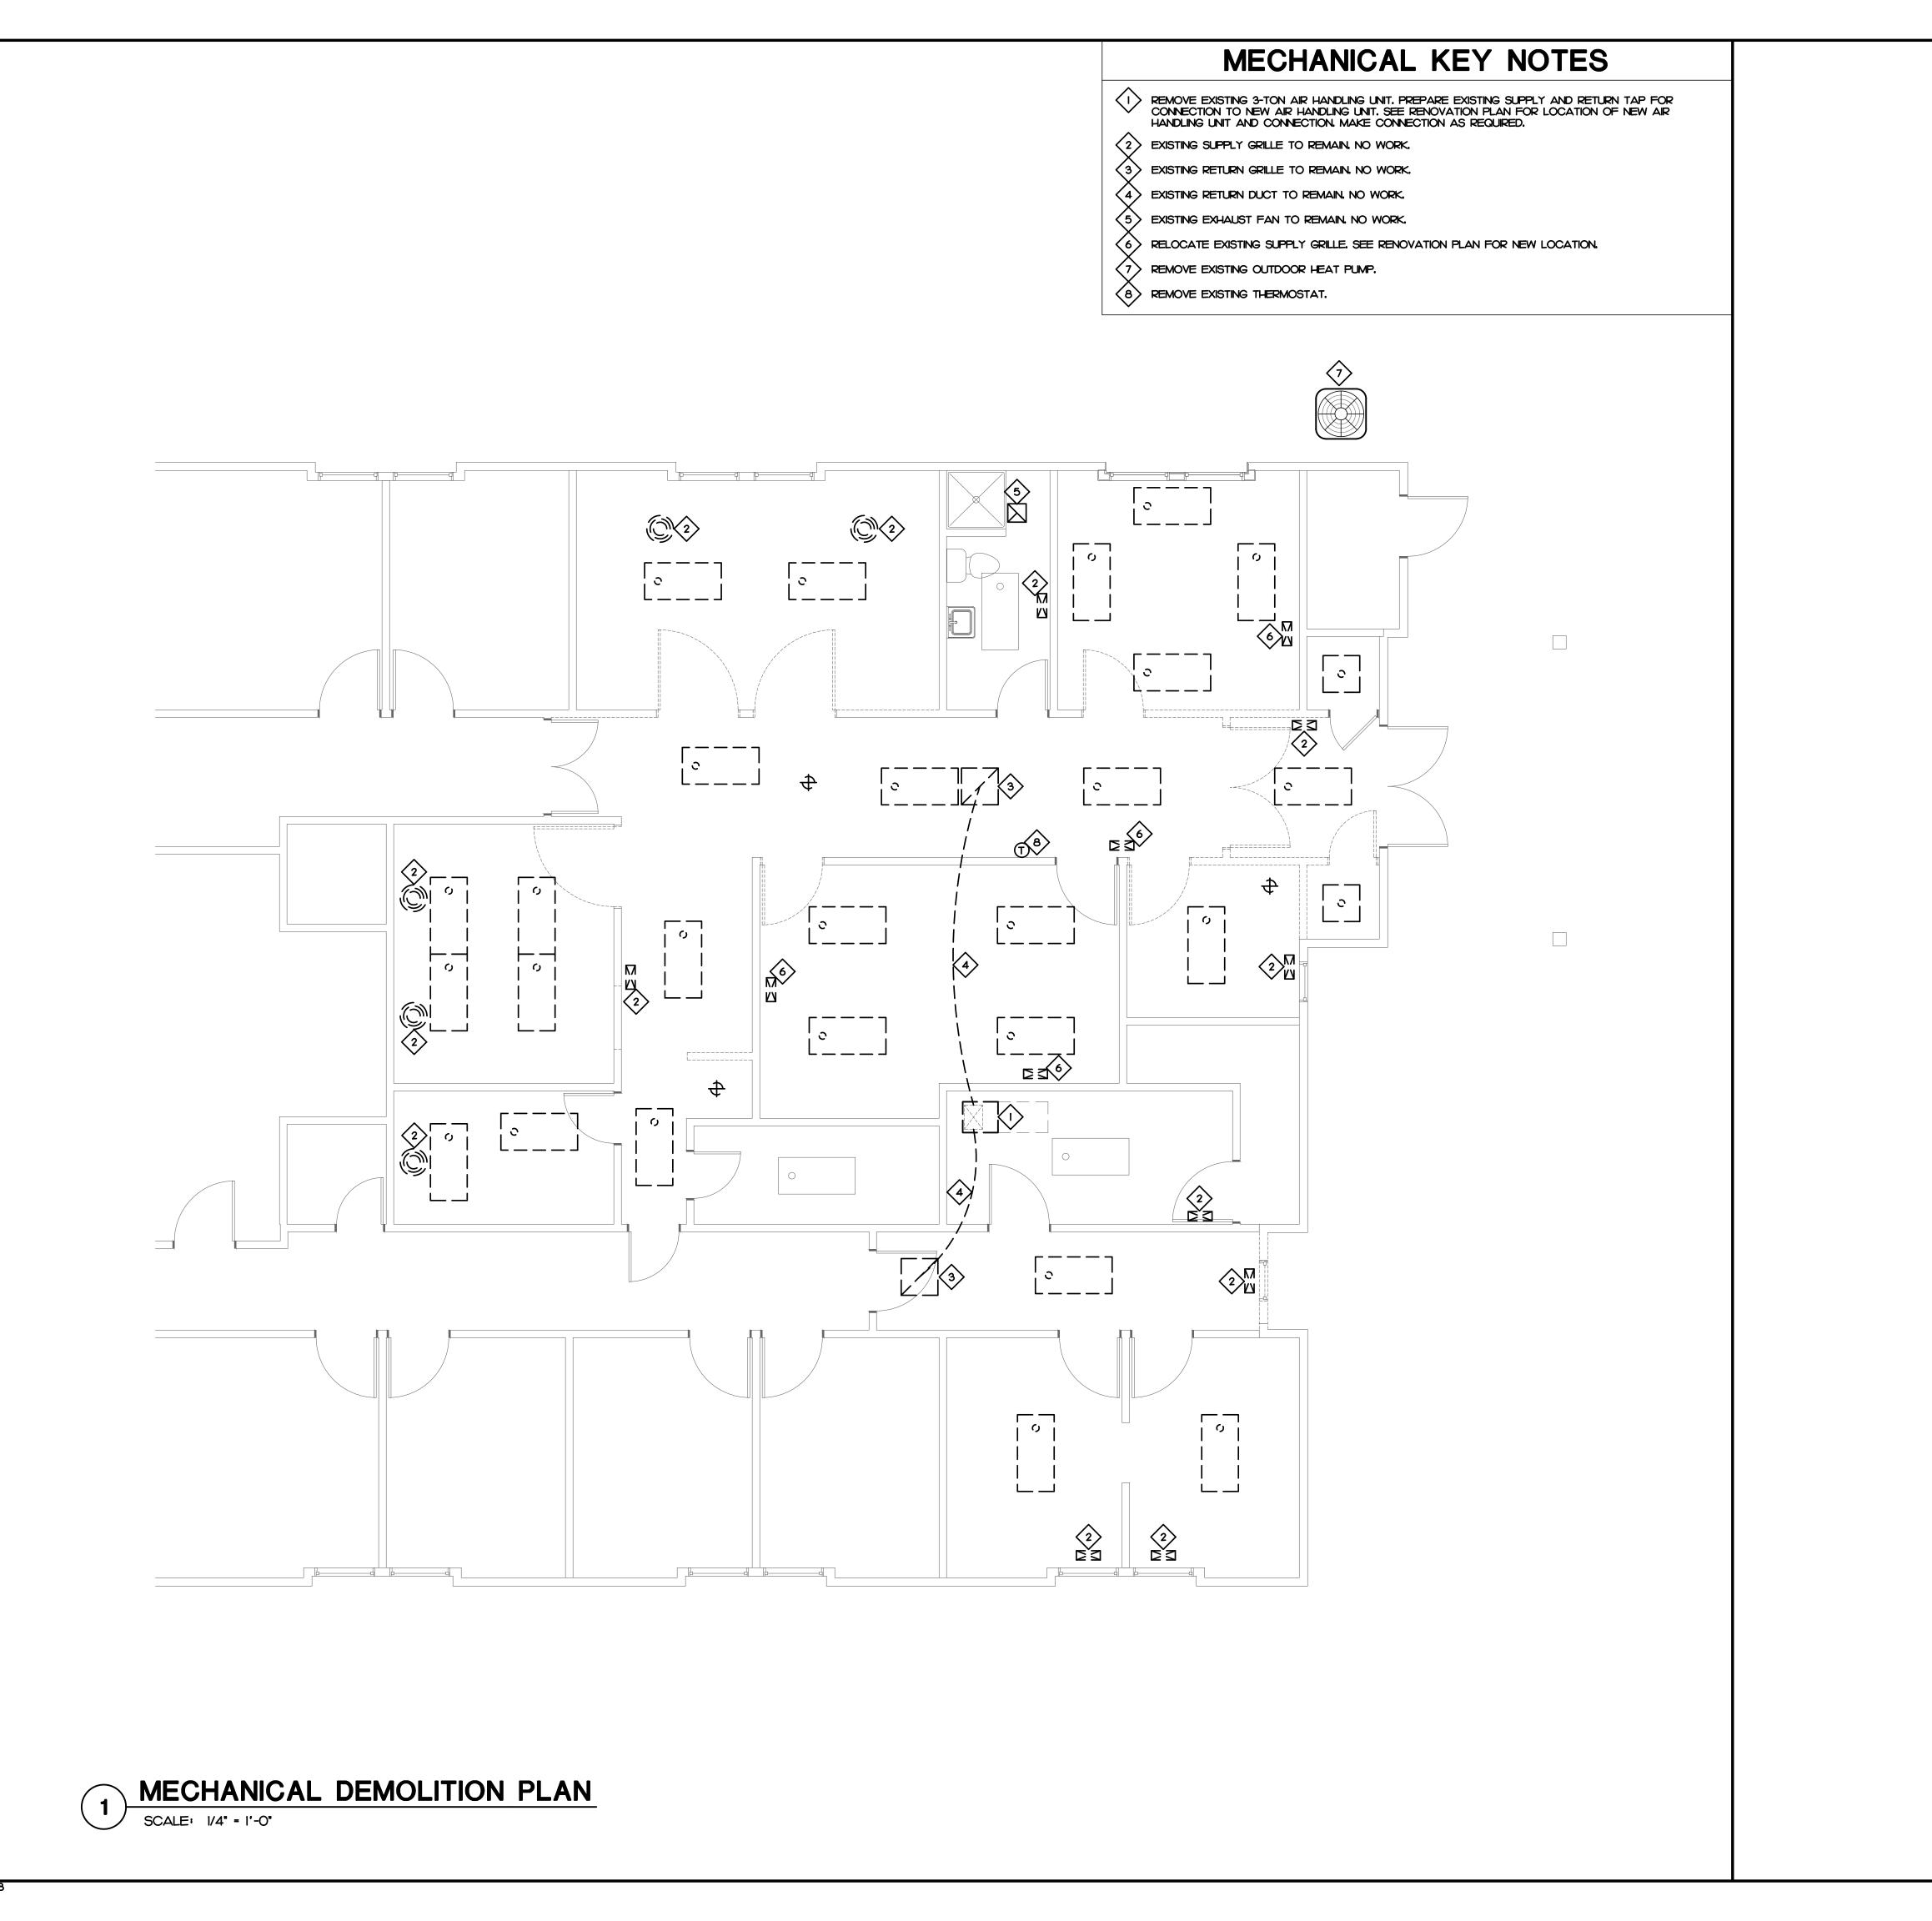

Cahoon + kasten A R C H I T E C T S 118 West Woodhill Drive

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CARO CARO SESSION AND SELPARATION OF THE PARKETING PROPERTY OF THE P

Project: Community Care Clinic - Dental

Project No: 22027

Location: 425 Health Center Dr.
Nags Head, NC
Title: MECHANICAL

ate: 01.31.2023

: As indicated


MECHANICAL DEMOLITION PLAN

The designer shall not be responsible for any error, omission, defect or deficiency in the contract documents ("error") prepared by the designer or its consultants which in any way impacts the schedule of the project, results in a lack of coordination among the contract documents, delays the completion of the project or which in any other way causes any damage or loss to the owner contractor, subcontractors, or other entity involved in the project, unless: (i) designer is promptly notified of such error, in any event within 14 days of the date such error was discovered or could reasonably have been discovered; and (ii) designer is given opportunity at the time of discovery to address such error, and, if appropriate, take such steps as are necessary to correct and resolve it. Failure to comply with the provisions of this paragraph shall constitute a waiver of any claim for damages, or a right to offset against designer by owner, contractor or others and shall in no event cause or allow a reduction in the fees otherwise due designer for services provided on the project.

Revisions:

No. Description Date

Designed: JAD
Drawn: JAD
Reviewed: JBD

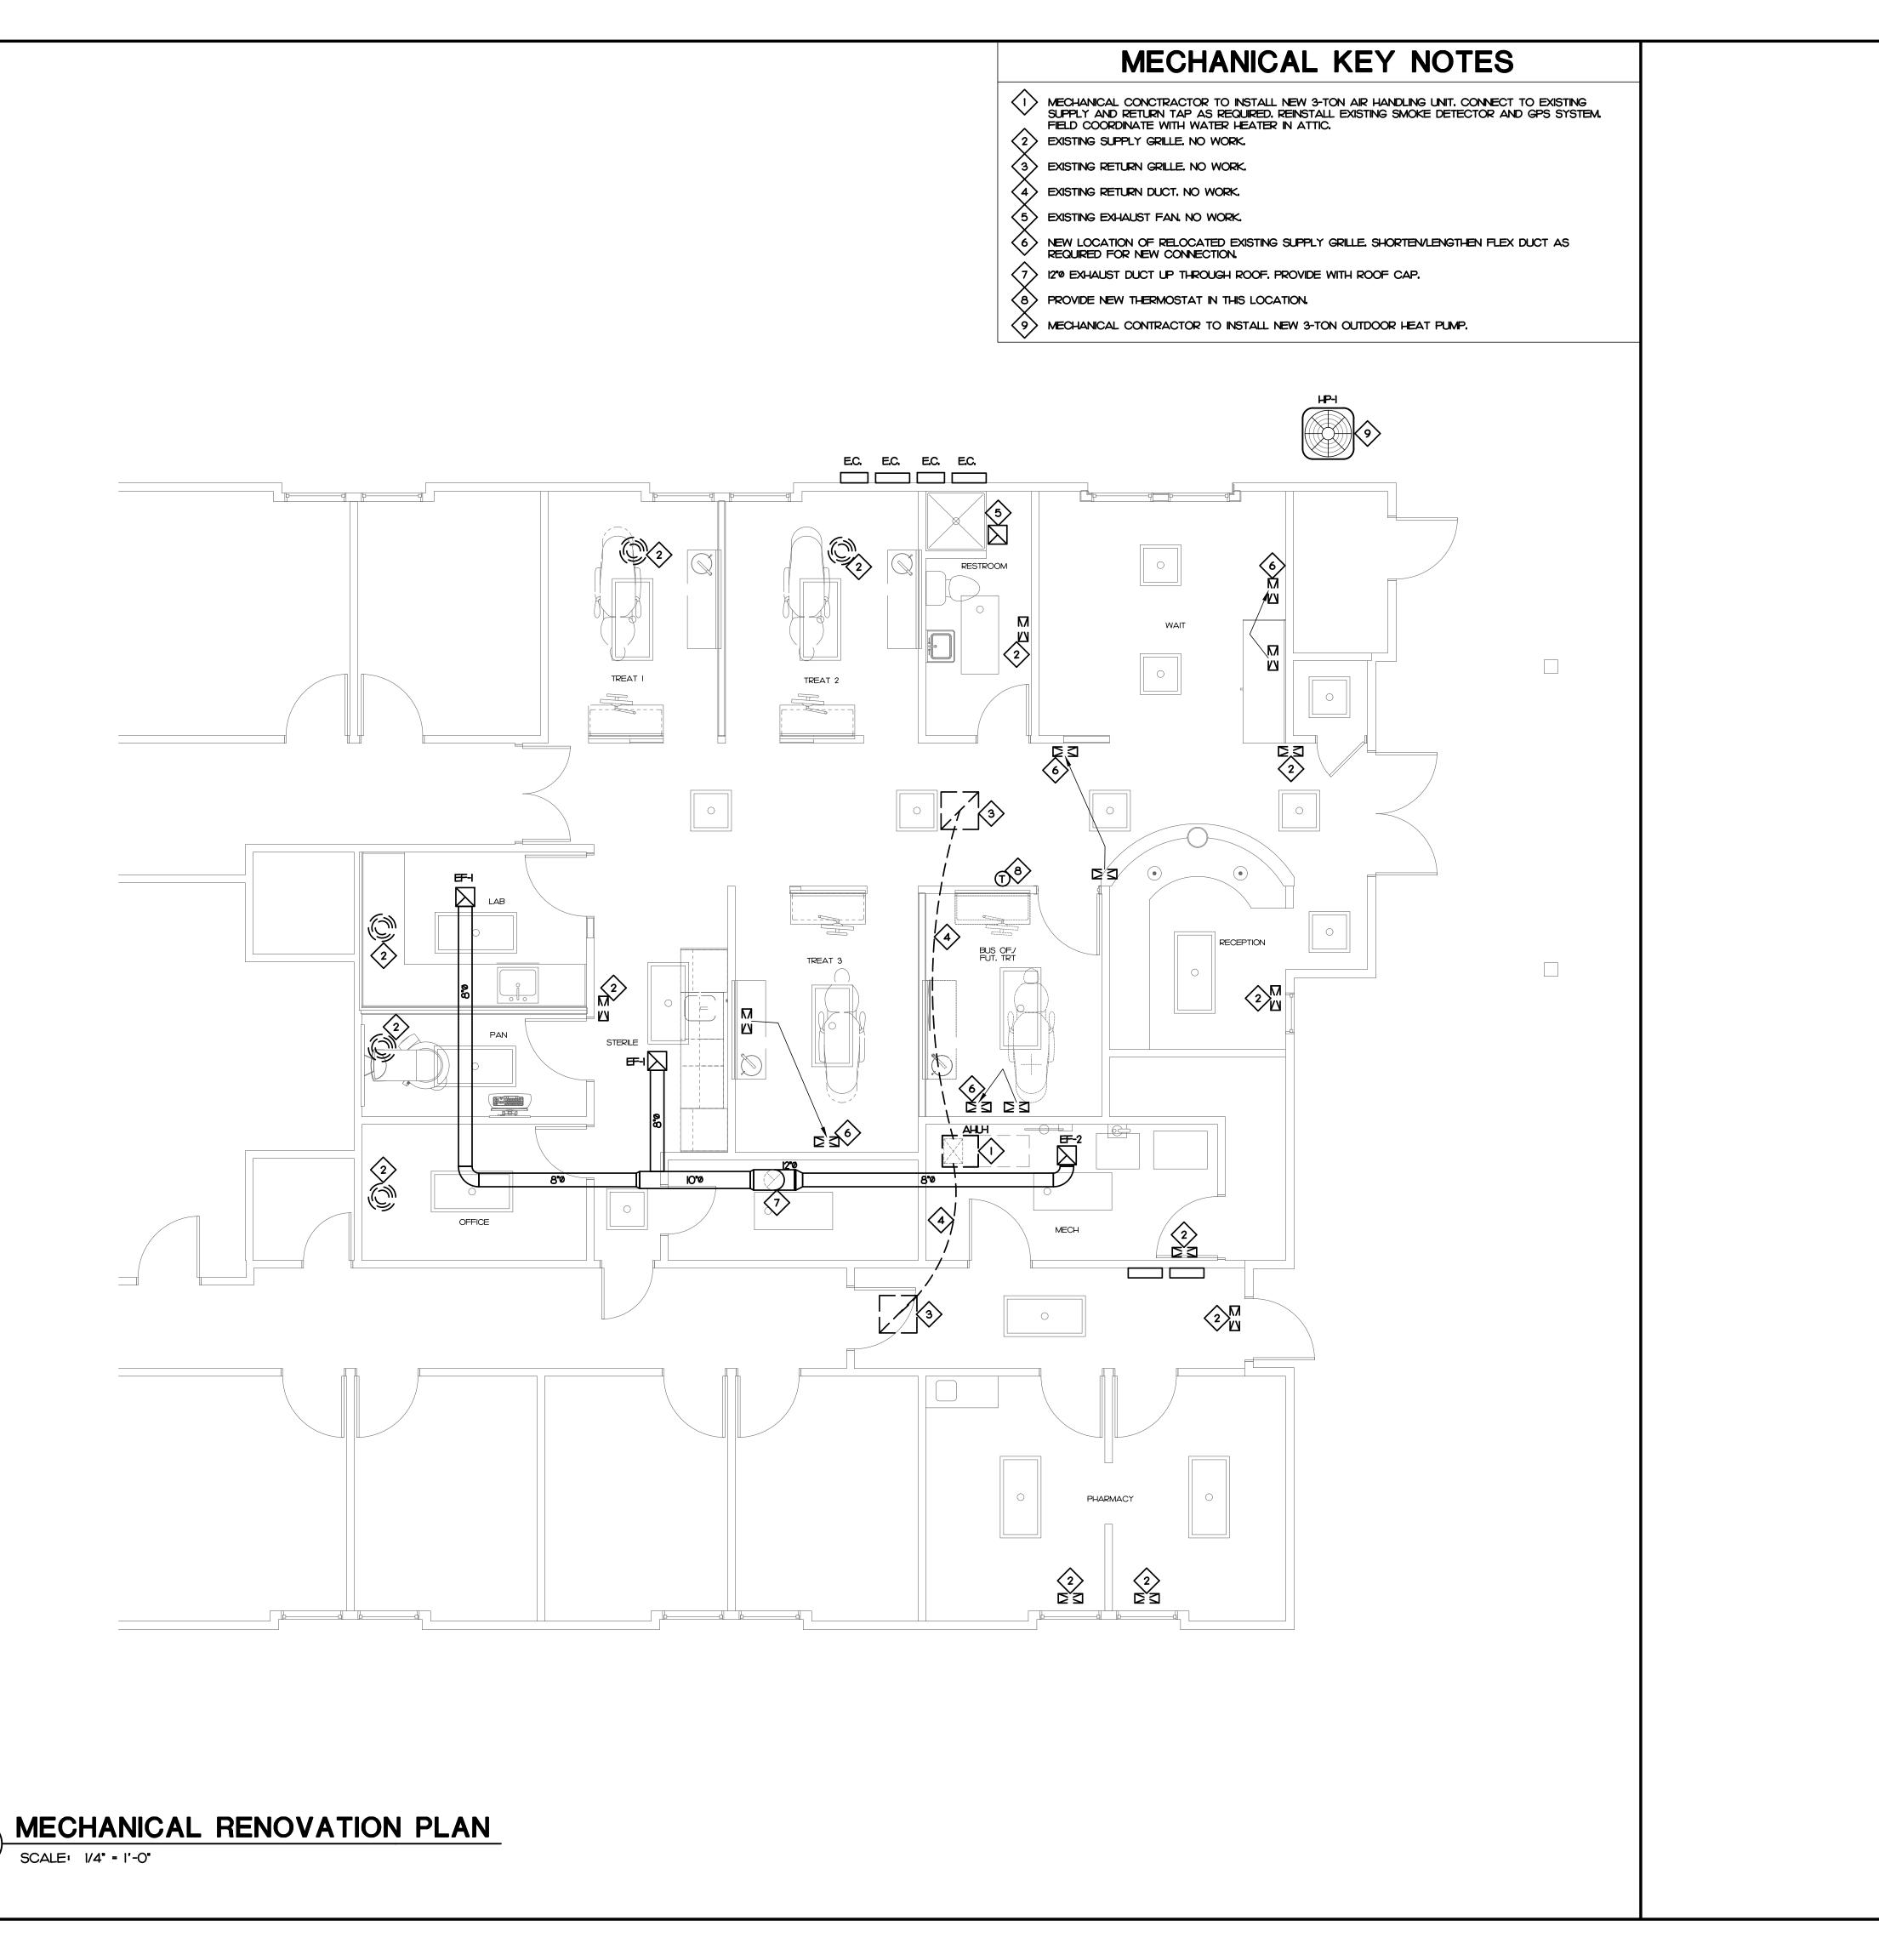

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Project: Community Care Clinic -

Dental
Project No: 22027

Location: 425 Health Center Dr. Nags Head, NC

Title: MECHANICAL

ate: 01.31.2023

cale: As indicated

MECHANICAL RENOVATION PLAN


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Revisions:


No.	Description	Date

Designed: JAD
Drawn: JAD
Reviewed: JBD

M101



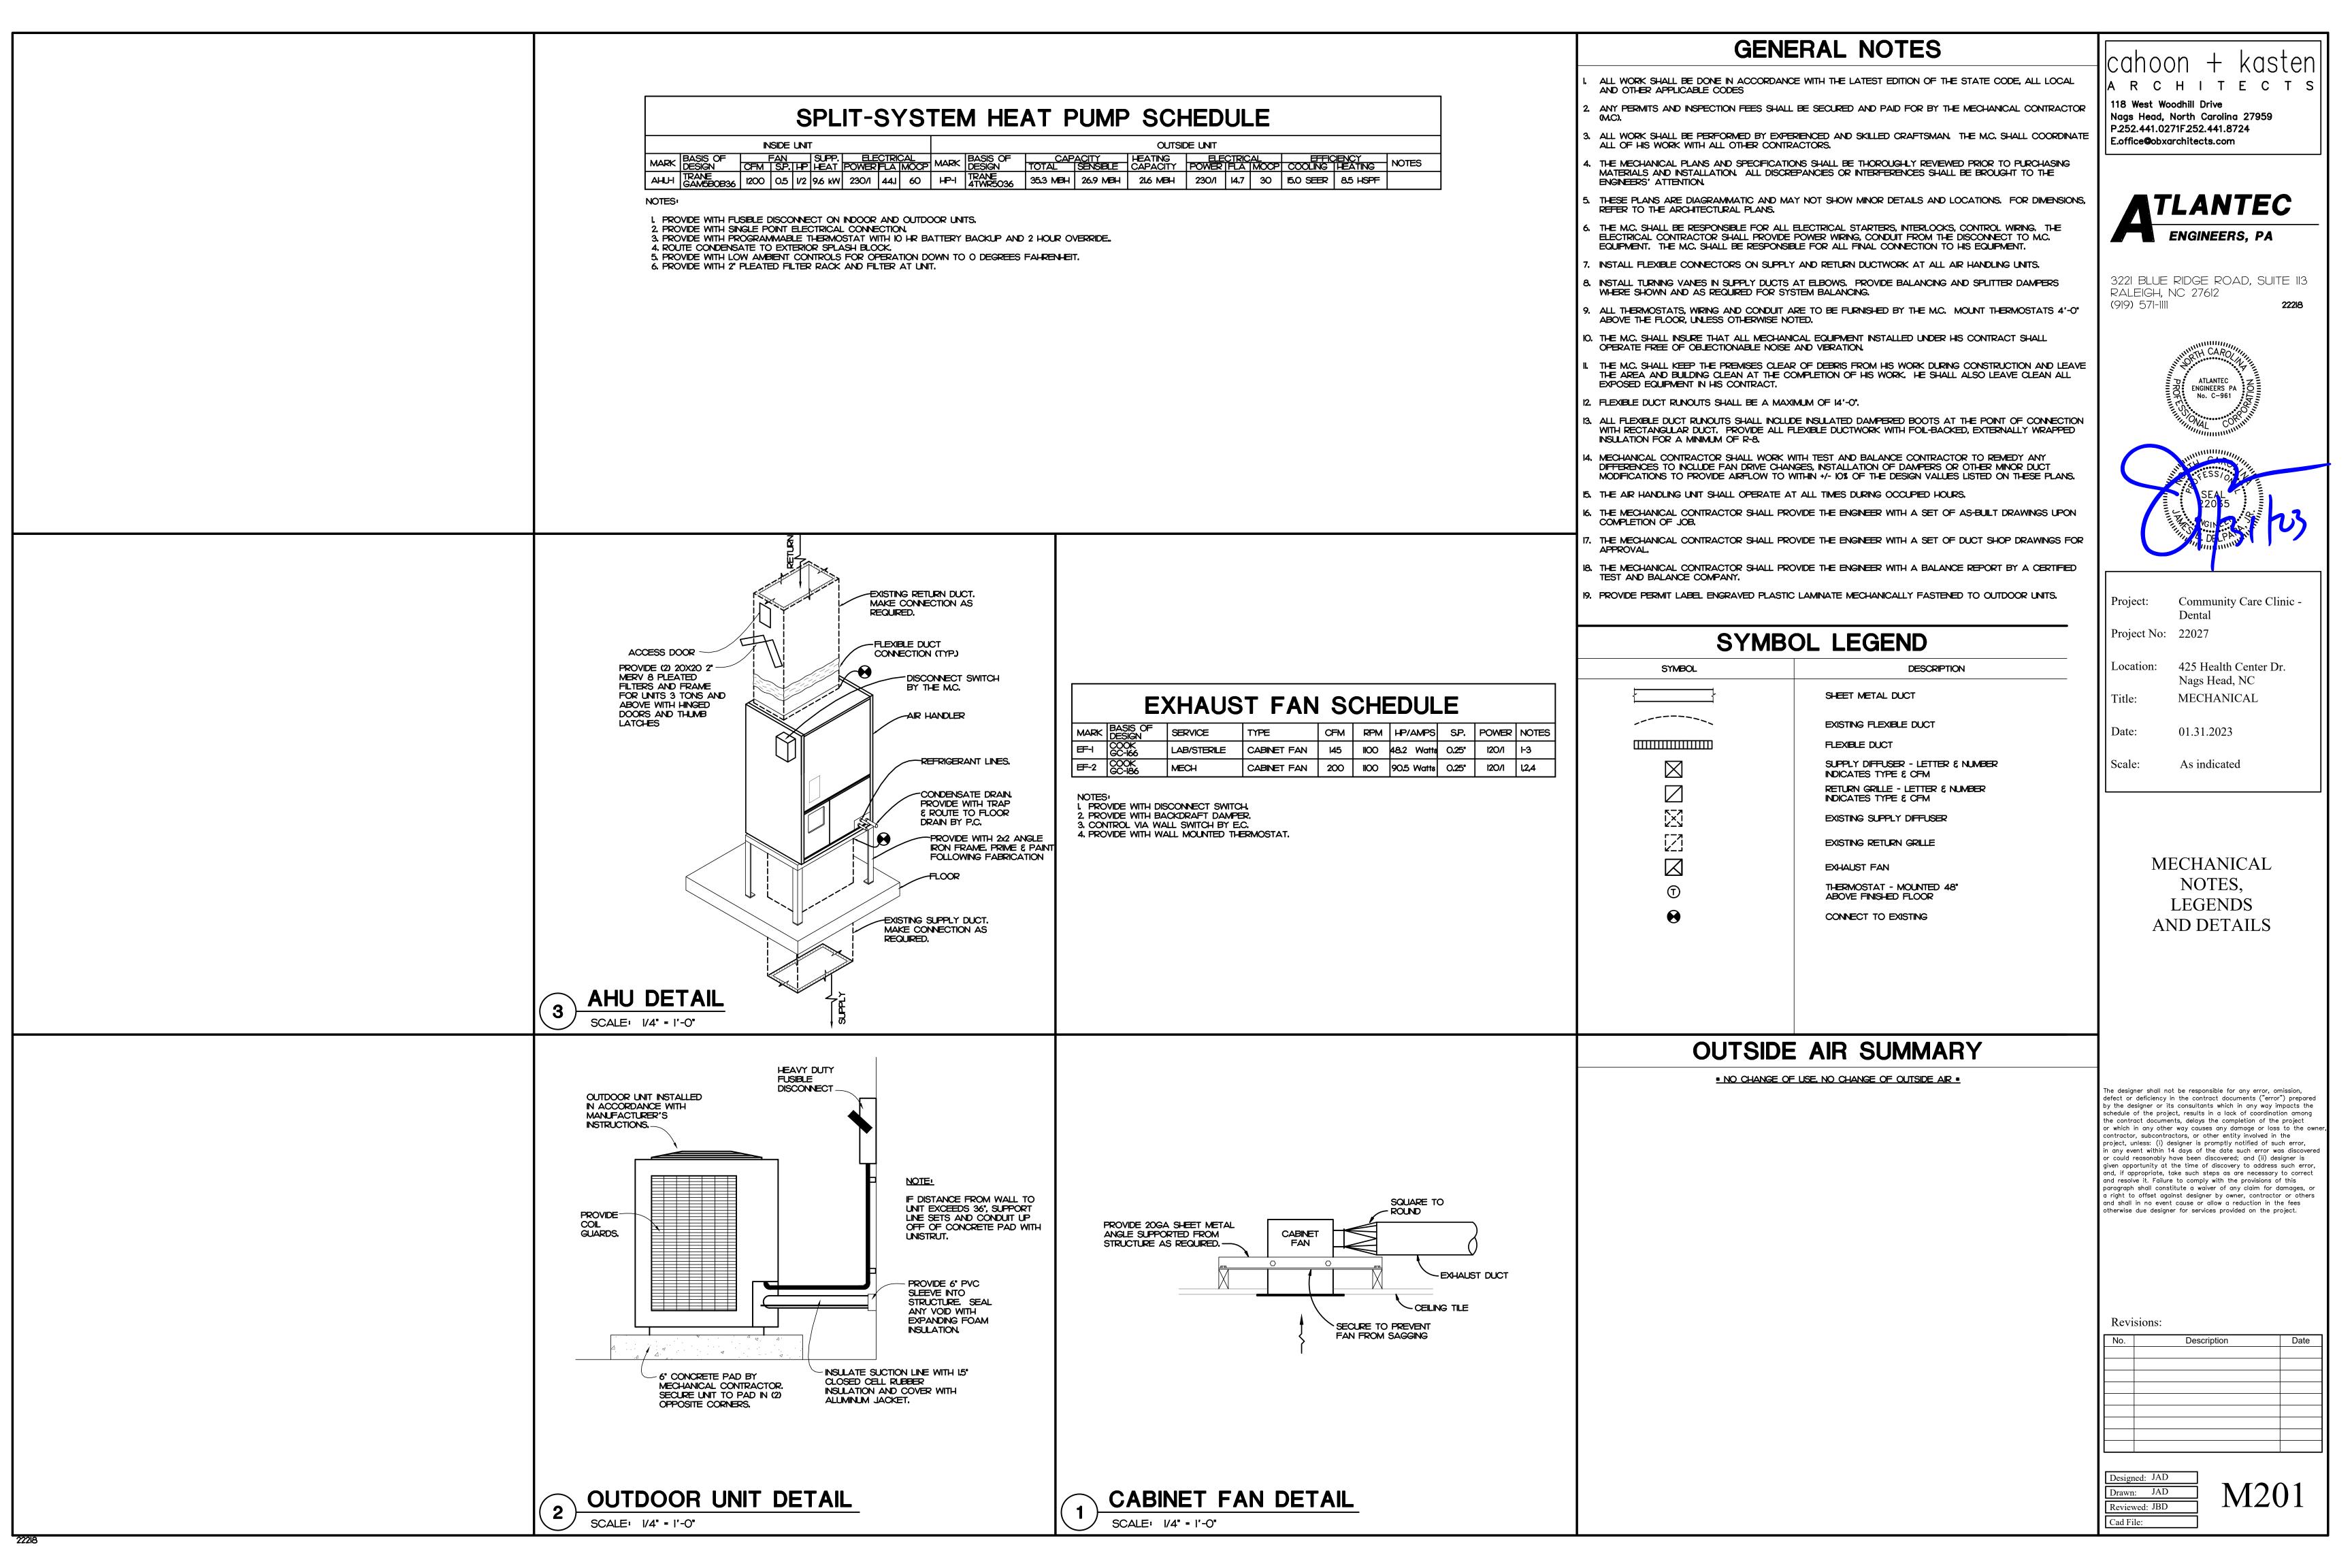

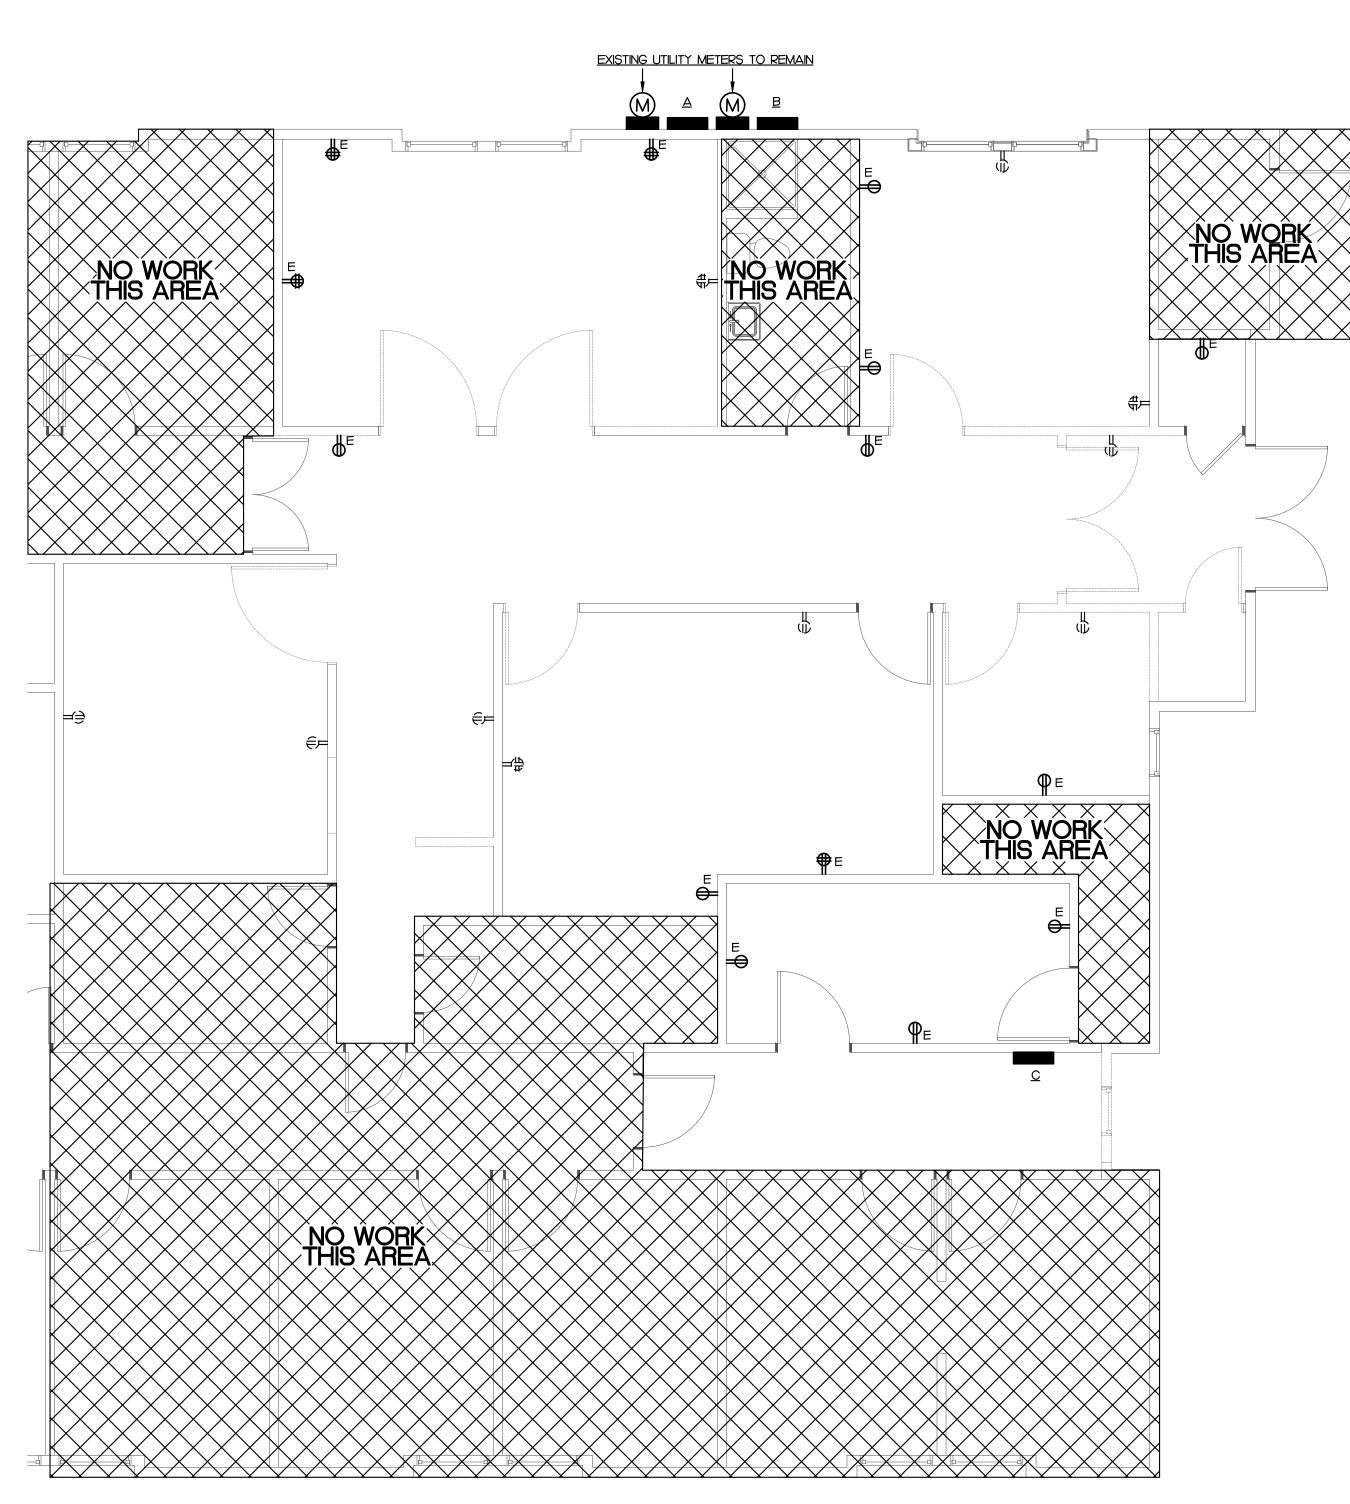

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Project: Community Care Clinic Dental

Project No: 22027

Location: 425 Health Center Dr. Nags Head, NC

ELECTRICAL PLAN

Date: 01.31.2023

Scale: As indicated

ELECTRICAL DEMOLITION PLANS

The designer shall not be responsible for any error, omission, defect or deficiency in the contract documents ("error") prepared by the designer or its consultants which in any way impacts the schedule of the project, results in a lack of coordination among the contract documents, delays the completion of the project or which in any other way causes any damage or loss to the owner contractor, subcontractors, or other entity involved in the project, unless: (i) designer is promptly notified of such error, in any event within 14 days of the date such error was discovered or could reasonably have been discovered; and (ii) designer is given opportunity at the time of discovery to address such error, and, if appropriate, take such steps as are necessary to correct and resolve it. Failure to comply with the provisions of this paragraph shall constitute a waiver of any claim for damages, or a right to offset against designer by owner, contractor or others and shall in no event cause or allow a reduction in the fees otherwise due designer for services provided on the project.

Revisions:

No.	Description	Date

Designed: SWM

Drawn: SWM


Reviewed: MCB

Cad File:

E101


POWER DEMOLITION PLAN

22218

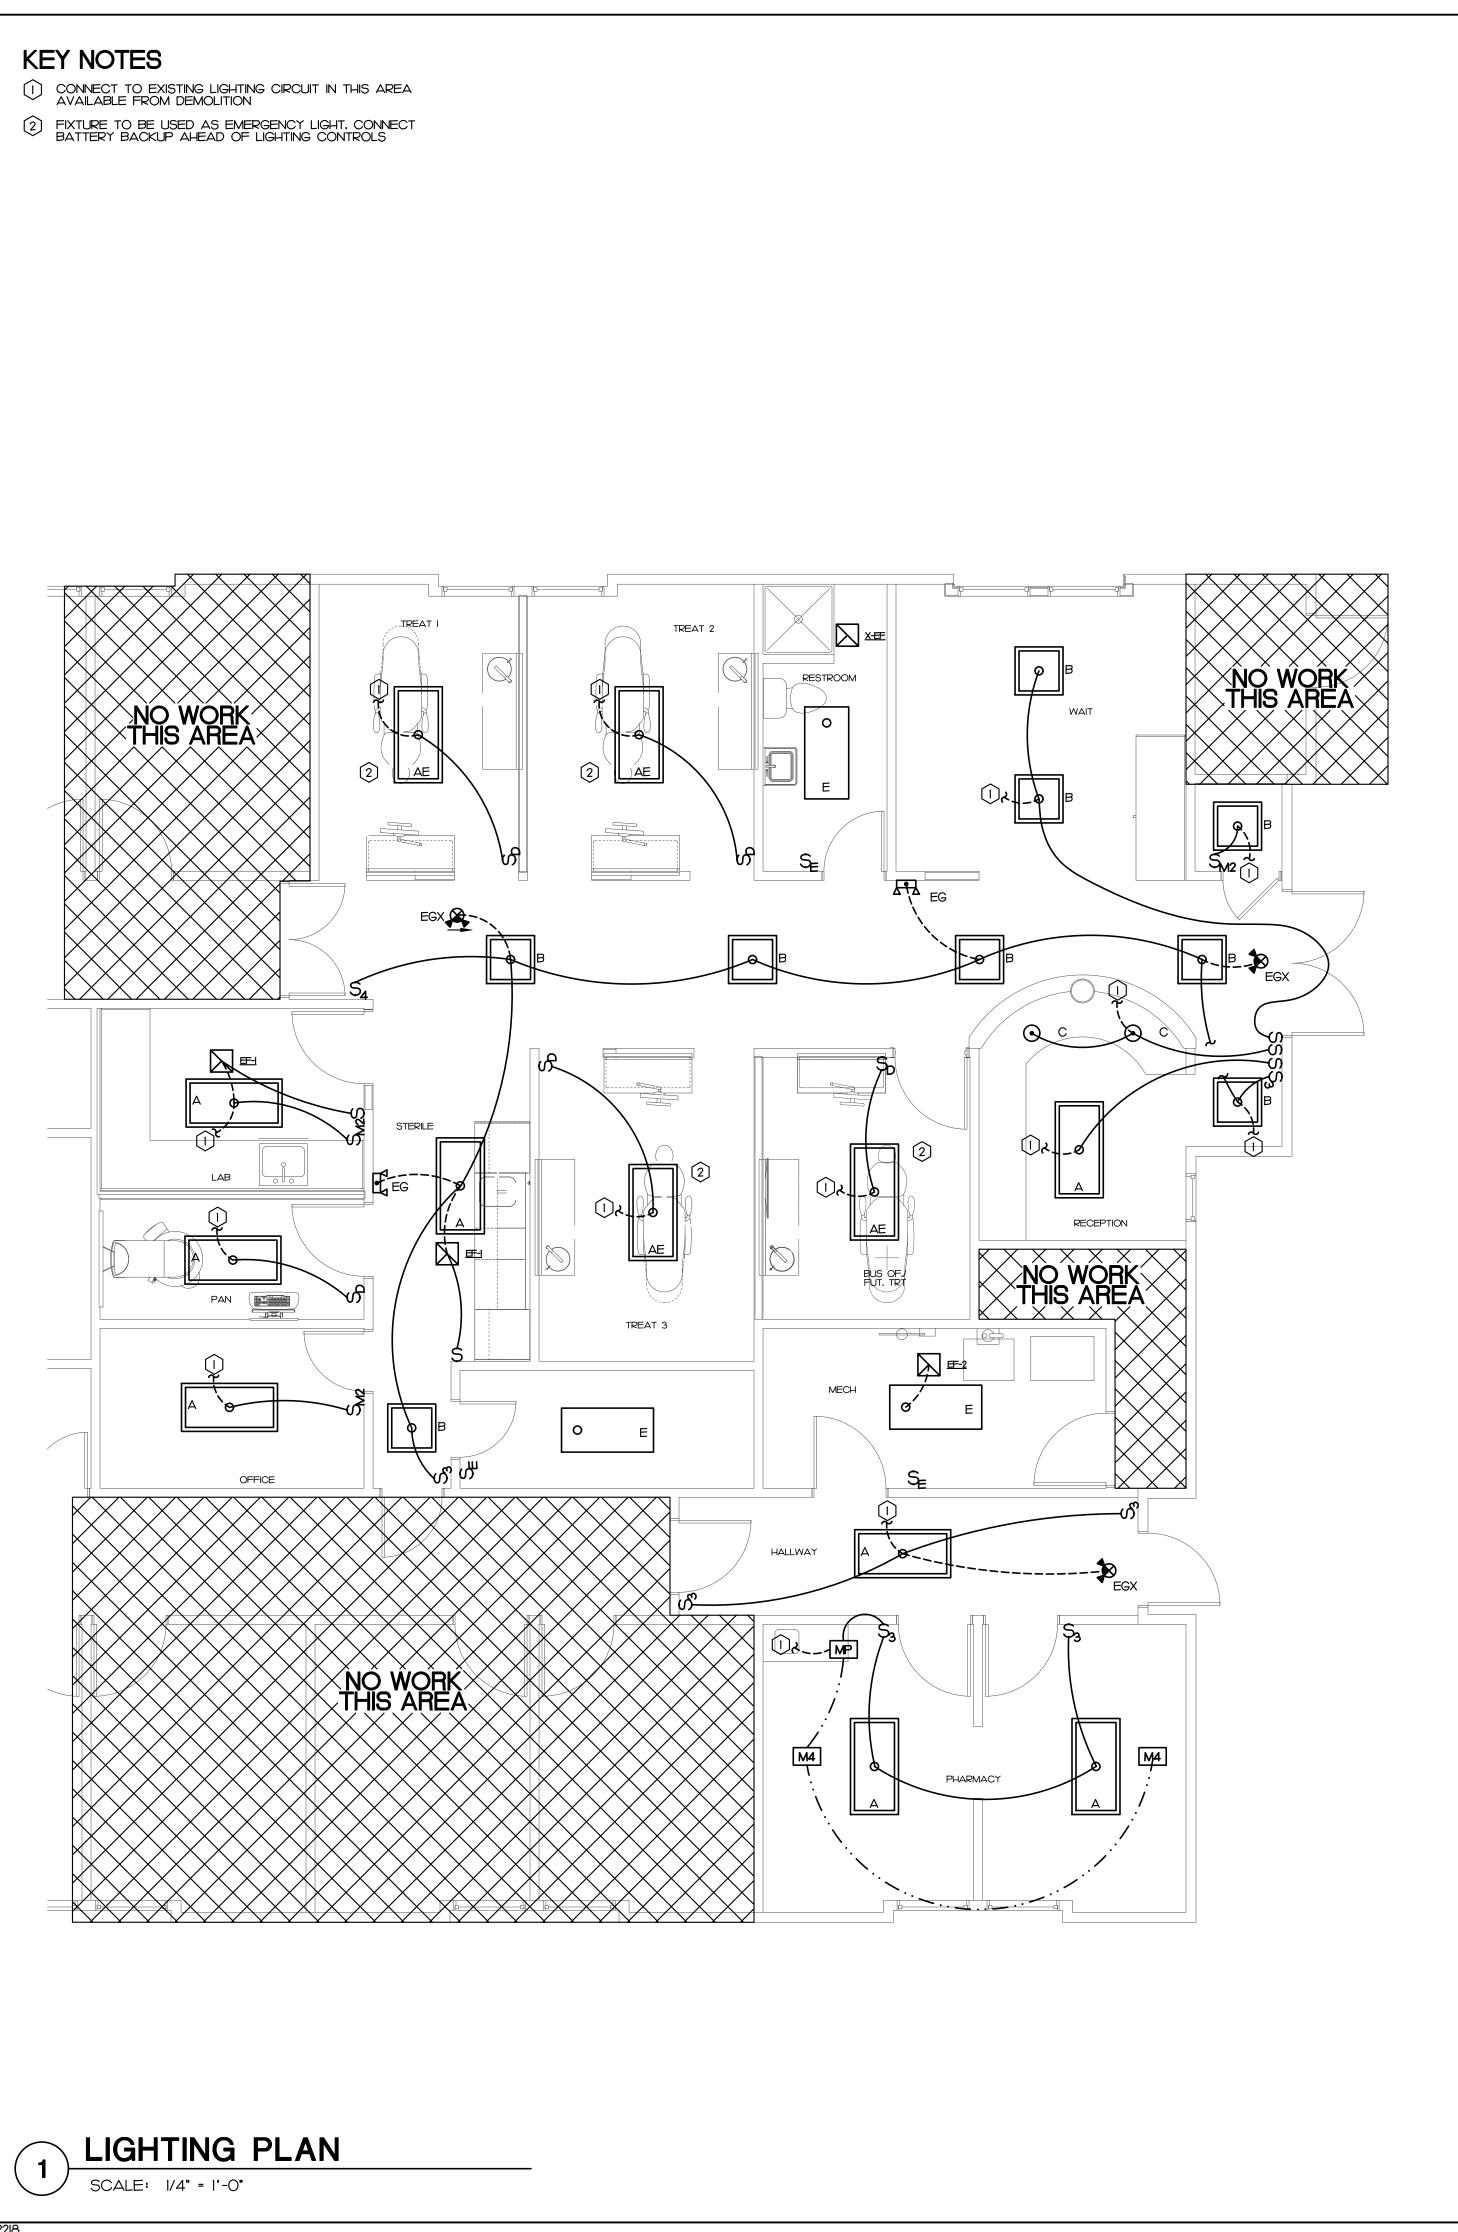

KEY NOTES

- COORDINATE DEVICE LOCATIONS FOR DENTAL EQUIPMENT IN THIS AREA WITH DENTAL EQUIPMENT SUPPLIER PRIOR TO ROUGH-IN, SEE DENTAL PLANS FOR DETAILS
- FLUSH TO FLOOR QUAD RECEPTACLE AND DATA OUTLET. PROVIDE (I) 3/4" CONDUIT FOR POWER AND (I) I-I/4" CONDUIT FOR COMMUNICATION, CUT AND PATCH FLOOR AS REQUIRED, FIELD COORDINATE EXACT LOCATION WITH ARCHITECT PRIOR TO ROUGH-IN
- CONNECT TO EXISTING RECEPTACLE CIRCUIT IN THIS AREA AVAILABLE FROM DEMOLITION
- (4) CONNECT TO EXISTING RECEPTACLE CIRCUIT AS SHOWN
- (5) QUAD RECEPTACLE AND DATA OUTLET LOCATED AT MILLWORK, FIELD COORDINATE EXACT LOCATION AND MOUNTING HEIGHT WITH ARCHITECT PRIOR TO ROUGH-IN
- 6 CONNECT EXISTING RECEPTACLE TO NEW RECEPTACLE CIRCUIT AS SHOWN

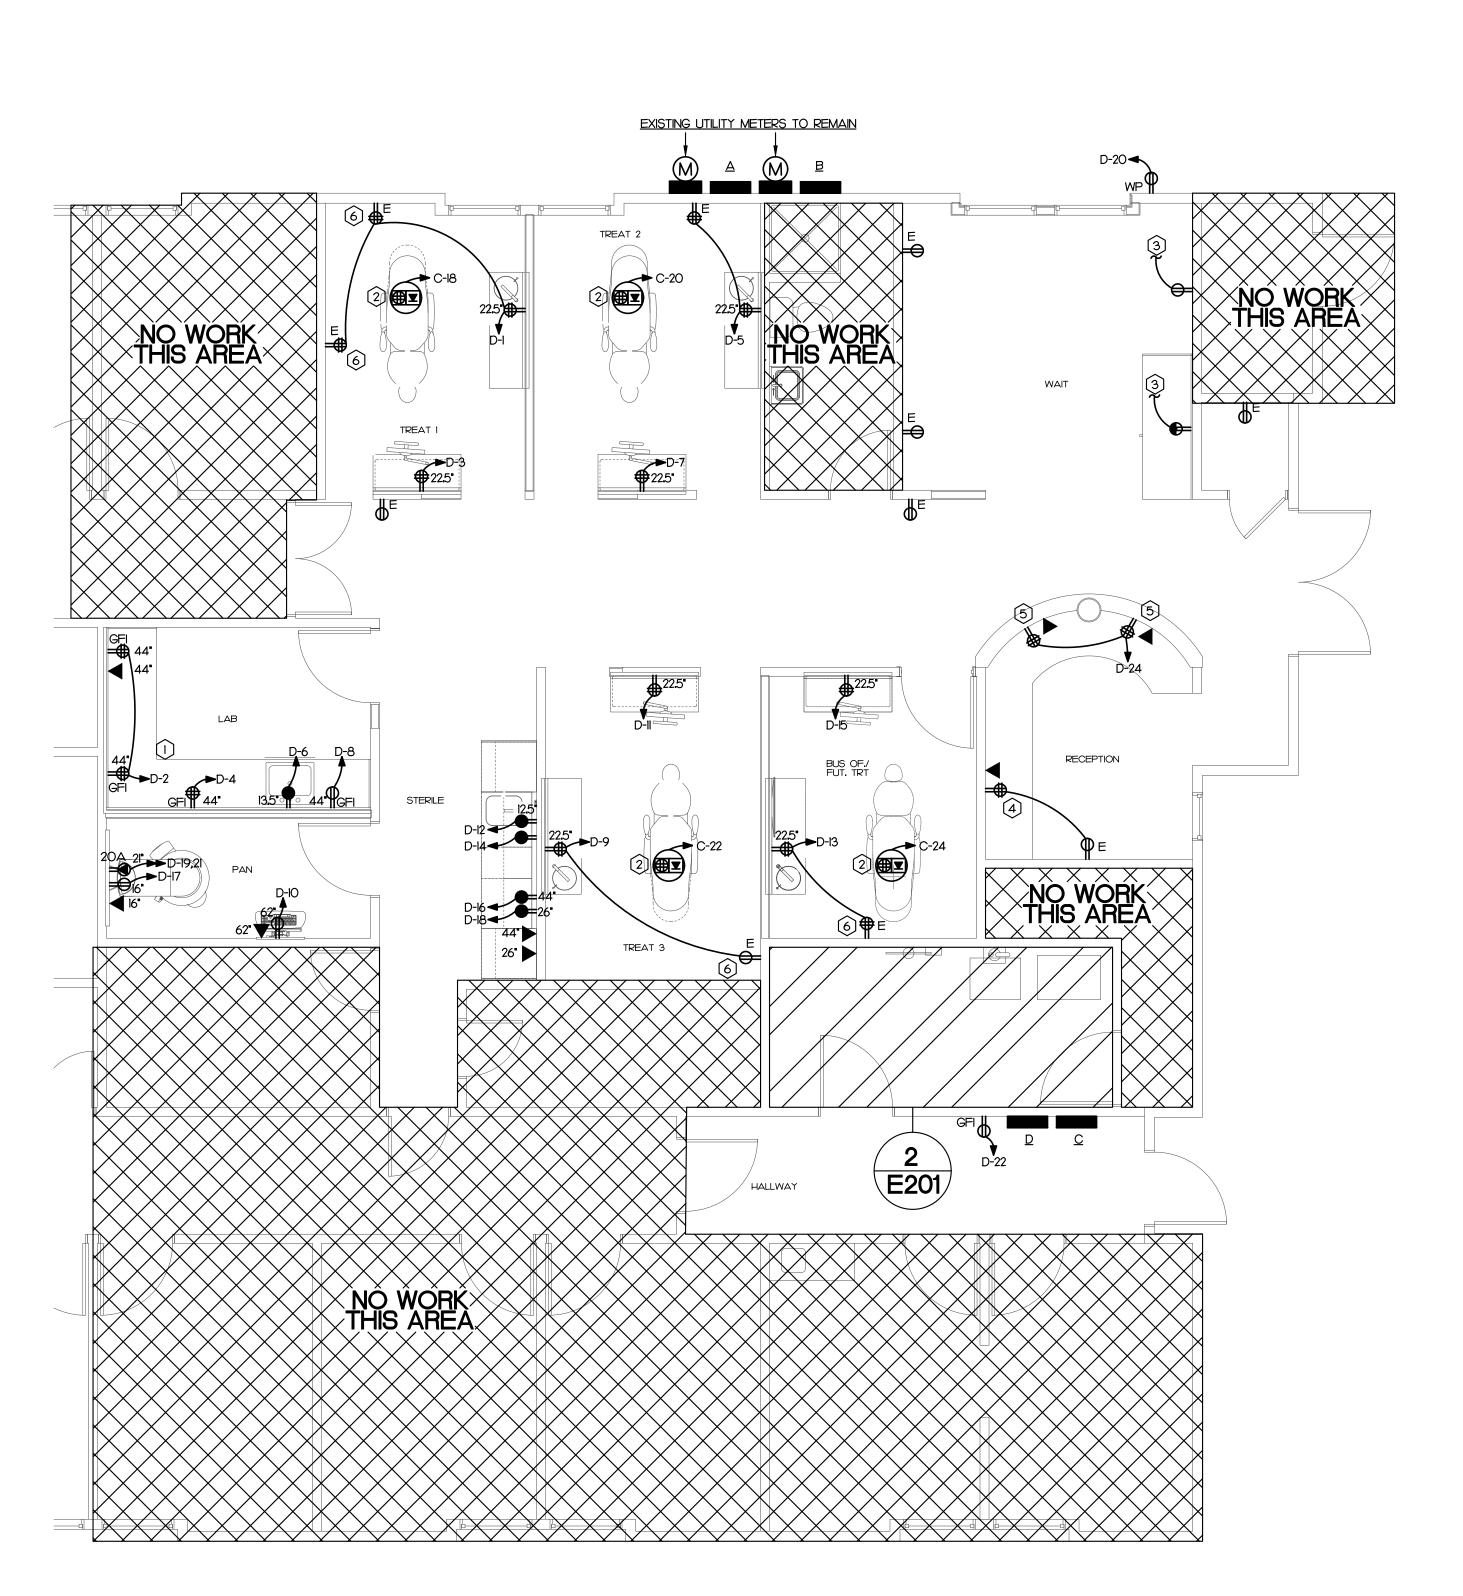

NOTES:

- I. E.C. SHALL OBTAIN THE LATEST SET OF DENTAL EQUIPMENT DRAWINGS BY PATTERSON DENTAL PRIOR TO START OF CONSTRUCTION
- 2. ALL PATIENT CARE AREAS TO MEET REQUIREMENTS OF ARTICLE 517 OF THE NEC
- COORDINATE ALL DENTAL EQUIPMENT LOCATIONS AND CONNECTIONS WITH THE DENTAL EQUIPMENT PROVIDER, OWNER, AND PATTERSON EQUIPMENT SPECIALIST PRIOR TO ROUGH IN.
- 4. E.C. TO CONFIRM SIZES OF ALL JUNCTION BOXES WITH DENTAL PLANS.

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Community Care Clinic -Dental

Project No: 22027

Location: 425 Health Center Dr. Nags Head, NC

ELECTRICAL PLAN

Date: 01.31.2023

As indicated

Title:

ELECTRICAL **PLANS**

The designer shall not be responsible for any error, omission, defect or deficiency in the contract documents ("error") prepared by the designer or its consultants which in any way impacts the schedule of the project, results in a lack of coordination among the contract documents, delays the completion of the project or which in any other way causes any damage or loss to the owner contractor, subcontractors, or other entity involved in the project, unless: (i) designer is promptly notified of such error, in any event within 14 days of the date such error was discovered or could reasonably have been discovered; and (ii) designer is given opportunity at the time of discovery to address such error, and, if appropriate, take such steps as are necessary to correct and resolve it. Failure to comply with the provisions of this paragraph shall constitute a waiver of any claim for damages, or a right to offset against designer by owner, contractor or others and shall in no event cause or allow a reduction in the fees otherwise due designer for services provided on the project.

Revisions:

No.	Description	Date

Designed: SWM Drawn: SWM Reviewed: MCB


Cad File:

E102

POWER PLAN


KEY NOTES

- MASTER REMOTE CONTROL PANEL, PROVIDED BY OTHERS, INSTALL AT 60" A.F.F. E.C. TO PROVIDE BOX, CONDUITS, AND LOW VOLTAGE WIRES AS DIRECTED BY DENTAL EQUIPMENT SUPPLIER. SEE DENTAL PLANS FOR DETAILS
- 2 INSTALL EMPTY JUNCTION BOX FLUSH IN WALL PER DENTAL EQUIPMENT SUPPLIER INSTRUCTION, SEE DENTAL PLANS FOR DETAILS
- 3 X-RAY REMOTE EXPOSURE BUTTON CONTRACTOR TO SUPPLY AND INSTALL PIPE CHASE WITH PULL-STRING TO IMAGING UNIT, VERIFY SUPPLIER OF EXPOSURE BUTTON AND WIRING WITH PATTERSON EQUIPMENT SPECIALIST, FINAL CONNECTION BY PATTERSON DENTAL.
- (4) 2" CONDUIT RUN IN WALL, SEE DENTAL PLANS FOR DETAILS, E.C. TO RUN LOW VOLTAGE WIRES OR CABLES TO LOCATIONS INDICATED ON DENTAL PLANS
- 2" CONDUIT SUB-FLOOR PIPE CHASE WITH PULL STRING SUPPLIED AND INSTALLED BY E.C. SWEEPING 90 DEGREE BENDS, STUB-UP FLUSH WITH SUB-FLOOR, MARK LOCATION AFTER INSTALLATION, CUT AND PATCH FLOOR AS REQUIRED, SEE DENTAL PLANS FOR EXACT STUB UP LOCATION AND ROUTING
- 6 TERMINATE LOW VOLTAGE WIRE FROM MASTER REMOTE CONTROL PANEL IN FLUSH MOUNTED JUNCTION BOX AT WALL AS INDICATED

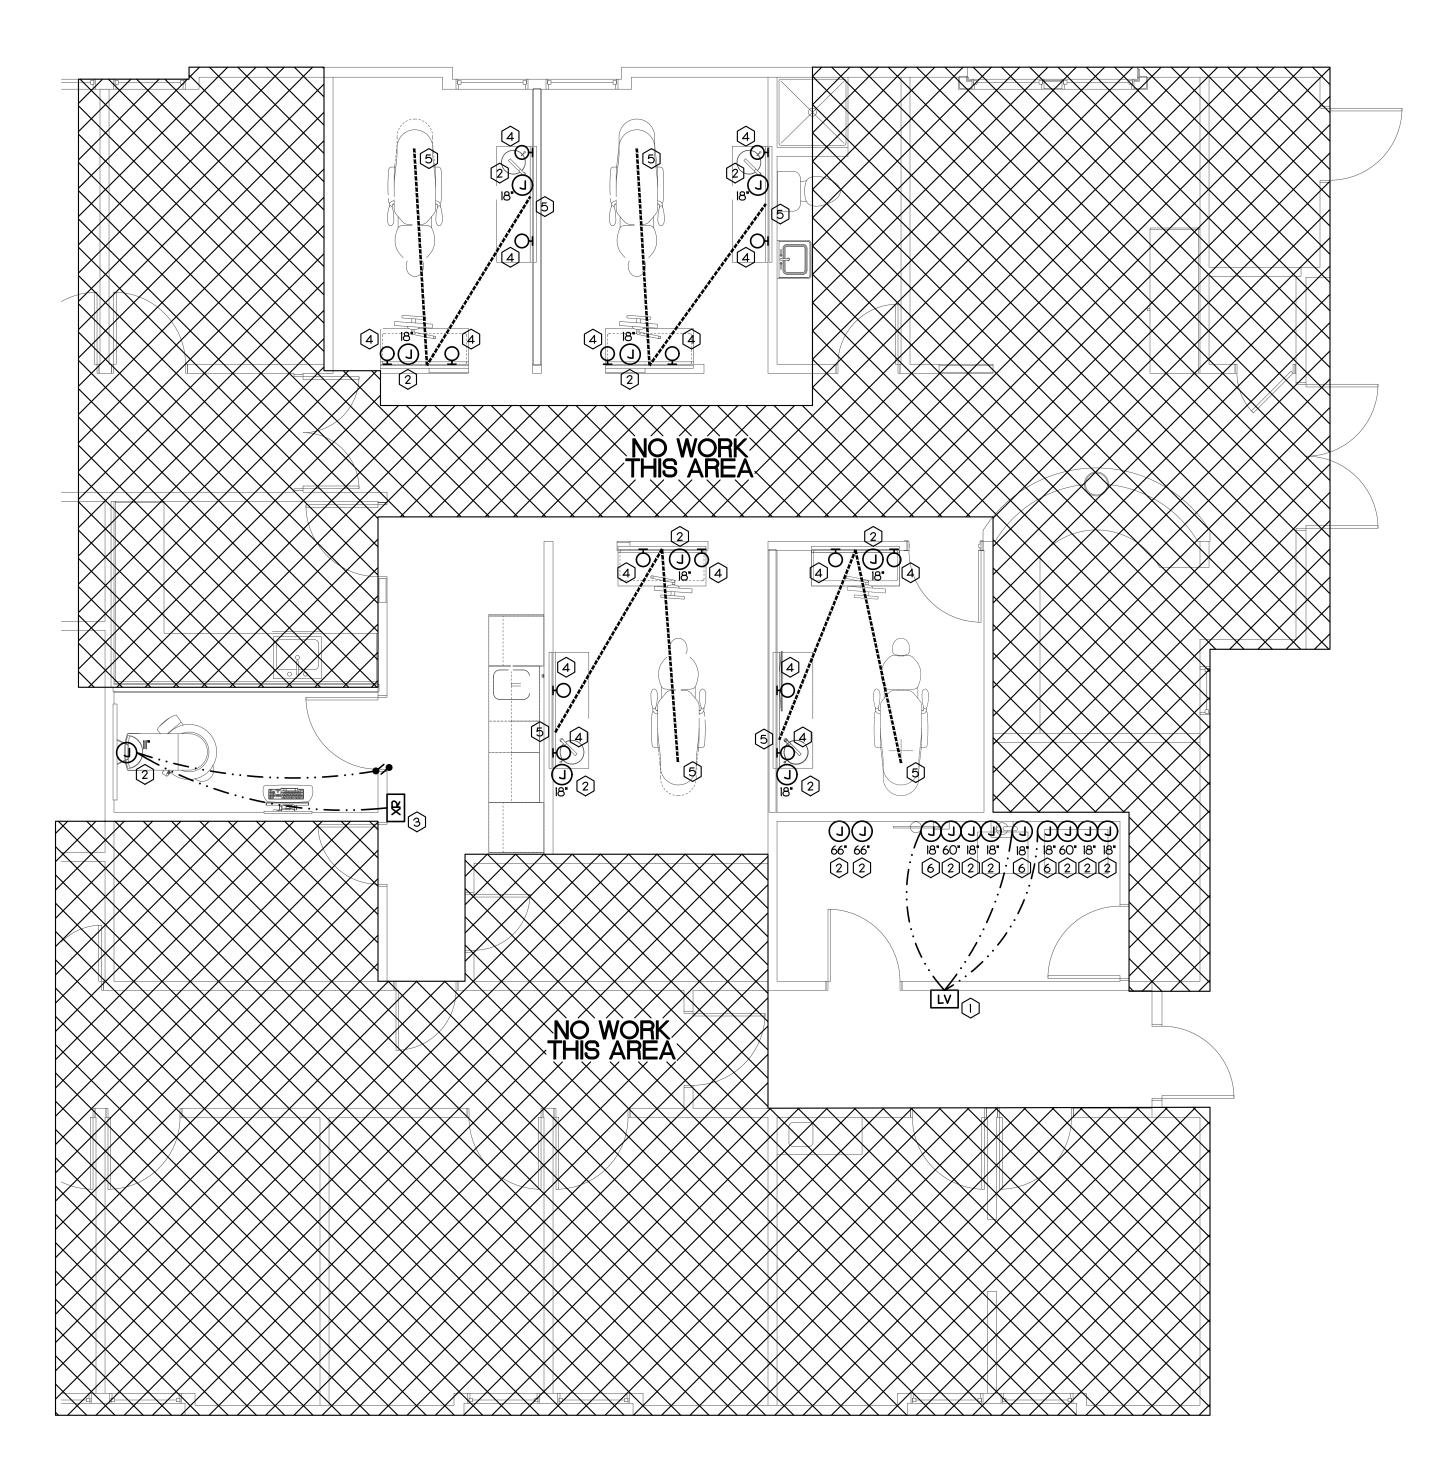

NOTES:

- I. E.C. SHALL OBTAIN THE LATEST SET OF DENTAL EQUIPMENT DRAWINGS BY PATTERSON DENTAL PRIOR TO START OF CONSTRUCTION
- 2. ALL PATIENT CARE AREAS TO MEET REQUIREMENTS OF ARTICLE 517 OF THE NEC
- 3. COORDINATE ALL DENTAL EQUIPMENT LOCATIONS AND CONNECTIONS WITH THE DENTAL EQUIPMENT PROVIDER, OWNER, AND PATTERSON EQUIPMENT SPECIALIST PRIOR TO ROUGH IN.
- 4. E.C. TO CONFIRM SIZES OF ALL JUNCTION BOXES WITH DENTAL PLANS.

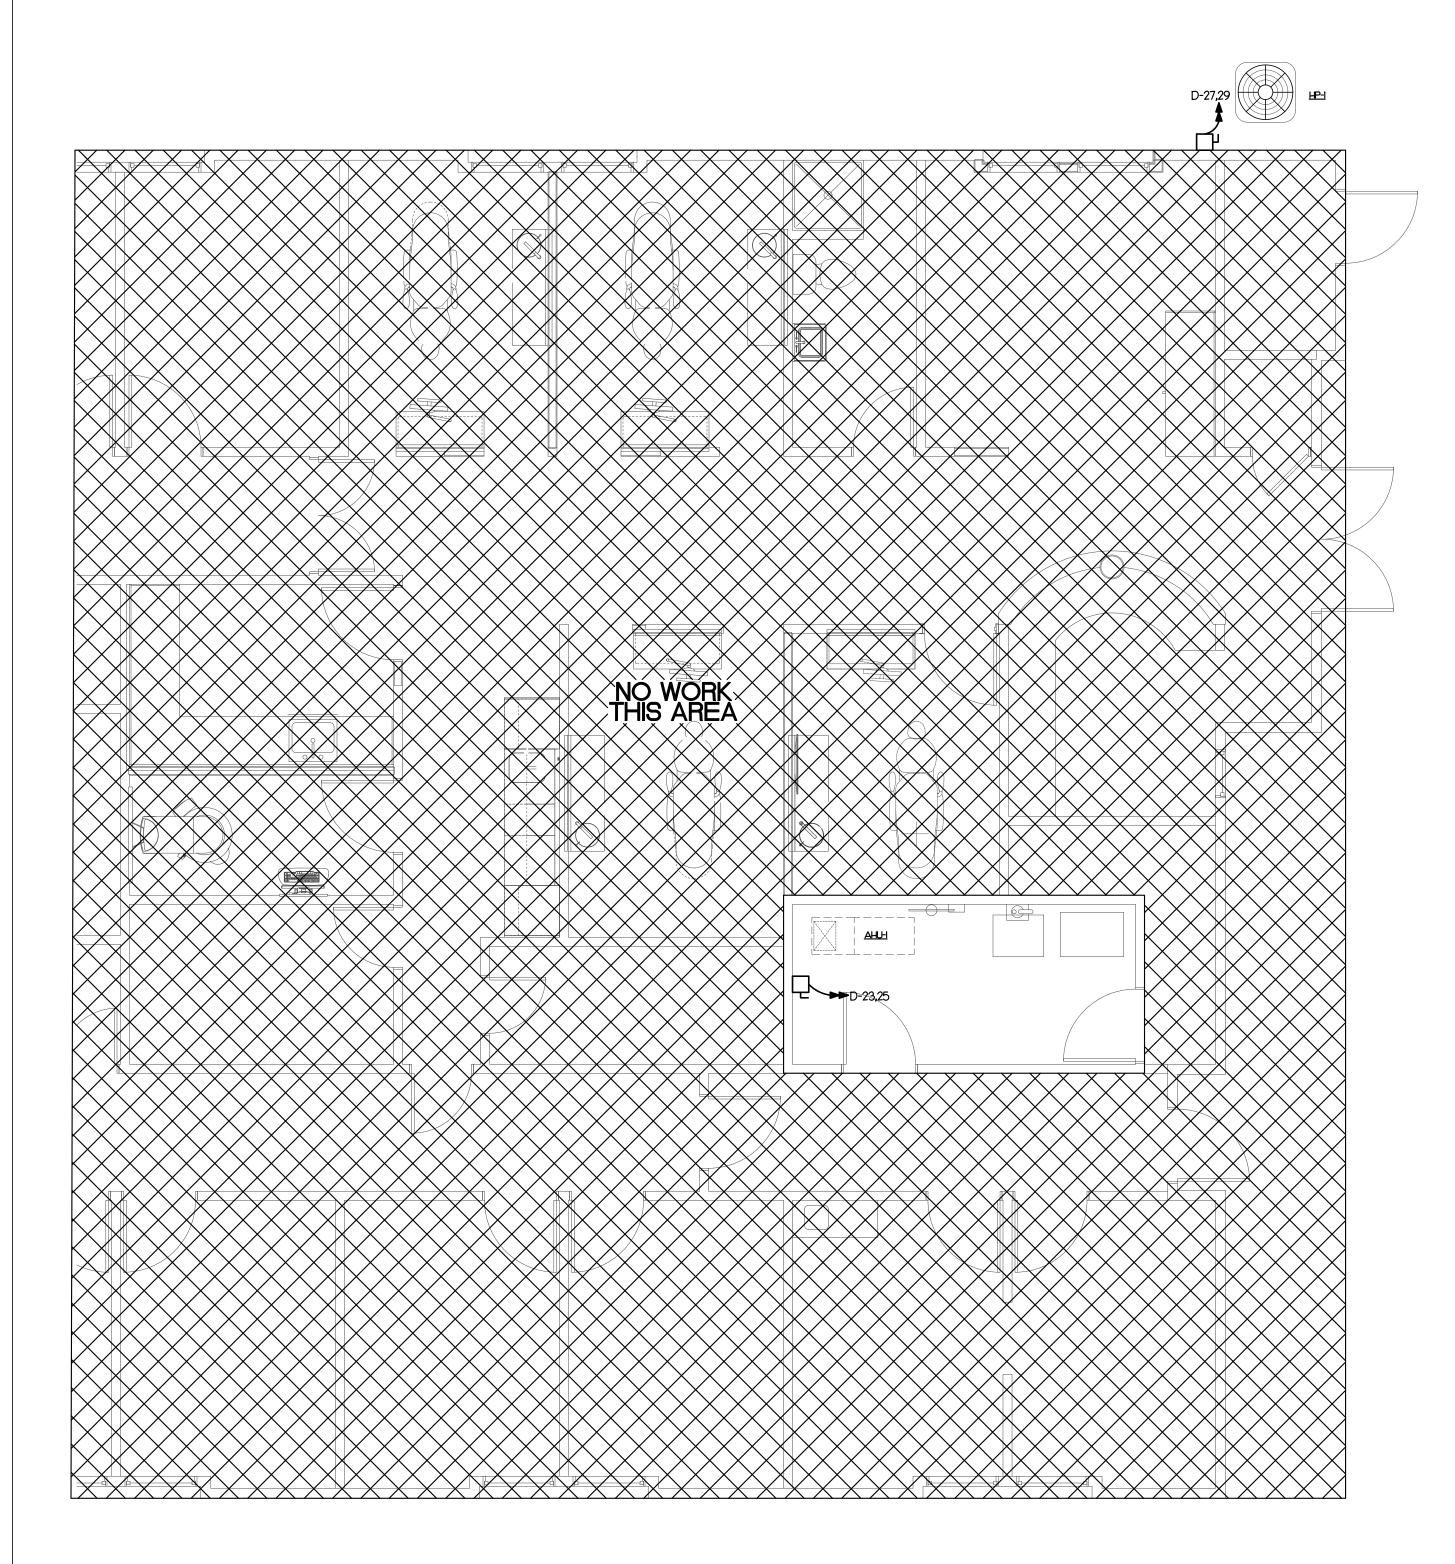



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roject: Community Care Clinic -

Project No: 22027

Location: 425 Health Center Dr. Nags Head, NC

Title: ELECTRICAL PLAN

Date: 01.31.2023

Scale: As indicated

LOW VOLTAGE ELECTRICAL PLAN

The designer shall not be responsible for any error, omission, defect or deficiency in the contract documents ("error") prepared by the designer or its consultants which in any way impacts the schedule of the project, results in a lack of coordination among the contract documents, delays the completion of the project or which in any other way causes any damage or loss to the owner contractor, subcontractors, or other entity involved in the project, unless: (i) designer is promptly notified of such error, in any event within 14 days of the date such error was discovered or could reasonably have been discovered; and (ii) designer is given opportunity at the time of discovery to address such error, and, if appropriate, take such steps as are necessary to correct and resolve it. Failure to comply with the provisions of this paragraph shall constitute a waiver of any claim for damages, or a right to offset against designer by owner, contractor or others and shall in no event cause or allow a reduction in the fees otherwise due designer for services provided on the project.

Revisions:

No.	Description	Date

Designed: SWM

Drawn: SWM

Reviewed: MCB

Cad File:

E103


LOW VOLTAGE PLAN

SCALE: 1/4" = 1'-0"

HVAC POWER PLAN

KEY NOTES

- (1) EXISTING UNDERGROUND SERVICE CONDUCTORS TO REMAIN
- (2) EXISTING UTILITY METER TO REMAIN
- (3) EXISTING SERVICE ENTRANCE CONDUCTORS TO REMAIN
- (4) EXISTING GROUNDING ELECTRODE CONDUCTORS TO REMAIN
- (5) EXISTING FEEDER TO REMAIN
- (6) EXISTING PANEL TO REMAIN. NO WORK TO BE DONE, SHOWN FOR REFERENCE
- (7) EXISTING PANEL TO REMAIN, SEE PANEL SCHEDULE FOR DETAILS
- (8) NEW FEEDER, SEE PANEL SCHEDULE FOR DETAILS
- 9 NEW PANELBOARD, SEE PANEL SCHEDULE FOR DETAILS

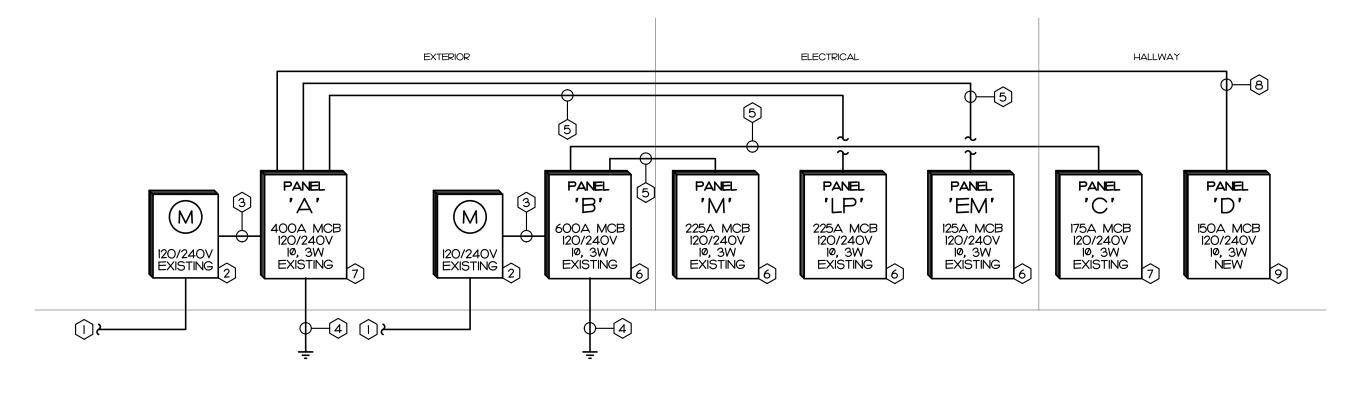


KEY NOTES

- BUCK-BOOST TRANSFORMER PROVIDED BY OTHERS AND INSTALLED BY E.C., FIELD COORDINATE INSTALLATION WITH DENTAL EQUIPMENT SUPPLIER. SEE DENTAL PLANS FOR DETAILS
- PRIMARY SIDE OVERCURRENT PROTECTION FOR BUCK-BOOST TRANSFORMER, PROVIDE A 240V, 20A, 2P FUSED DISCONNECT, GENERAL DUTY DISCONNECT IS ACCEPTABLE, FIELD COORDINATE EXACT LOCATION WITH DENTAL EQUIPMENT SUPPLIER PRIOR TO ROUGH-IN

ENLARGED PLAN - MECH

SCALE: 1/2" = 1'-0"

E.C. TO PROVIDE STRIP LIGHTING AND GFCI SERVICE RECEPTACLE IN ATTIC AS REQUIRED, FIELD COORDINATE SWITCH INSTALLATION NEAR ACESS POINT, CONNECT LIGHTS AND SERVICE RECEPTACLES TO CIRCUIT C-23

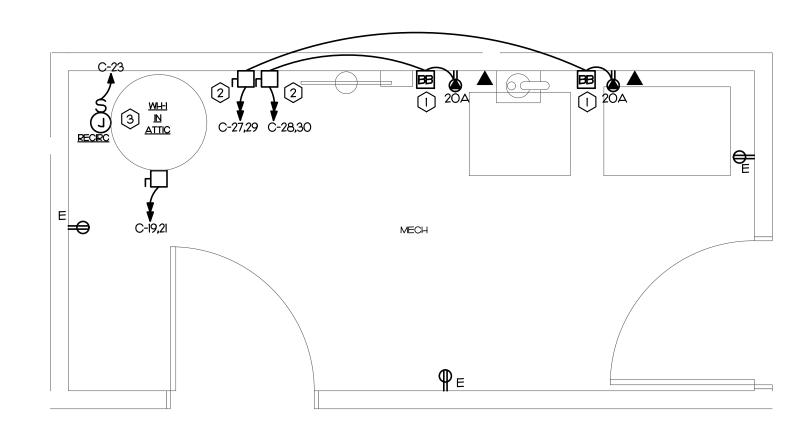

NOTES:

- I. E.C. SHALL OBTAIN THE LATEST SET OF DENTAL EQUIPMENT DRAWINGS BY PATTERSON DENTAL PRIOR TO START OF CONSTRUCTION
- 2. ALL PATIENT CARE AREAS TO MEET REQUIREMENTS OF ARTICLE 517 OF THE NEC
- 4. E.C. TO CONFIRM SIZES OF ALL JUNCTION BOXES WITH DENTAL PLANS.

ARCHITECTS

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Community Care Clinic -

Project No: 22027

Location: 425 Health Center Dr. Nags Head, NC

ELECTRICAL PLAN

Date: 01.31.2023

As indicated

COORDINATE ALL DENTAL EQUIPMENT LOCATIONS AND CONNECTIONS WITH THE DENTAL EQUIPMENT PROVIDER, OWNER, AND PATTERSON EQUIPMENT SPECIALIST PRIOR TO ROUGH IN.

Scale:

Title:

KEY NOTES

(1) E.C. MAY PURCHASE REFURBISHED BREAKER IF NEW BREAKER IS NOT AVAILABLE

POWER RISER

NOT TO SCALE

PANEL	•	A														120/24	ЮV, 1 PHAS	3E, 3 W	/IRE
CKT		DESCRIPTION	I	KVA	С	G	W	CB	CKT	CKT	СВ	W	G	С	KVA		DESCRIPTION		CKT
I_PANE	L 'EM	1*	EXIST	9.0	Е	E	Е	125		2	225	Е	Е	Е	16.2	EXIST	PA	ANEL 'LP'	2
3				9.0			Е	2P	3	4	2P	Е			16.2				4
5_PANE	r .D.		NOTE 2	15.8	2	6	1/0	150	5	6					0.0	_	SPA	CE ONLY	6
7				15.5			1/0	2P	7	8					0.0				8
9 SPAC	E ON	LY		0.0					9	10					0.0		SPA	CE ONLY	10
11				0.0					11	12					0.0				12
DESCRIPTION CONT. LOA RECEPTAC MTRS/COC HEATS	AD D	CONNECTED KVA 0.00 13.IO 3.92 9.60	DEMAND FACTOR 125% 100%/50% 100%	DEMAND KVA 0.00 II.55 3.92 9.60		MAIN	LUGS	ONLY	BUS SIZ , C RATIN						SURFACE NEMA 3R I GROUND B	ENCLOSURE			
WATER HE	ATER		100%	0.00	NOTE	s											CONNECTED	LOADS	\neg
EQUIPMEN	T	55,08	100%	55,08	l. EX	ISTING	FEDE	ERAL I	PACIFIC	: FPE							PHASE A:	41	KVA
KITCHEN E	QUIP.	0.00	65%	0.00	2. E.G	с. то	USE I	EXISTI	NG SPA	RE BRE	AKER						PHASE B:	40.7	KVA
SPECIAL E	Q.	0.00	100%	0.00	3.														
25% OF LA	RGES	T HVAC/MOT	FOR	2.53	4.												TOTAL:	81.7	KVA
TOTAL DE	MAND	·		82.68	5.												DEMAND	344	AMP

PANEL	c														120/2	240V, 1 PHASE, 3 V	VIF
скт г	DESCRIPTION	<u>, </u>	KVA	С	G	w	СВ	СКТ	СКТ	СВ	w	G	С	KVA	1	DESCRIPTION	Та
I AHU		EXIST	4.3	Е	E	Е	45	1	2	35	Е	E	E	3.4	EXIST	Α/0	
3		[4.3			E	2P	3	4	2P	E			3.4	7		
5 EXIT/EM LIG	HTS	EXIST	1.0	Е	Е	Е	20	5	6	30	E	Ш	П	2.9	EXIST	AIR COMPRESSOR	2 (
7 RECEPTACL	.ES	EXIST	I.O	Е	Е	Е	20	7	8	2P	ш	1	-	2.9			Ĩ
9 BATH, HALL		EXIST	I,O	Е	Е	Е	20	9	Ю	20	Ш	ш	E	1.0	EXIST	ATTIC, STORAGE ROOM	1 1
II RECEPTACL	ES	EXIST	I.O	Е	E	Е	20	11	12	20	Е	Е	E	1.0	EXIST	OFFICE I,	2 1
13 SOUTH EXA	M ROOM	EXIST	I,O	E	E	Е	20	13	14	20	E	Е	E	1.0	EXIST	NORTH OFFICE	<u> </u>
15 SECURITY		EXIST	I.O	Е	E	Е	20	15	16	20	E	Е	E	1.0	EXIST	TELEPHONES	3 1
17 SECURITY		EXIST	I,O	Е	E	Е	20	17	18	20	12	12	1/2	0.8	NOTE 4	TREAT I CHAIR	2 1
<u>19</u> WH-1		NOTE 3	2.3	3/4	10	10	30	19	20	20	12	12	1/2	0.8	NOTE 4	TREAT 2 CHAIR	2 2
21			2,3			10	2P	21	22	20	12	12	1/2	0.8	NOTE 4	TREAT 3 CHAIR	2 2
23 RECIRC PUN	/IP	NOTE 3	0.3	1/2	12	12	20	23	24	20	12	12	1/2	0.8	NOTE 4	DENTAL CHAIR	2 2
25 SPACE ONL	.Υ		0.0					25	26					0,0		SPACE ONLY	r 2
<u>27</u> BUCK BOOS	ST XFMR	NOTE 3	1.2	1/2	12	12	20	27	28	20	12	12	12	1.2	_NOTE 3	BUCK BOOST XFMF	2 2
29			1.2			12	2P	29	30	2P	12			1,2			3
DESCRIPTION (CONNECTED	DEMAND	DEMAND	1	225 A	MININ	MIM E	IUS SIZ	F					SURFACE	MOUNTING	;	
	KVA	FACTOR	KVA		175 A	MAIN	CIRCI	JIT BRE	- EAKER					NEMA I EN	ICLOSURE		
CONT, LOAD	0.00	125%	0.00	1				RATI						GROUND E			
RECEPTACLE	11.00	100%/50%	10.50	1													
MTRS/COOLS	21,12	80%	16,90	1													
HEATS	0.00	100%	0.00														
WATER HEATER	4.50	100%	4.50	NOTE	s											CONNECTED LOADS	
EQUIPMENT	8.46	100%	8.46	l. EX	ISTING	squ.	ARE D	QOL	0							PHASE A: 22.9	9 K
KITCHEN EQUIP.	0.00	65%	0.00	2. E	' DEN	OTES	EXIS1	ING BE	PANCH (CIRCUI	т то	REMA	.IN			PHASE B: 22.	2 K
SPECIAL EQ.	0.00	100%	0.00	3. E.	с. то	PRO\	/IDE N	EW BR	EAKER								
25% OF LARGEST	HVAC/MO	TOR	0.00	4. E.	с. то	PRO\	/IDE N	EW GF	CI BREA	KER						TOTAL: 45	١K
TOTAL DEMAND			40.36	5.												DEMAND 168	3 AN

A DE	ESCRIPTION	Скт
1	ESCRIPTION LATHE	
	LAB CABINETS	
5 NOTE 2	LAB RECEPTACLES	_
B 14012 2	LAB TRIMMER	
4	PAN KEYBOARD	+ -
·	TERILIZATION CABINET	
	JLTRASONIC CLEANER	
NOTE 2	STERALIZER	
6 NOTE 2	HANDPIECE MAINT	. 18
2	REC EXTERIOR	20
2	REC HALLWAY	r 22
4	REC RECEPTION	V 24
<u> </u>	SPACE ONLY	r 26
)	SPACE ONLY	r 28
)	SPACE ONLY	
)	SPACE ONLY	r 32
)	SPACE ONLY	
)	SPACE ONLY	Y 42
ACE MOUNTING		
I ENCLOSURE		
ND BAR		
C	CONNECTED LOADS	_
P	PHASE A: 15.8	3 KVA
P	<u> </u>	5 KVA
L		
		PHASE B: 5.

POWER RISER PANEL SCHEDULES

The designer shall not be responsible for any error, omission, defect or deficiency in the contract documents ("error") prepared by the designer or its consultants which in any way impacts the schedule of the project, results in a lack of coordination among the contract documents, delays the completion of the project or which in any other way causes any damage or loss to the owner, contractor, subcontractors, or other entity involved in the project, unless: (i) designer is promptly notified of such error, in any event within 14 days of the date such error was discovered or could reasonably have been discovered; and (ii) designer is given opportunity at the time of discovery to address such error, and, if appropriate, take such steps as are necessary to correct and resolve it. Failure to comply with the provisions of this paragraph shall constitute a waiver of any claim for damages, or a right to offset against designer by owner, contractor or others and shall in no event cause or allow a reduction in the fees otherwise due designer for services provided on the project.

Revisions:

No.	Description	Date

Designed: SWM Drawn: SWM Reviewed: MCB Cad File:

E201

PANEL SCHEDULE

GENERAL NOTES SYMBOL LEGEND <u>SYMBOL</u> **DESCRIPTION** <u>REMARKS</u> THE CONTRACTOR SHALL REFER TO THE ARCHITECTURAL PLANS FOR FLOOR PLAN DIMENSIONS, DO NOT SCALE THESE DRAWINGS. 2 X 4 SURFACE FIXTURE - LETTER DESIGNATES TYPE SEE FIXTURE SCHED. THE ELECTRICAL CONTRACTOR SHALL COORDINATE ANY AND ALL WORK WITH OTHER TRADES INVOLVED IN THE PROJECT, PRIOR TO THE INSTALLATION OF HIS EQUIPMENT SO AS TO AVOID 2 X 2 SURFACE FIXTURE - LETTER DESIGNATES TYPE SEE FIXTURE SCHED. CONFLICTS DURING CONSTRUCTION AND TO ALLOW FOR OPTIMUM MAINTENANCE AND WORKING SPACE. USE OF THE CONDUIT SYSTEM FOR EQUIPMENT GROUNDING SHALL NOT BE ACCEPTABLE. A SEPARATE PENDANT/SURFACE MOUNT FIXTURE - LETTER DESIGNATES TYPE SEE FIXTURE SCHED. GREEN GROUND WIRE SHALL BE RUN WITH THE CIRCUIT CONDUCTORS IN EACH CONDUIT. 4. ALL BREAKER SIZES, SHOWN FOR MECHANICAL EQUIPMENT, SHALL BE VERIFIED BEFORE THE PURCHASE OR INSTALLATION OF SAID EQUIPMENT, WITH THE EQUIPMENT SUPPLIER AND THE MECHANICAL EMERGENCY WITH EXIT LIGHT - CONNECT UNSWITCHED SEE FIXTURE SCHED. BATTERY BACKUP EMERGENCY LIGHT - CONNECT UNSWITCHED SEE FIXTURE SCHED. 5. ALL WORK AND MATERIAL SHALL BE PROVIDED IN ACCORDANCE WITH THE STATE, LOCAL AND NATIONAL CODES, ORDINANCES AND 2020 NATIONAL ELECTRICAL CODE (NFPA 70). EXISTING 2 X 4 FIXTURE TO REMAIN **EXISTING** 6. EACH CONTRACTOR SHALL PROVIDE HIS OWN SUPPORT OF ALL DEVICES AND EQUIPMENT PROVIDED BY HIM AND SHALL SUPPORT SUCH EQUIPMENT PER APPROVED GOVERNING CODES OR PER APPROVAL OF THE ENGINEER. UNACCEPTABLE WORKMANSHIP OR MATERIALS SHALL BE REPLACED AT THE REQUEST EXISTING EMERGENCY WITH EXIT LIGHT TO REMAIN **EXISTING** OF THE ENGINEER AT THE CONTRACTOR'S EXPENSE. 7. THE MOUNTING HEIGHTS AND LOCATIONS OF ALL WALL MOUNTED OUTLETS AND JUNCTION BOXES EXISTING 2 X 4 LAY-IN FIXTURE TO BE REMOVED **EXISTING** SHALL BE REVIEWED AND COORDINATED WITH THE ARCHITECT, PRIOR TO INSTALLATION FOR USE WITH THE ACTUAL EQUIPMENT, CASEWORK, AND MILLWORK TO BE FURNISHED. EXISTING CAN LIGHT FIXTURE TO BE REMOVED **EXISTING** 8. THE ELECTRICAL CONTRACTOR SHALL PROVIDE ALL NECESSARY DISCONNECTS, SWITCHES, AND RECEPTACLES UNDER THE ELECTRICAL BID AND SHALL INCLUDE ALL NECESSARY CIRCUITS TO AND FINAL CONNECTIONS TO THE EQUIPMENT PROVIDED BY ALL SUPPLIERS, SEE DETAILS FOR CONNECTION TO EQUIPMENT PROVIDED BY MECHANICAL AND PLUMBING CONTRACTORS EXISTING EXIT LIGHT TO BE REMOVED EXISTING EXISTING EMERGENCY LIGHT TO BE REMOVED **EXISTING** • WHERE ELECTRICAL EQUIPMENT PENETRATES RATED WALLS AND CEILINGS, EXTERIOR WALLS, THEY SHALL BE PROPERLY SEALED PER APPROVED UL METHODS. WHERE ELECTRICAL EQUIPMENT PENETRATES EXTERIOR WALLS, THEY SHALL BE PROPERLY SEALED. HUBBELL 1221-** WITH WITH METHODS APPROVED BY THE ENGINEER, SUBMIT DETAIL OF PROPOSED SEALING METHODS, MOUNT 42" A.F.F. UNLESS NOTED OTHERWISE. NPJI COVER PLATE 10. ALL PERMITS AND INSPECTION FEES SHALL BE SECURED AND PAID BY THE ELECTRICAL CONTRACTOR. HUBBELL 1223-** WITH MOUNT 42" A.F.F. UNLESS NOTED OTHERWISE. NPJI COVER PLATE II. ALL WORK SHALL BE PERFORMED BY A LICENSED ELECTRICAL CONTRACTOR, WALL MOUNTED OCCUPANCY SENSOR SWITCH, DUAL TECHNOLOGIES, MOUNT 42" A.F.F. UNLESS NOTED OTHERWISE. 800W/120VAC OR 1200W/277VAC WATTSTOPPER DSW-30I-** 12. THE CONTRACTOR SHALL PROVIDE COMPLETE UPDATED TYPEWRITTEN PANEL SCHEDULES FOR ALL NPJ26 COVER PLATE LUTRON DVSTV-XX 13. AS BUILT DRAWINGS SHALL BE GIVEN TO THE OWNER AT THE COMPLETION OF THE PROJECT O-IOV DIMMING. MOUNT 42" A.F.F. UNLESS NOTED OTHERWISE. NPJ26 COVER PLATE PROVIDE SWITCHED WIRE AND 0-10V CONTROL WIRE TO FIXTURE AS REQUIRED. 14. THE CONTRACTOR SHALL VERIFY THE CEILING TYPES WITH THE GENERAL CONTRACTOR PRIOR TO THE PURCHASE OF ANY LIGHT FIXTURES SO THAT THE PROPER TRIM WILL BE PROVIDED FOR ALL FIXTURES. CEILING MOUNTED OCCUPANCY SENSOR, DUAL TECHNOLOGIES. LOW VOLTAGE. PROVIDE LOW VOLTAGE WIRING TO POWER PACK AS REQUIRED. SENSORWORX SWX-222-I ANY DIFFERENCES WILL BE THE RESPONSIBILITY OF THIS CONTRACTOR. 28 FT. RADIUS 15. ALL WIRE SIZES INDICATED ON THE PANEL SCHEDULES ARE BASED ON 75 DEGREE COPPER THIN/THWN WIRE. ALL WIRE TERMINALS AND EQUIPMENT SHALL BE LISTED AND APPROVED FOR 75°C. ONLY THWN-2 POWER PACK FOR LOW VOLTAGE OCCUPANCY SENSOR. SENSORWORX SWX-900 WIRE SHALL BE INSTALLED IN WET AND EXTERIOR LOCATION. 120/277VAC, 20A I POLE CONTACTOR. 16. MINIMUM CONDUIT SIZE SHALL BE 1/2" AND MINIMUM WIRE SIZE SHALL BE #12 AWG. **EXISTING** EXISTING SWITCH TO REMAIN 17. ARMORED CABLE (TYPE AC) AND METAL-CLAD CABLE (TYPE MC) ARE ACCEPTABLE WIRING METHODS SUBJECTED TO THE FOLLOWING RESTRICTIONS: EXISTING SWITCH TO BE REMOVED **EXISTING** SEE NEC 320 AND 330 FOR RESTRICTION. • PENETRATIONS OF RATED WALLS SHALL BE IN ACCORDANCE WITH APPROVED UL PENETRATION SPECIFICATION GRADE DUPLEX TAMPER RESISTANT RECEPTACLE. HUBBELL HBL5362-**-TR WITH CABLE SHALL NOT BE USED FOR HOME RUN TO PANEL BOARD. CABLE SHALL ONLY BE INSTALLED IN CONCEALED SPACE AND FURRED AREAS. MAX. LENGTH OF EACH SECTION IN ACCESSIBLE CONCEALED CEILING SPACES SHALL NOT EXCEED IO FT. WHERE REQUIRED BY NEC 517.13, CABLE SHALL BE LISTED FOR THE USE. MOUNT 16" A.F.F. UNLESS OTHERWISE NOTED. NPJ8 COVER PLATE SPECIFICATION GRADE TAMPER RESISTANT GFCI RECEPTACLE HUBBELL GFTRST20-** WITH MOUNT 16" A.F.F. UNLESS NOTED OTHERWISE. NPJ26 COVER PLATE THE MAXIMUM NUMBER OF HOMERUNS IN A CONDUIT SHALL NOT EXCEED THREE (3). FEEDING CIRCUITS SPECIFICATION GRADE DUPLEX TAMPER RESISTANT RECEPTACLE. HUBBELL HBL5362-**-TR WITH WITH SHARED NEUTRAL SHALL BE SWITCHED TOGETHER. MOUNT 16" A.F.F. UNLESS OTHERWISE NOTED. NPJ8 COVER PLATE FED FROM GFCI CIRCUIT BREAKER, 20. WHERE OUTLETS ARE SHOWN BACK TO BACK ON RATED WALLS, STAGGER OUTLETS SO THAT THEY ARE SEPARATED BY A MINIMUM OF 24". SPECIFICATION GRADE DUPLEX TAMPER RESISTANT RECEPTACLE HUBBELL HBL5362-**-TR WITH 21. ALL DISCONNECTS SHALL HAVE SEPARATE NEUTRAL AND GROUND BARS. MOUNT 4" ABOVE COUNTER/BACKSPLASH, NPJ8 COVER PLATE SPECIFICATION GRADE QUAD TAMPER RESISTANT RECEPTACLE HUBBELL (2) HBL5362-**-TR WITH 22, BOXES AND CONDUITS SHALL NOT BE INSTALLED RECESSED IN A 3-HOUR OR HIGHER RATED WALL NPJ82 COVER PLATE WHEN OUTLETS ARE INDICATED ON THESE WALLS, FIELD COORDINATE CONDUIT AND BOX INSTALLATION. MOUNT 16" A.F.F. UNLESS OTHERWISE NOTED. HUBBELL GFTWRST20-** 23. FOR ALL RECEPTACLES LOCATED ABOVE COUNTER TOP, MOUNTING HEIGHT SHALL COMPLY WITH ANSI AII7.I, SECTION 308. E.C. SHALL FIELD VERIFY CASEWORK DETAIL WITH ARCHITECT PRIOR TO ROUGH-IN. SPECIFICATION GRADE TAMPER RESISTANT, WEATHER RESISTANT AND WITH WP26M COVER PLATE GFCI DUPLEX RECEPTACLE WITH IN-USE WEATHER PROOF COVER. MOUNT 16" A.F.F. UNLESS OTHERWISE NOTED. 24. THE ELECTRICAL CONTRACTOR SHALL BE RESPONSIBLE FOR A COMPLETE ELECTRICAL DEMOLITION SPECIFICATION GRADE QUAD TAMPER RESISTANT GFCI RECEPTACLE HUBBELL (2) GFTRST20-** WITH NOTED OR IMPLIED ON THESE PLANS. MOUNT 16" A.F.F. UNLESS OTHERWISE NOTED. NPJ82 COVER PLATE 25. ALL ABANDONED AND UNUSED CABLES IN HOLLOW SPACES, VERTICAL SHAFTS, AND VENTILATION OR 'AMP' 250 VOLT RECEPTACLE WITH GROUND, 'AMP' DESIGNATED RATING HUBBELL TO MATCH AIR-HANDLING DUCTS SHALL BE REMOVED PER NEC 725.25, 760.25, 770.25, 800.25, 820.25 AND 830.25. FIELD VERIFY NUMBER OF POLE AND NEUTRAL EQUIPMENT MOUNT 16" A.F.F. UNLESS OTHERWISE NOTED. 26. PRIOR TO CONNECTING ANY NEW RECEPTACLES TO EXISTING CIRCUITS, THE ELECTRICAL CONTRACTOR SHALL FIELD VERIFY THAT NO MORE THAN 10 RECEPTACLES ARE CONNECTED TO A 20 AMP CIRCUIT. TAMPER RESISTANT RECEPTACLE AND DATA OUTLET IN FLUSH AFTER RECONNECTING ALL NEW AND RELOCATED LIGHT FIXTURES THE ELECTRICAL CONTRACTOR EQUIPMENT SUPPLIER SHALL MEASURE THE CONNECTED LOAD FOR EACH LIGHTING CIRCUIT TO INSURE THAT NO MORE THAN 16 AMPS IS CONNECTED TO A 20 AMP CIRCUIT. THE CONTRACTOR SHALL NOTIFY THE ENGINEER IF O FLOOR BOX WITH FLAP COVER. FIELD COORDINATE WITH DENTAL EQUIPMENT. PROVIDE COVER TO MATCH FLOOR TYPE PER ARCHITECT INSTRUCTION, CUT AND PATCH FLOOR AS REQUIRED. EITHER OF THE ABOVE CONDITIONS CAN NOT BE ACHIEVED. EXISTING DUPLEX RECEPTACLE TO REMAIN **EXISTING** 27. THE ELECTRICAL CONTRACTOR IS RESPONSIBLE FOR MAINTAINING CIRCUIT CONTINUITY TO ALL LIGHTING, DEVICES AND EQUIPMENT NOT SUBJECT TO REMOVAL. PROVIDE ADDITIONAL CONDUIT AND WIRING AS **EXISTING** EXISTING QUAD RECEPTACLE TO REMAIN 28. RELOCATE AS NECESSARY ALL EXISTING CIRCUITS FOUND PASSING THROUGH THE AREA OF CONSTRUCTION, AND WHICH ARE PRESENTLY IN USE IN OTHER PARTS OF THE BUILDING UNAFFECTED BY THIS PROJECT PHASE, TO MAINTAIN THE CONTINUITY OF SERVICE AND GROUNDING, AND TO CONCEAL EXISTING DUPLEX RECEPTACLE TO BE REMOVED **EXISTING** 29. WHERE EXISTING EQUIPMENT AND DEVICES SHALL BE REMOVED, THE CONTRACTOR SHALL REMOVE ALL THE ASSOCIATED CONDUIT AND CONDUCTORS THAT SHALL NOT REMAIN IN OPERATION BACK TO THEIR RESPECTIVE SOURCE OR TO THE POINT ON A SHARED CIRCUIT FROM WHERE THE EQUIPMENT OR **EXISTING** EXISTING QUAD RECEPTACLE TO BE REMOVED CEILING PANEL CABINET FAN. FURNISHED AND INSTALLED BY M.C., WIRED BY E.C. SEE MECH, PLAN, 30. FACILITY DESIGN IS FOR A DOCTOR OFFICE, GENERAL PRACTITIONER, DESIGN IS NOT FOR A HOSPITAL, JUNCTION BOX SIZED PER N.E.C. NURSING HOME OR AMBULATORY CARE FACILITY. NO SPECIAL POWER SYSTEMS HAVE BEEN DESIGNED DISCONNECT SWITCH SEE PLANS FOR SIZE AND TYPE SQUARE D HEAVY DUTY 31. PER NEC 517.33, THERE IS NOT A REQUIREMENT FOR A CRITICAL POWER BRANCH IN THIS FACILITY 32. WIRING IN ALL EXAM ROOMS AND PATIENT CARE AREAS SHALL COMPLY WITH NEC 517,13. PER N.E.C. NEW CONCEALED WIRING 33, NO INVASIVE PROCEDURES OR PROCEDURES THAT IF INTERRUPTED SHOULD THREATEN A PATIENTS LIFE PER N.E.C. LOW VOLTAGE WIRING 34. THERE ARE NO OVERNIGHT STAYS IN ANY BEDROOMS IN THIS FACILITY. PER N.E.C. UNSWITCHED LIGHTING CONDUCTOR 35. INHALATION ANESTHESIAS ARE NOT ADMINISTRATED. HOME RUN TO PANEL BOARD PER N.E.C. NUMBERS OF ARROW INDICATE CIRCUITS 120/240V 10, 3W PANEL BOARD - SEE PANEL SCHEDULES SQUARE D NQ/I-LINE MEDICAL FACILITY NOTES: EXISTING UTILITY METER BASE TO REMAIN SEE POWER RISER FACILITY DESIGN IS FOR A DOCTOR OFFICE, GENERAL PRACTITIONER, DESIGN IS NOT FOR A HOSPITAL, NURSING HOME OR AMBULATORY CARE FACILITY. BY OTHERS 120/220V BUCK-BOOST TRANSFORMER NO SPECIAL POWER SYSTEMS HAVE BEEN DESIGNED FOR PATIENT COMMUNICATION OUTLET - MOUNT 16" A.F.F. UNLESS OTHERWISE NOTED STUB 3/4" CONDUIT TO ACCESSIBLE CEILING OR ATTIC SPACE. SINGLE GANG BOX HUBBELL NPJ13 COVER 2. PER NEC 517.33, THERE IS NOT A REQUIREMENT FOR A CRITICAL POWER BRANCH OUTLET, COVER PLATE AND WIRING BY OTHERS. IN THIS FACILITY. **EXISTING** 3, WIRING IN ALL EXAM ROOMS AND PATIENT CARE AREAS SHALL EXISTING COMMUNICATION OUTLET TO REMAIN COMPLY WITH NEC 517.13, ABOVE FINISHED CEILING 4. NO INVASIVE PROCEDURES OR PROCEDURES THAT IF INTERRUPTED SHOULD THREATEN A PATIENTS LIFE ARE PERFORMED. A.F.F. ABOVE FINISHED FLOOR - NOTE ALL MOUNTING DIMENSIONS 5. THERE ARE NO OVERNIGHT STAYS IN ANY BEDROOMS THIS FACILITY. GIVEN ARE TO THE BOTTOM OF THE OUTLET BOX 6. INHALATION ANESTHESIAS ARE NOT ADMINISTRATED. SEE DENTAL PLANS ELECTRONIC INTERLOCK DOOR SWITCH, LOCATE BETWEEN DOOR PANEL AND FRAME, SEE DENTAL PLANS FOR DETAILS VERTICAL CONDUIT IN WALL, E.C. TO VIELD VERIFY EXACT LOCATION WITH ARCHITECT PRIOR TO ROUGH-IN SEE DENTAL PLANS SWITCH FOR LOW VOLTAGE SYSTEM. SEE DENTAL PLANS FOR DETAILS SEE DENTAL PLANS XR X-RAY REMOTE EXPOSURE BUTTON SEE DENTAL PLANS PER N.E.C. NEW UNDER SLAB EMT CONDUIT PER DENTAL DRAWINGS

2018 NORTH CAROLINA **ENERGY CODE**

ELECTRICAL SYSTEM AND EQUIPMENT METHOD OF COMPLIANCE: PRESCRIPTIVE LIGHTING SCHEDULE: FLUORESCENT T8/T5 LAMP TYPE REQUIRED NUMBER OF LAMPS: N/A SEE N/A N/A BALLAST TYPE USED: N/A FIXTURE N/A NUMBER OF BALLASTS: N/A N/A SCHEDULE N/A TOTAL WATTAGE N/A N/A N/A PER FIXTURE:

	SPECIFIED	ALLOWED BY CODE
INTERIOR WATTAGE		
HEALTH CARE	V	2407
TOTAL	872	2165 **

NOTES:


- ** PER SECTION C406.3, THE WHOLE AREA ALLOWED BY CODE IS REQUIRED TO BE 10% LOWER THAN THOSE CALCULATED PER SECTION C405.4.2.

 • VALUE CALCULATE PER SECTION C405.4.2: 2407 WATTS • VALUE CALCULATE PER SECTION C405.4.2:
- 2. ALL EXTERIOR LIGHTS: NOT INCLUDED IN PROJECT.

VALUE PER SECTION C406.3:


THE BEST OF MY KNOWLEDGE AND BELIEF, THE DESIGN OF THIS BUILDING COMPLIES WITH THE ELECTRICAL SYSTEM AND EQUIPMENT REQUIREMENTS OF THE NORTH CAROLINA STATE BUILDING CODE, 2018 - ENERGY.



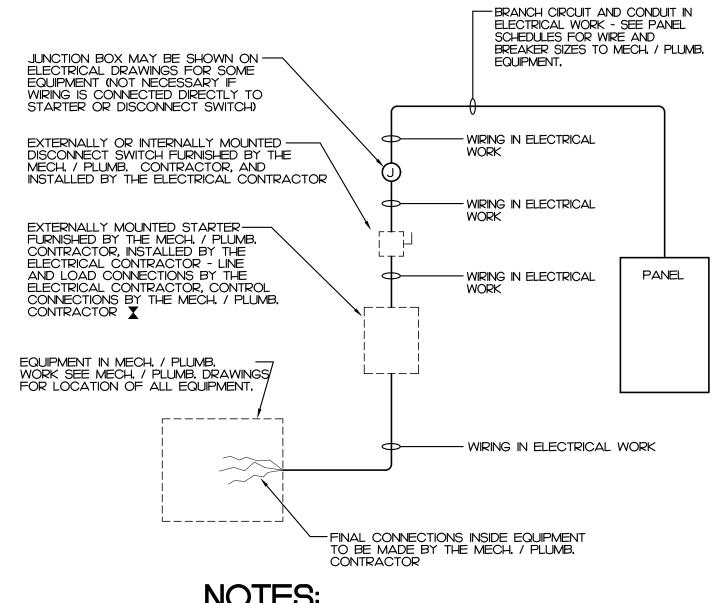

- 2. E.C. SHALL FURNISH ALL REQUIRED FUSES.

WIRING TO MECHANICAL AND PLUMBING EQUIPMENT NOT TO SCALE

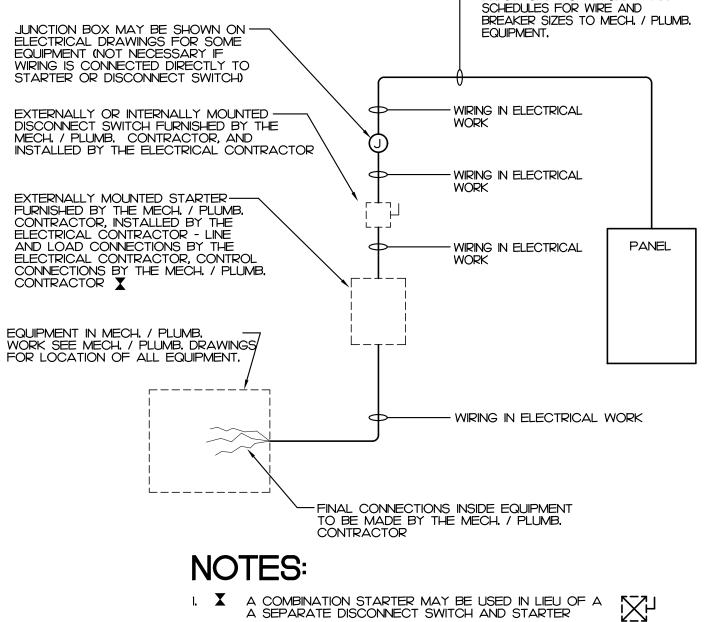

LIGHT FIXTURE SCHEDULE DESCRIPTION CATALOG ELECTRICAL DATA NOTES 4000 LUMEN LED, 3500K ELECTRONIC DRIVER 2x4 LED SURFACE MOUNT FIXTURE 4000 LUMEN WITH SURFACE MOUNTING KIT CPANL-2X4-ALO6-SWW7-M2 45 WATTS - 50 VA, 120V MOUNTING KIT: 2X4SMKSH 2x4 LED SURFACE MOUNT FIXTURE 4000 LUMEN WITH SURFACE MOUNTING KIT CPANL-2X4-ALO6-SWW7-M2 ELECTRONIC DRIVER 45 WATTS - 50 VA, 120V MOUNTING KIT: 2X4SMKSH AND BATTERY BACKUP BATTERY: ILBLP-CPIO-HE-SD-A 2x2 LED SURFACE MOUNT FIXTURE 3300 LUMEN WITH SURFACE MOUNTING KIT CPANL-2X2-ALOI-SWW7-M4 ELECTRONIC DRIVER MOUNTING KIT: 2X2SMKSH 31 WATTS - 34 VA, 120V C DECORATIVE PENDANT SELECTED BY ARCHITECT: 30 WATT MAXIMUM, 120V PROVIDE \$500 ALLOWANCE EMERGENCY WITH EXIT LIGHT 5 WATTS - 5 VA, 120-277V LHQM-SD LITHONIA: ELM2L-SDRT EMERGENCY LIGHT 2 WATTS - 2 VA, I2O-277V

- SEE ARCHITECTURAL PLAN FOR MOUNTING LOCATION AND HEIGHT. FIELD COORDINATE MOUNTING HEIGHT WITH ARCHITECT IF NOT SHOWN ON ARCHITECTURAL
- 3. E.C. SHALL FIELD VERIFY LED COLOR WITH ARCHITECT PRIOR TO ORDERING.

SYMBOL LEGEND GENERAL NOTES **DETAILS** FIXTURE SCHEDULE

ARCHITECTS

3221 BLUE RIDGE ROAD, SUITE 113

ATLANTEC

ENGINEERS PA

No. C-961

SEAL (048828

Community Care Clinic -

425 Health Center Dr.

ELECTRICAL PLAN

Nags Head, NC

01.31.2023

As indicated

22218

Nags Head, North Carolina 27959

P.252.441.0271F.252.441.8724

E.office@obxarchitects.com

RALEIGH, NC 27612

Project No: 22027

Title:

Date:

(919) 571-1111

118 West Woodhill Drive

The designer shall not be responsible for any error, omission. defect or deficiency in the contract documents ("error") prepared by the designer or its consultants which in any way impacts the schedule of the project, results in a lack of coordination among the contract documents, delays the completion of the project or which in any other way causes any damage or loss to the owner contractor, subcontractors, or other entity involved in the project, unless: (i) designer is promptly notified of such error, n any event within 14 days of the date such error was discovered or could reasonably have been discovered; and (ii) designer is given opportunity at the time of discovery to address such erro and, if appropriate, take such steps as are necessary to correct and resolve it. Failure to comply with the provisions of this paragraph shall constitute a waiver of any claim for damages, or a right to offset against designer by owner, contractor or others and shall in no event cause or allow a reduction in the fees otherwise due designer for services provided on the project.

Revisions:

No.	Description	Date

Designed: SWM Drawn: SWM Reviewed: MCB

Cad File:

E30

TYPE

2. E.C. SHALL SUBMIT CATALOG TO ARCHITECT FOR APPROVAL PRIOR PURCHASE ANY. FINISH COLOR AND TRIM SUBJECT TO BE CHANGED PER ARCHITECT.

Sheet List					
Sheet Number	Sheet Name				
DA001	GENERAL NOTES				
DA111	LVL 1 FLOOR PLAN				
DA113	LVL 1 BACKING PLAN				
DB110	LVL 1 DENTAL UTILITIES IN FLOOR				
DE110	LVL 1 ELECTRICAL & LOW VOLTAGE				
DP110	LVL 1 PLUMBING				

ABBREVIATION LEGEND

AFF	ABOVE FINISHED FLOOR
DR	SUPPLIED BY DOCTOR
EC	ELECTRICAL CONTRACTOR
ER	EXISTING RELOCATED
EX	EXISTING
FT	FUTURE
GC	GENERAL CONTRACTOR
MTD	MOUNTED
NC	NO CHANGE
NIC	NOT INCLUDED
NIS	NOT IN SCOPE
NW	NEW
PC	PLUMBING CONTRACTOR
PD	PATTERSON DENTAL
TYP	TYPICAL
VFY	VERIFY
VIF	VERIFY IN FIELD

DETAILS

PATTERSON DENTAL:

PATTERSON DENTAL'S RESPONSIBILITIES WILL INCLUDE BUT NOT BE LIMITED TO THE FOLLOWING:

- PATTERSON DENTAL WILL PROVIDE A SET OF DENTAL SPECIFIC SHOP DRAWINGS TO AID THE CONTRACTOR AND/OR ARCHITECT OF THE OWNER'S CHOOSING IN THE CONSTRUCTION OF THE OWNER'S DENTAL OFFICE. THESE DRAWINGS WILL PROVIDE CRITICAL DENTAL LOCATIONS OF ALL DENTAL EQUIPMENT. WRITTEN DIMENSIONS WILL TAKE PRECEDENCE OVER SCALED DIMENSIONS.
- PATTERSON DENTAL WILL ASSUME NO RESPONSIBILITY FOR DEVIATIONS FROM THE DENTAL DRAWINGS AND SPECIFICATIONS WITHOUT PRIOR WRITTEN ENDORSEMENT.
- 3. PATTERSON DENTAL'S REPRESENTATIVES WILL PROVIDE ASSISTANCE AS NEEDED TO THE CONTRACTOR AND/OR ARCHITECT WITH PROPER ADVANCE NOTICE.
- 4. A PRE-CONSTRUCTION MEETING BETWEEN PATTERSON DENTAL'S REPRESENTATIVES AND THE CONTRACTOR, ARCHITECT, AND SUB-CONTRACTORS TO INCLUDE MECHANICAL, PLUMBING, AND ELECTRICAL IS REQUIRED. DENTAL SPECIFIC TEMPLATES AND SPECIFIC CONSTRUCTION REQUIREMENTS WILL BE PROVIDED DURING THIS MEETING.
- 5. PATTERSON DENTAL'S REPRESENTATIVES WILL MAKE PERIODIC VISITS TO THE JOB SITE AT CRITICAL POINTS IN THE CONSTRUCTION PROCESS. THE CONTRACTOR IS REQUIRED TO INFORM PATTERSON WHEN INSPECTIONS OF PLUMBING, WIRING, AND BACKING IN THE WALLS CAN BE PERFORMED PRIOR TO BACKFILLING TRENCHES, POURING OF THE SLAB, SEALING PARTITIONS AND INSTALLING
- 6. PATTERSON DENTAL'S REPRESENTATIVES WILL COORDINATE WITH THE CONTRACTOR TO INSTALL THE DENTAL EQUIPMENT AS LAID OUT IN THE INSTALLATION GUIDELINES AT A DATE AGREED UPON BY THE CONTRACTOR AND PATTERSON. A FINAL INSPECTION PRIOR TO THE INSTALLATION OF THE DENTAL EQUIPMENT WILL BE PERFORMED TO ENSURE THAT ALL PLUMBING, ELECTRICAL AND MECHANICAL CONSTRUCTION IS COMPLETE. ALL FLOORING, PAINTING AND CEILING WORK MUST BE COMPLETED PRIOR TO EQUIPMENT INSTALLATION.
- 7. THE CONTRACTOR AND SUB-CONTRACTORS ARE TO PROVIDE FINAL HOOK UP TO ALL DENTAL EQUIPMENT AS SET FORTH THE INSTALLATION GUIDELINES.

BUILDING CONTRACTOR:

- 1. THE BUILDING CONTRACTOR WHO HAS ENTERED INTO A CONSTRUCTION CONTRACT WITH THE OWNER IS RESPONSIBLE FOR ALL WORK DEFINED BY THAT CONTRACT. IF THE PROJECT IS LET UNDER SEPARATE CONTRACTS TO MORE THAN ONE CONTRACTOR, THE RESPONSIBILITIES LISTED BELOW APPLY TO EACH CONTRACTOR.
- 2. THE CONTRACTOR IS RESPONSIBLE FOR THE COMPLETION OF THE PROJECT IN THE TRUE INTENT OF THE DRAWINGS AND SPECIFICATIONS. THE CONTRACTOR IS TO FURNISH ALL MATERIALS AND LABOR REQUIRED TO COMPLETE THE PROJECT, THAT IS NOT SPECIFICALLY PROVIDED BY PATTERSON DENTAL, WHETHER OR NOT EACH AND EVERY ITEM IS SPECIFICALLY MENTIONED.
- THE CONTRACTOR SHALL ADVISE THE OWNER OF ANY CONFLICT BETWEEN THESE DRAWINGS AND THE FIELD CONDITIONS BEFORE PROCEEDING WITH THE JOB. THE CONTRACTOR SHALL ASSUME ALL RESPONSIBILITY FOR THE ACCURACY OF FIELD MEASUREMENTS AND CONDITIONS AND SHALL BE RESPONSIBLE FOR THE PROPER MODIFICATIONS TO ANY EXISTING WORK, PREVIOUSLY INSTALLED WORK, AND/OR OTHER TRADES. WRITTEN APPROVAL MUST BE OBTAINED FROM THE PATTERSON EQUIPMENT SPECIALIST ASSIGNED TO THE PROJECT BEFORE ANY CHANGES AND/OR DEVIATIONS FROM THE DRAWINGS AND SPECIFICATIONS ARE MADE. THE CONTRACTOR SHALL ASSUME FULL RESPONSIBILITY FOR THE EXECUTION OF HIS/HER WORK AND FOR ANY CHANGES AND/OR DEVIATIONS FROM THE DRAWINGS OR SPECIFICATIONS MADE WITHOUT PRIOR WRITTEN APPROVAL FROM THE OWNER AND/OR THE PATTERSON EQUIPMENT SPECIALIST. ANY COSTS RESULTING FROM CHANGES AND/OR DEVIATIONS SHALL BE THE RESPONSIBILITY OF THE CONTRACTOR.
- 4. A COMPLETE SET OF DRAWINGS MUST BE KEPT AT THE JOB SITE AT ALL TIMES AND ANY CHANGES MUST BE NOTED THEREON AND INITIALED AT THE TIME THE CHANGE OR DEVIATION IS PERFORMED.
- 5. THE GENERAL CONTRACTOR SHALL DO ALL PATCHING TO CONFORM TO MATERIAL, TEXTURE AND SURFACE ALIGNMENT WITH THE ADJOINING SURFACE AND FINAL TOUCH UP/APPEARANCE OF ALL FINISHED SURFACES. THE CONTRACTOR SHALL ENSURE THE PROTECTION OF ALL EQUIPMENT FURNISHED UNDER HIS/HER CONTRACT AND BY OTHERS PRESENT AT THE JOB SITE.
- 6. THE CONTRACTOR SHALL REMOVE DEBRIS AND MAINTAIN THE PREMISES BROOM CLEAN AT ALL TIMES. DEBRIS IS TO INCLUDE, BUT NOT LIMITED TO SHIPPING CARTONS, BOXES, ETC., RESULTING FROM THE INSTALLATION OF DENTAL AND OTHER EQUIPMENT BY CONTRACTORS CONCURRENTLY ENGAGED.
- 7. THE CONTRACTOR SHALL PARTICIPATE AT ALL JOB COORDINATION MEETINGS WITH PATTERSON DENTAL AND ENSURE THE ATTENDANCE OF APPLICABLE TRADES
- 8. THE CONTRACTOR IS REQUIRED TO INFORM PATTERSON DENTAL REPRESENTATIVES OF KEY EVENTS IN THE CONSTRUCTION PROCESS WITH REASONABLE ADVANCE NOTICE, TO FACILITATE THE INSPECTION OF SAID EVENTS, I.E. BACKFILLING TRENCHES, CLOSING WALLS, POURING CONCRETE TO BURY
- PLUMBING AND ELECTRICAL WORK IN FLOORS AND INSTALLING CEILING TILES.

 9. THE CONTRACTOR SHALL AFFORD THE OWNER AND SEPARATE CONTRACTORS
 REASONABLE OPPORTUNITY FOR THE INTRODUCTION AND/OR STORAGE OF THEIR
 MATERIALS AND EQUIPMENT AND EXECUTION OF THEIR WORK.

GENERAL NOTES:

- 1. THE ITEMS LISTED HERE IN THE GENERAL NOTES ARE INTENDED TO CLARIFY OVERALL GENERAL CONDITIONS FOR A SMOOTH TRANSITION BETWEEN ALL SUBCONTRACTORS, THE GENERAL CONTRACTOR, EQUIPMENT INSTALLERS, PATTERSON DENTAL AND THE OWNER FOR FINAL APPROVAL OF ALL WORK PERFORMED BY THE RESPECTIVE TRADES. THROUGHOUT THESE PLANS ARE VARIOUS DETAILS, REQUIREMENTS AND SPECIFICATIONS TO AID IN THIS PROCESS. IT IS THE RESPONSIBILITY OF EACH TRADE, CONTRACTOR AND THE OWNER TO READ ALL NOTES AND ILLUSTRATIONS THAT PERTAIN TO THEIR SPECIFIC TASK IN THE PROCESS.
- 2. MOST OF THE DENTAL UTILITY AND SPECIFICATION REQUIREMENTS ARE OUTLINED IN THE TEMPLATES AND DOCUMENTATION THAT PATTERSON WILL PROVIDE TO THE CONTRACTOR. QUESTIONS WILL ARISE ON THE JOB SITE AND MOST CAN BE ANSWERED BY TELEPHONE. THE CONTRACTOR WILL BE PROVIDED CONTACT NUMBERS FOR PATTERSON DENTAL REPRESENTATIVES TO FACILITATE TIMELY ANSWERS TO THOSE QUESTIONS. IN SOME CASES IT WILL BE NECESSARY FOR THE PATTERSON REPRESENTATIVE TO BE PRESENT AT THE JOB SITE TO ANSWER QUESTIONS OR SPOT LOCATIONS FOR DENTAL SPECIFIC ITEMS. IN THESE CASES AN APPOINTMENT WILL BE REQUIRED WITH REASONABLE ADEQUATE NOTIFICATION.
- 3. IF A JOB SITE APPOINTMENT IS REQUIRED, ALL TRADES SHOULD BE NOTIFIED OF THE APPOINTMENT SO THE OPTION OF BEING PRESENT WITH ANY QUESTIONS CONCERNING THEIR PORTION OF THE JOB CAN BE ADMINISTERED AT THAT APPOINTMENT. THE PATTERSON DENTAL REPRESENTATIVE SHOULD BE INFORMED AS TO THE MAGNITUDE OF THE APPOINTMENT PRIOR TO ARRIVAL ON THE JOB SITE IN ORDER TO ALLOW ENOUGH TIME IN THE APPOINTMENT.
- 4. THE GENERAL CONTRACTOR MUST SIGN THIS SHEET STIPULATING THAT THEY UNDERSTAND AND WILL COMPLY WITH ALL SPECIFICATIONS BEFORE ANY WORK WILL COMMENCE. A SIGNED COPY OF THE PLANS ARE TO BE RETURNED TO PATTERSON DENTAL AND A SECOND SIGNED COPY KEPT ON THE JOB SITE AT ALL
- 5. THE PATTERSON DENTAL REPRESENTATIVE SHALL GIVE INSTRUCTIONS TO THE GENERAL CONTRACTOR ONLY. ALL COMMUNICATIONS AND COORDINATION WITH TRADESMEN SHALL BE THE RESPONSIBILITY OF THE GENERAL CONTRACTOR UNLESS PREDETERMINED TO BE OTHERWISE.
- 6. ALL ELECTRICAL, MECHANICAL AND PLUMBING CONNECTIONS TO DENTAL EQUIPMENT WILL BE PERFORMED BY THE APPLICABLE TRADE RESPONSIBLE. INSTALLATION PERMITS, IF REQUIRED, WILL BE OBTAINED BY THE TRADES THAT PROVIDE THAT SERVICE.
- 7. IF NECESSARY, THE CONTRACTOR SHALL BE RESPONSIBLE FOR PROCURING A MED GAS CERTIFIED PLUMBING SUB-CONTRACTOR FOR ANY LEVEL 3 NITROUS-OXYGEN CONSCIOUS SEDATION SYSTEM DETAILED IN THESE PLANS. ANY NITROUS OXIDE SYSTEM DESIGN SHOWN ON THESE PLANS IS TO BE USED AS AN ILLUSTRATION ONLY FOR THE PURPOSE OF LOCATING END USER OUTLET STATIONS, CYLINDER ROOM MANIFOLD AND ALARM PANEL. THE FINAL TRUNK SYSTEM INSTALLATION SHALL STRICTLY ADHERE TO ONLY MECHANICALLY ENGINEERED DRAWINGS, IF SUPPLIED.
- 8. THE PLUMBING SUB-CONTRACTOR SHALL PROVIDE MED GAS CERTIFICATION IN ACCORDANCE WITH ANY REQUESTS BY THE OWNER, CONTRACTOR, BUILDING DEPARTMENT OR PATTERSON DENTAL PRIOR TO COMMENCING WORK ON ANY TYPE OF CUSTOMER INSTALLED NITROUS OXIDE SYSTEM BEING USED IN THE CONSTRUCTION PROJECT.
- 9. ALL PLUMBING AND ELECTRICAL LINES TO BE CONCEALED UNLESS OTHERWISE SPECIFIED.
- 0. ALL LABOR AND MATERIALS NECESSARY FOR CHANGES IN EXISTING PLUMBING, CARPENTRY, AND ELECTRICAL WORK MUST BE DONE AND SUPPLIED BY THE
- CONTRACTOR AND IS NOT INCLUDED IN THE COST OF THE DENTAL EQUIPMENT.

 11. THE CONTRACTOR SHALL REMOVE ALL RUBBISH AND DO ALL PATCHING AFTER
- ROUGHING IN IS COMPLETED.

 12. ALL ROUGH IN AND FINISH WORK FOR DENTAL EQUIPMENT IS TO BE ACCORDING TO TEMPLATES FURNISHED BY THE MANUFACTURERS OF THE EQUIPMENT BEING INSTALLED. A REPRESENTATIVE OF PATTERSON DENTAL WILL POSITION THE TEMPLATES IN THEIR PROPER LOCATIONS, AT WHICH TIME ALL SPECIFICATIONS ON THE PLANS WILL BE EXPLAINED TO THE CONTRACTOR OR SUB-CONTRACTOR(S). ALL SPECIFIED SIZES OF PIPES, TUBING, AND/OR FITTINGS, ETC., MUST BE RIGIDLY FOLLOWED AS WELL AS PROPER HEIGHTS MARKED. ANY INFRACTIONS ON SIZES OR HEIGHTS OF PIPES, TUBING AND/OR FITTINGS WILL HAVE TO BE CORRECTED BEFORE THE EQUIPMENT CAN BE INSTALLED AND SUCH EXTRA EXPENSE WILL BE
- THE RESPONSIBILITY OF THE CONTRACTOR AND/OR SUB-CONTRACTOR.

 13. THE DOCTOR/OWNER SHALL DESIGNATE RESPONSIBILITY FOR PROVIDING AND INSTALLING CABINETS AND COUNTERTOPS (OTHER THAN THOSE SPECIFIED AND/OR CONTRACTED BY PATTERSON DENTAL).
- THE DOCTOR SHALL MAKE ARRANGEMENTS FOR INSTALLATION OF NON-DENTAL SYSTEMS BEFORE WALLS ARE CLOSED.
- 15. PATTERSON DENTAL SHALL NOT BE HELD RESPONSIBLE FOR MULTIMEDIA SYSTEMS SUCH AS ENTERTAINMENT TVS, MONITORS, NETWORK COMPUTER SYSTEMS OR ANY ITEMS NOT SHOWN ON THESE PLANS.
- 16. GC MUST CONFIRM ALL MEASUREMENTS OF SPACE CONDITIONS PRIOR TO
- STARTING DEMOLITION

 17. GC SHOULD NOTIFY PATTERSON EQUIPMENT SPECIALIST 1(ONE GC MUST CONFIRM ALL MEASUREMENTS OF SPACE CONDITIONS PRIOR TO STARTING DEMOLITION)

 WEEK PRIOR TO CLOSING OF ALL WALLS, CEILINGS, FLOORS TO ALLOW FINAL INSPECTION OF INSTALLATION.
- 18. GC IS RESPONSIBLE FOR CONFIRMING ALL UTILITIES FOR EXISTING EQ BEING MOVED FROM EXISTING LOCATION OR EQUIPMENT NOT SUPPLIED BY PATTERSON
- 19. GC IS RESPONSIBLE FOR CONFIRMING ALL UTILITIES FOR EXISTING EQ BEING MOVED FROM EXISTING LOCATION OR EQUIPMENT NOT SUPPLIED BY PATTERSON
- RADIATION PROTECTION: THE DOCTOR'S ARCHITECT/GC ARE REQUIRED TO REVIEW ALL LOCAL AND NATIONAL RADIATION AND XRAY SHIELDING REQUIREMENTS AND SUBMIT AN APPLICATION FOR REGISTRATION OF IONIZING RADIATION SOURCES. PLANS MUST BE SUBMITTED TO RADIATION CONTROL PROGRAM, IF APPLICABLE, ALONG WITH OTHER INFORMATION THEY WILL PROVIDE A LETTER OF ACCEPTABLE X-RAY PROTECTION OR ADVISE OTHERWISE. THIS APPLICATION AND PLAN SHOULD BE SUBMITTED PRIOR TO WALLS GOING UP. COPY OF APPROVAL LETTER FROM LOCAL GOVERNING BODY MUST BE PROVIDED TO PATTERSON EQUIPMENT SPECIALIST AND SERVICE TECHNICIAN. NOTE: IF EXISTING X-RAYS TO BE REPLACED WITH NEW AND EXISTING SHIELDING IS TO BE REUSED ARCHITECT/GC MUST VERIFY NEEDS WITH LOCAL CODE OFFICER.



1031 MENDOTA HEIGHTS ROAD MENDOTA HEIGHTS, MN

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THE CONTRACTOR SHALL BE RESPONSIBLE FOR ALL

CONSTRUCTION OF THIS PROJECT.

CURRENT AMERICAN DISABILITIES ACT, (ADA)
ACCESSABILITY GUIDELINES.
THE CONTRACTOR SHALL ALSO BE RESPOSIBLE FOR
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THE CONTRACTOR SHALL COMPLY WITH ALL STATE,
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OWNER:

Community Care Clinic of Dare County

LOCATION:

425 W. Health Center Dr. Nags Head, NC

	PGW	F	Ron Sparrow	(757) 621-5401		
	PROJECT #: 764-755379		ISSUE DATE: 9-27-22			
	REVISIONS					

DRAWN BY EQUIPMENT REP: EQUIPMENT REP #:

	REVISIONS					
REV #	" DATE					

1 FRQ JH 10/3/2022

SHEET NO.

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LOCATION:

425 W. Health Center Dr. Nags Head, NC

PGW	Ron Sparrow		(757) 621-5401	
PROJECT 764-75537		ISSUE DATE: 9-27-22		
REVISIONS				

DRAWN BY EQUIPMENT REP: EQUIPMENT REP #:

REVISIONS					
REV		DRAWN			
#	SCOPE BY DATE				

1	FRQ	JH	10/3/2022
		•	

SHEET NO.	



WALL LEGEND			
EXISTING WALL			
	DEMO WALL		
	NEW WALL		
	SOUND PROOFING IN WALL		
	LEAD LINED WALL		

I	PLAN LEGEND			
DENTAL FURNITURE & EQUIPMENT				
	DENTAL FURNITURE & EQUIPMENT EXISTING RELOCATED			
	DENTAL FURNITURE & EQUIPMENT FUTURE			
12	EQUIPMENT NUMBER TAG (NUMBERS ARE RANDOM)			



FOR ASSISTANCE IN EQUIPMENT SUPPORT STRUCTURE & CLEARANCE QUESTIONS. THESE DRAWINGS AND SPECIFICATIONS ARE THE PROPERTY OF PATTERSON DENTAL SUPPLY AND THE USE LIMITED TO A SPECIFIED PROJECT FOR THE PERSON OR PERSONS NAMED HEREON FOR THE CONSTRUCTION OF ONE BUILDING ONLY. ANY USE OR REPRODUCTIONS OF THESE DRAWINGS ARE STRICTLY

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LOCATION:

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DRAWN BY	<u>EQU</u>	IPMENT REP:	EQUIPMENT REP #:
PGW F		Ron Sparrow	(757) 621-5401
PROJECT #: 764-755379		ISSUE DATE: 9-27-22	
		DE: //010110	

	REVIS	SIONS	
REV		DRAWN	
#	SCOPE	BY	DATE

1	FRQ	JH	10/3/2022

TRANSFORMER EC VFY HEIGHT LVL 1

ADDITIONAL BACKING TBD BY GC

BK-20

BK-24 BK-20

3' - 8"

BK-20 BK-24 BK-20

5' - 3 1/2"

(DA113)

BK-24 BK-20 5


3' - 8"


BK-24


ENSURE PAN ROOM & X-RAY COMPONENTS MEET STATE OF NC RADIATION CODE


1 LVL 1 BACKING PLAN 1/4" = 1'-0"


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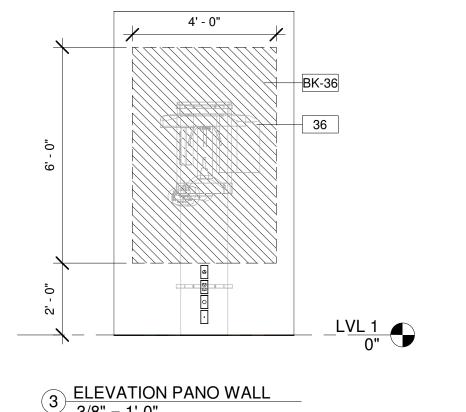


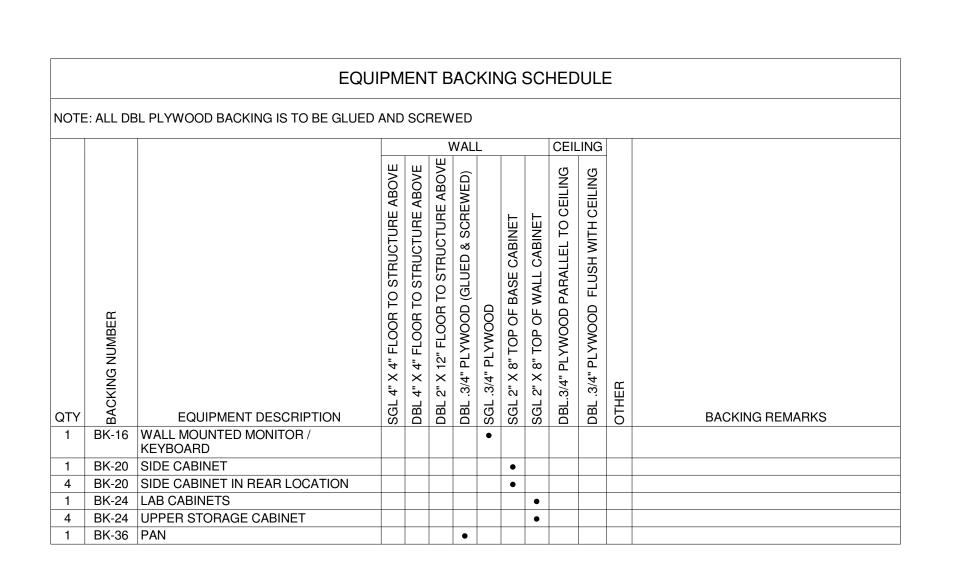


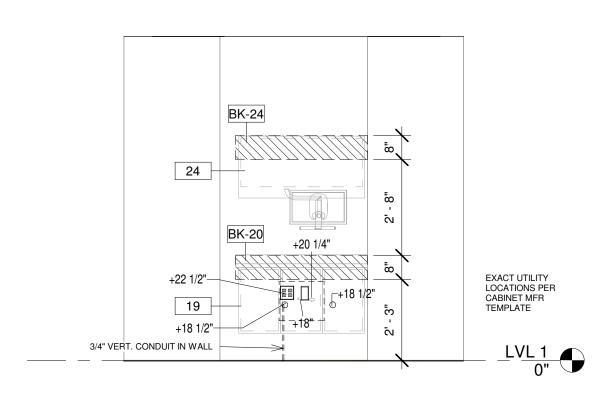


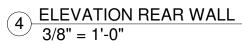


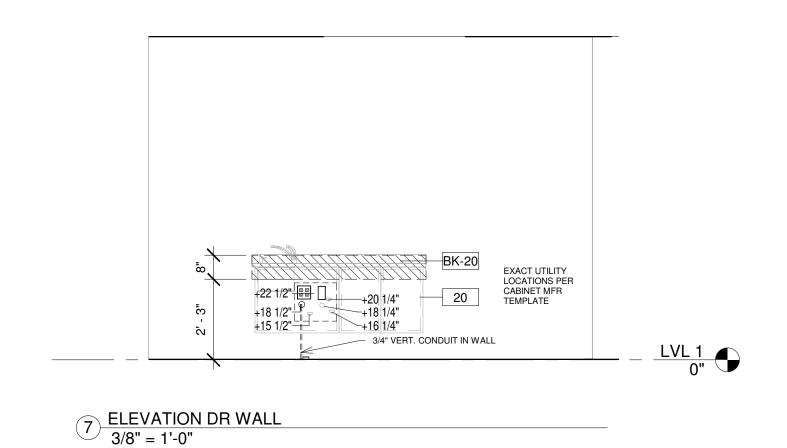

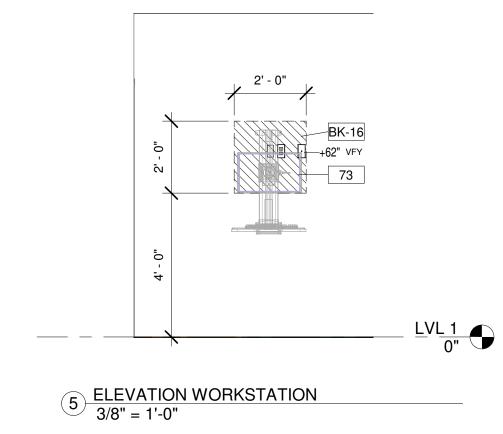

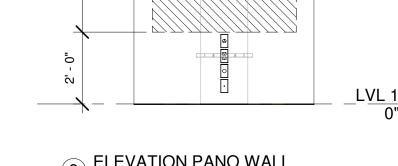

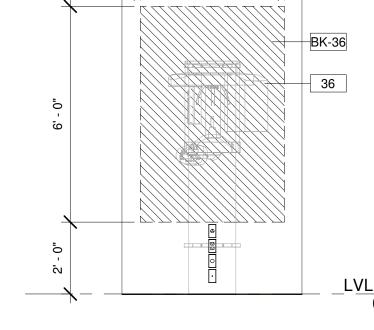

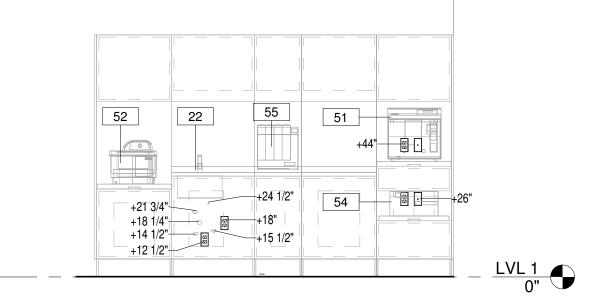

6 ELEVATION STERI
3/8" = 1'-0"

3 ELEVATION PANO WALL
3/8" = 1'-0"

2 ELEVATION MECH RM 3/8" = 1'-0"

INCLUDES, BUT IS NOT LIMITED TO, SUPPORT

FUNCTION OF PATTERSON SUPPLIED EQUIPMENT.

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425 W. Health Center Dr.

PGW

PROJECT #:

764-755379

ELECTRICAL SYMBOLS IN FLOOR

ALL DEVICES SHALL BE INSTALLED PER STATE AND LOCAL CODE.
ALL LOCATIONS SHOULD BE VERIFIED WITH PATTERSON REP OR OWNER PRIOR TO PLACEMENT.

+XX" - INDICATES HEIGHT FROM FINISHED FLOOR TO CENTER OF DEVICE UNLESS OTHERWISE NOTED BELOW, IF ITEM NOT TAGGED HEIGHT IS 18"

QTY. SYM.

DESCRIPTION

120v QUAD OUTLET FLOOR, MOUNTED ON FLOOR

LOW VOLTAGE SYMBOLS

ALL DEVICES SHALL BE INSTALLED PER STATE AND LOCAL CODE. ALL LOCATIONS SHOULD BE VERIFIED WITH PATTERSON REP OR OWNER PRIOR TO

+XX" - INDICATES HEIGHT FROM FINISHED FLOOR TO CENTER OF DEVICE UNLESS OTHERWISE NOTED BELOW, IF ITEM NOT TAGGED HEIGHT IS 18" A.F.F.

CONDUIT FLOOR STUB OUT, IF TAG NOT PRESENT HEIGHT IS 1" A.F.F.

PLUMBING SYMBOLS IN FLOOR


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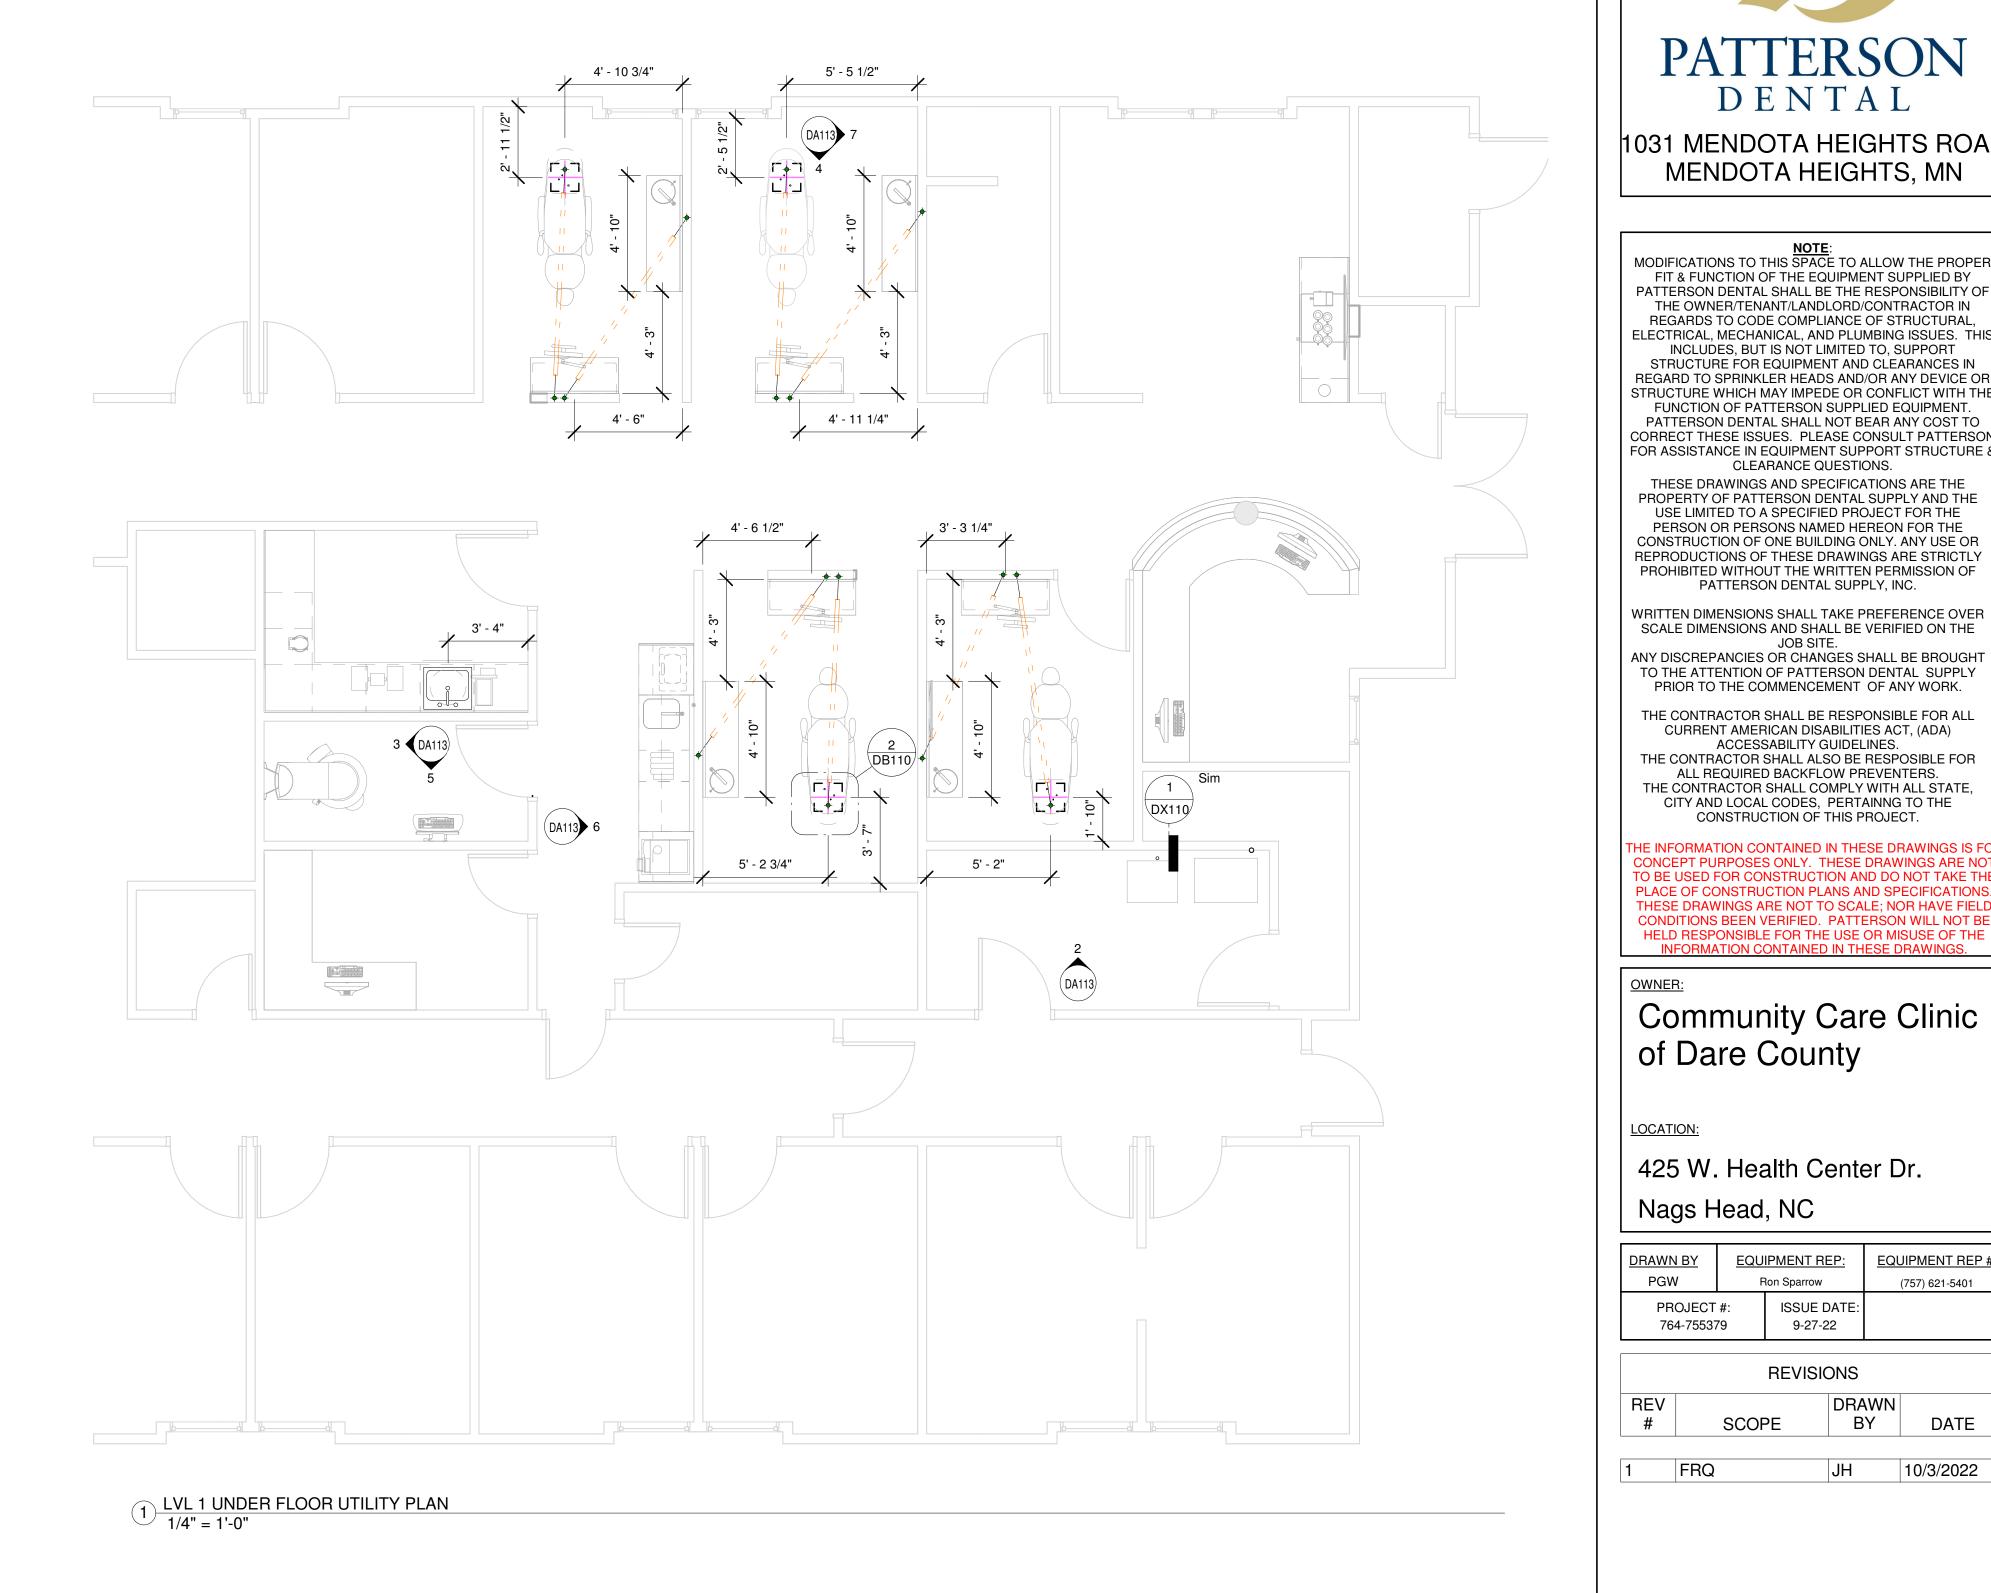
TO PLACEMENT. +XX" - INDICATES HEIGHT FROM FINISHED FLOOR TO CENTER OF DEVICE UNLESS OTHERWISE NOTED BELOW, IF ITEM NOT TAGGED HEIGHT IS 18" A.F.F.


QTY. SYM. DESCRIPTION

VACUUM RISER FLOOR

1/2" OD. TO 3/8" OD.SHUT OFF AIR CONNECTION FLOOR HEIGHT 3" A.F.F. TO CENTER UNLESS OTHERWISE NOTED VACUUM PIPE CONNECTION FLOOR



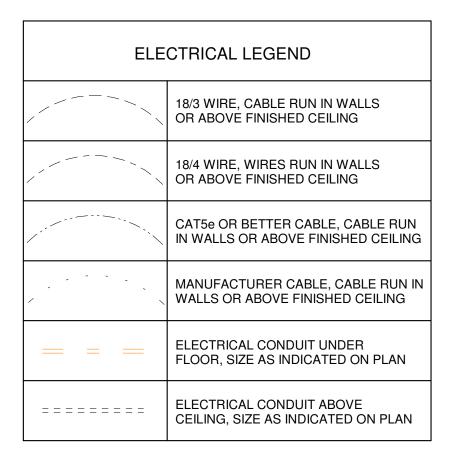

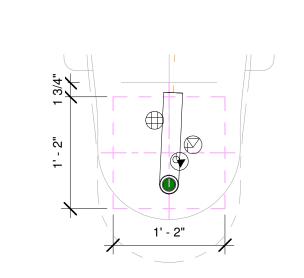

2 ENLARGED CHAIR UTILITY
1" = 1'-0"

THE OWNER/TENANT/LANDLORD/CONTRACTOR IN

REGARDS TO CODE COMPLIANCE OF STRUCTURAL,

INCLUDES, BUT IS NOT LIMITED TO, SUPPORT


REGARD TO SPRINKLER HEADS AND/OR ANY DEVICE OR


STRUCTURE WHICH MAY IMPEDE OR CONFLICT WITH THE FUNCTION OF PATTERSON SUPPLIED EQUIPMENT.

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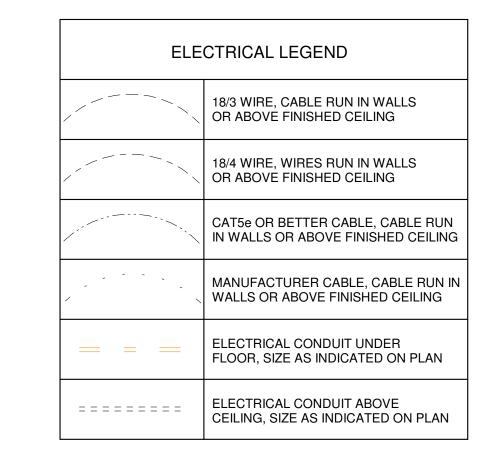
7	T	DATA DEVICE WALL, IF TAG NOT PRESENT HEIGHT IS 18" A.F.F.
1	••	ELECTRONIC INTERLOCK DOOR SWITCH, LOCATED BETWEEN DOOR PANEL AND FRAME
4	—	J-BOX WALL,LOW VOLTAGE, IF TAG NOT PRESENT HEIGHT IS 18" A.F.F
1	—	MASTER SWITCH WALL, IF TAG NOT PRESENT HEIGHT IS 60" A.F.F. TO CENTER
1		REMOTE PAN SWITCH IN WALL, IF TAG NOT PRESENT HEIGHT


VERTICAL CONDUIT IN WALL, EC VFY EXACT LOCATION.


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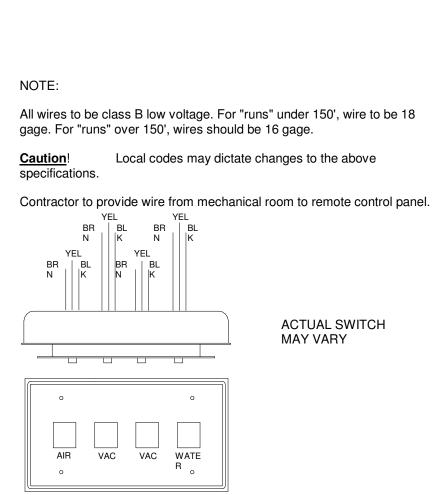
LOW VOLTAGE SYMBOLS

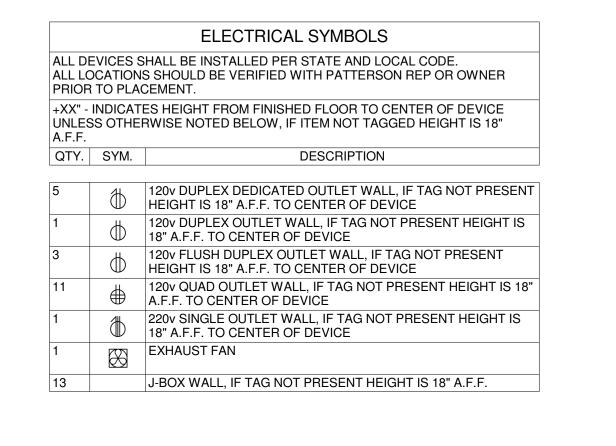
QTY. SYM.

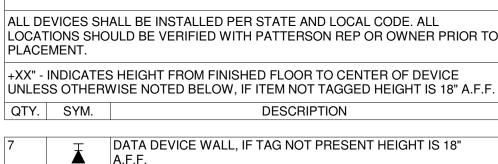





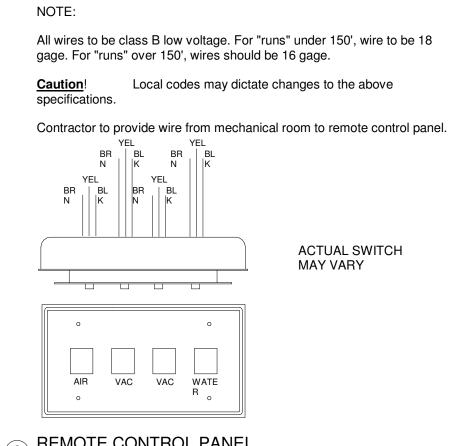

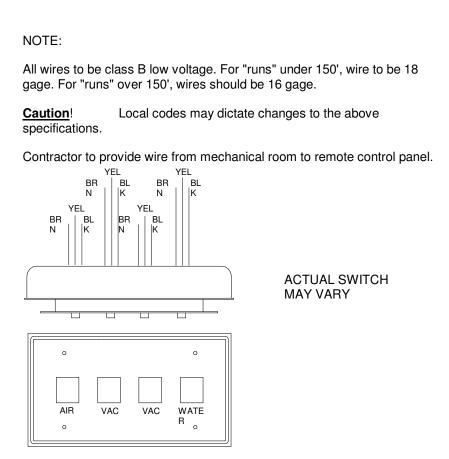

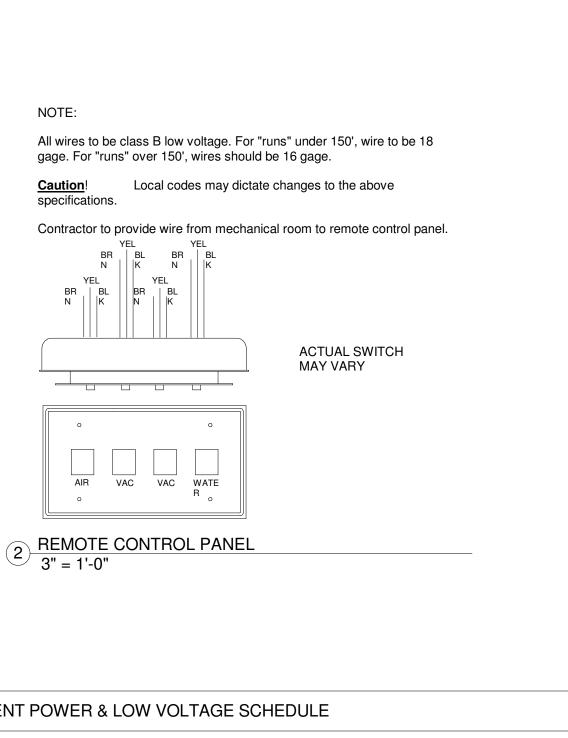

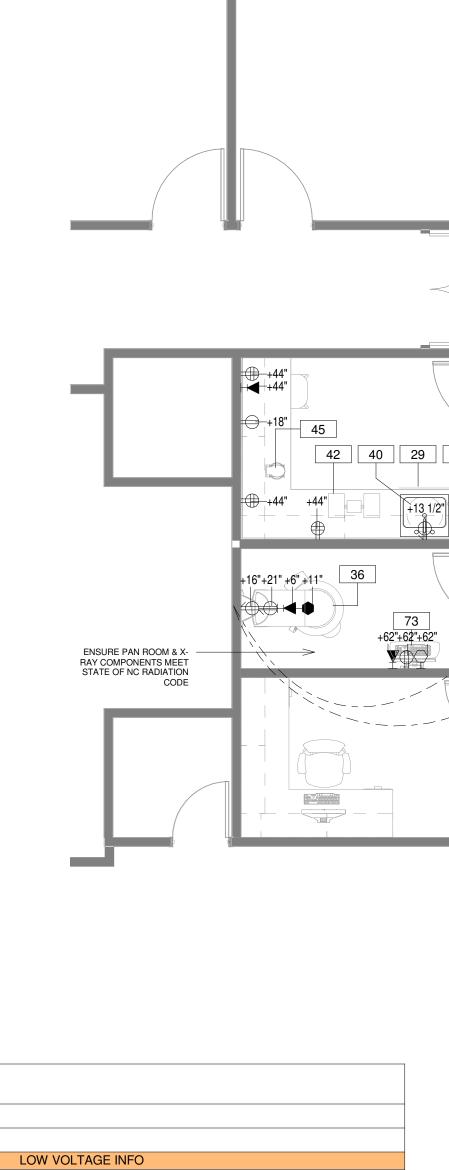

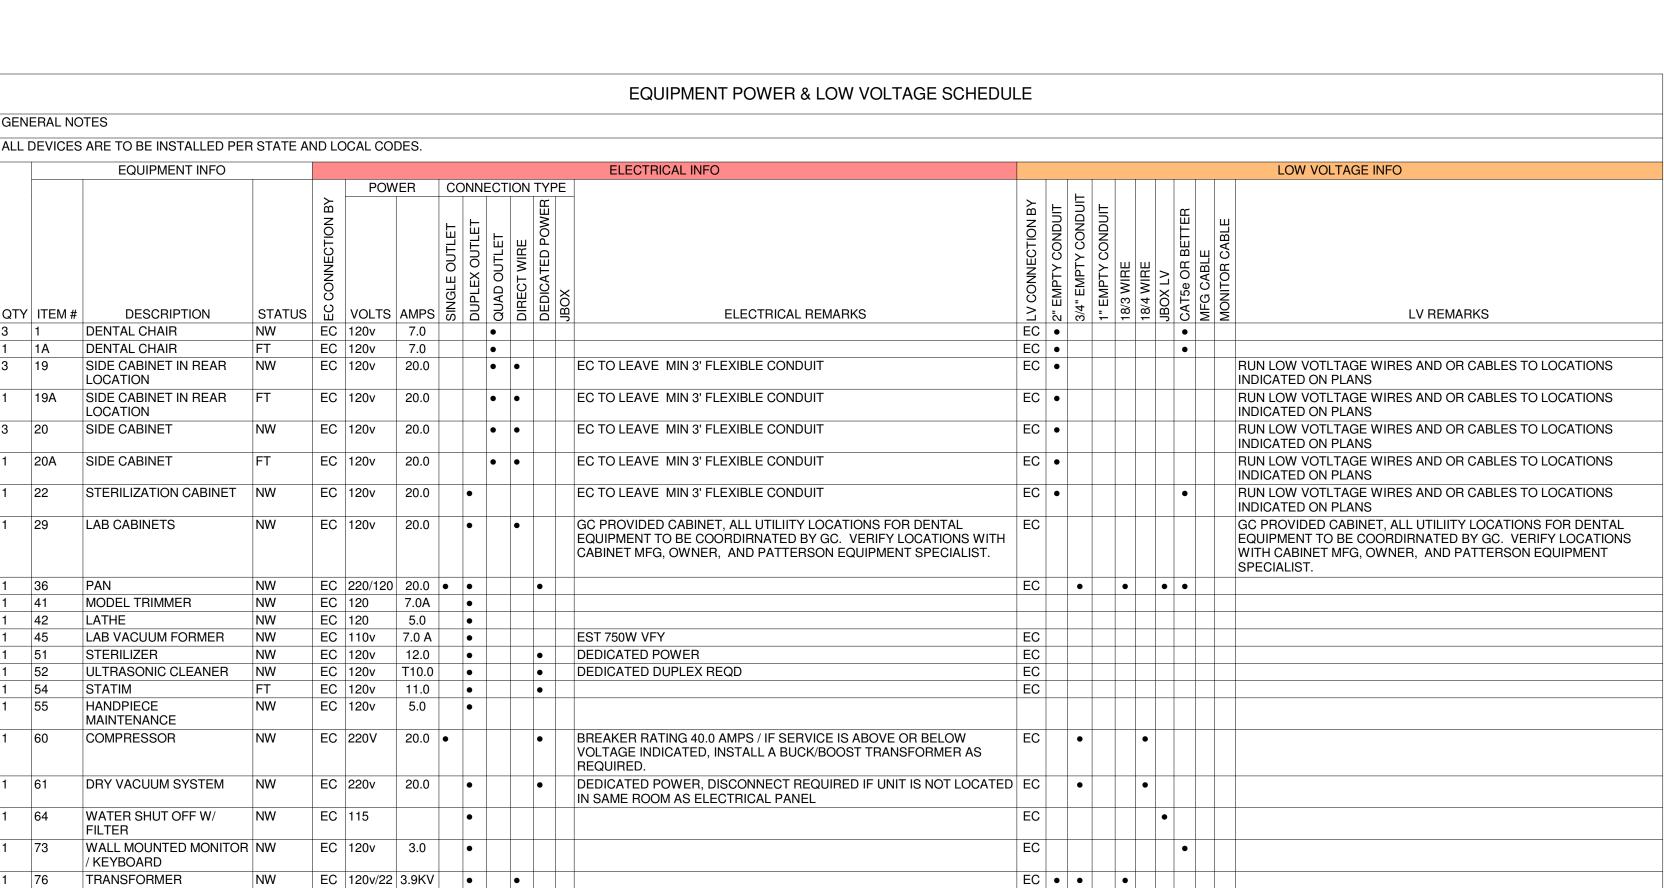

+18"+22 1/2" ||+18"+22 1/2' 24 19 24 19 +22 1/2" +18" 19A +22 1/2" +18" 22 +12 1/2"-+44"+26" 51 / +18"+18" +18"+18"+18" 61 60 +114"

1 LVL 1 POWER & LOW VOLTAGE PLAN 1/4" = 1'-0"

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LOCATION:

1 FRQ

425 W. Health Center Dr. Nags Head, NC

PGW	F	Ron Sparrow	(757) 621-5401
PROJECT 764-75537		ISSUE DATE: 9-27-22	
		REVISIONS	

DRAWN BY EQUIPMENT REP: EQUIPMENT REP #:

L	REVISI	ONS	
REV		DRAWN	
#	SCOPE	BY	DATE

1031 MENDOTA HEIGHTS ROAD MENDOTA HEIGHTS, MN

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Community Care Clinic of Dare County

LOCATION:


425 W. Health Center Dr. Nags Head, NC

EQUIPMENT REP:


PGW	F	Ron Sparrow	(757) 621-5401
PROJECT 764-75537		ISSUE DATE: 9-27-22	
		REVISIONS	

EQUIPMENT REP #:

REV		DRAWN	
#	SCOPE	BY	DATE
4	FRQ		10/3/2022

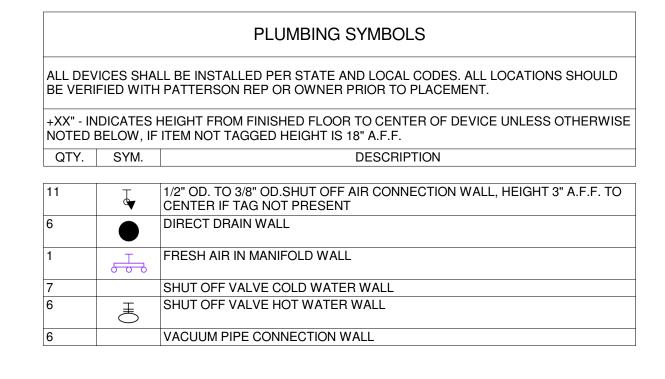

		EQUI	PMENT	EXHAUST SCHEDULE
GENE	ERAL NO	OTES::		
	_	ENTIFED AS "FT" WI CONCEALED FOR F	_	TALLED AT A FUTURE DATE. ALL UTILITIES NEED TO SE
ALL	ITEMS V	VILL BE INSTALLED F	PER STATI	E AND LOCAL CODES
		EQUIPMENT INFO)	
QTY	ITEM#	DESCRIPTION	STATUS	VENT EXHAUST REMARKS
1	60	COMPRESSOR	NW	REQS FRESH AIR INTAKE OUTSIDE RM
1	61	DRY VACUUM SYSTEM	NW	METAL EXAUST PIPE REQUIRED IF UNIT DOES NOT HAVE A HEAT EXCHANGER

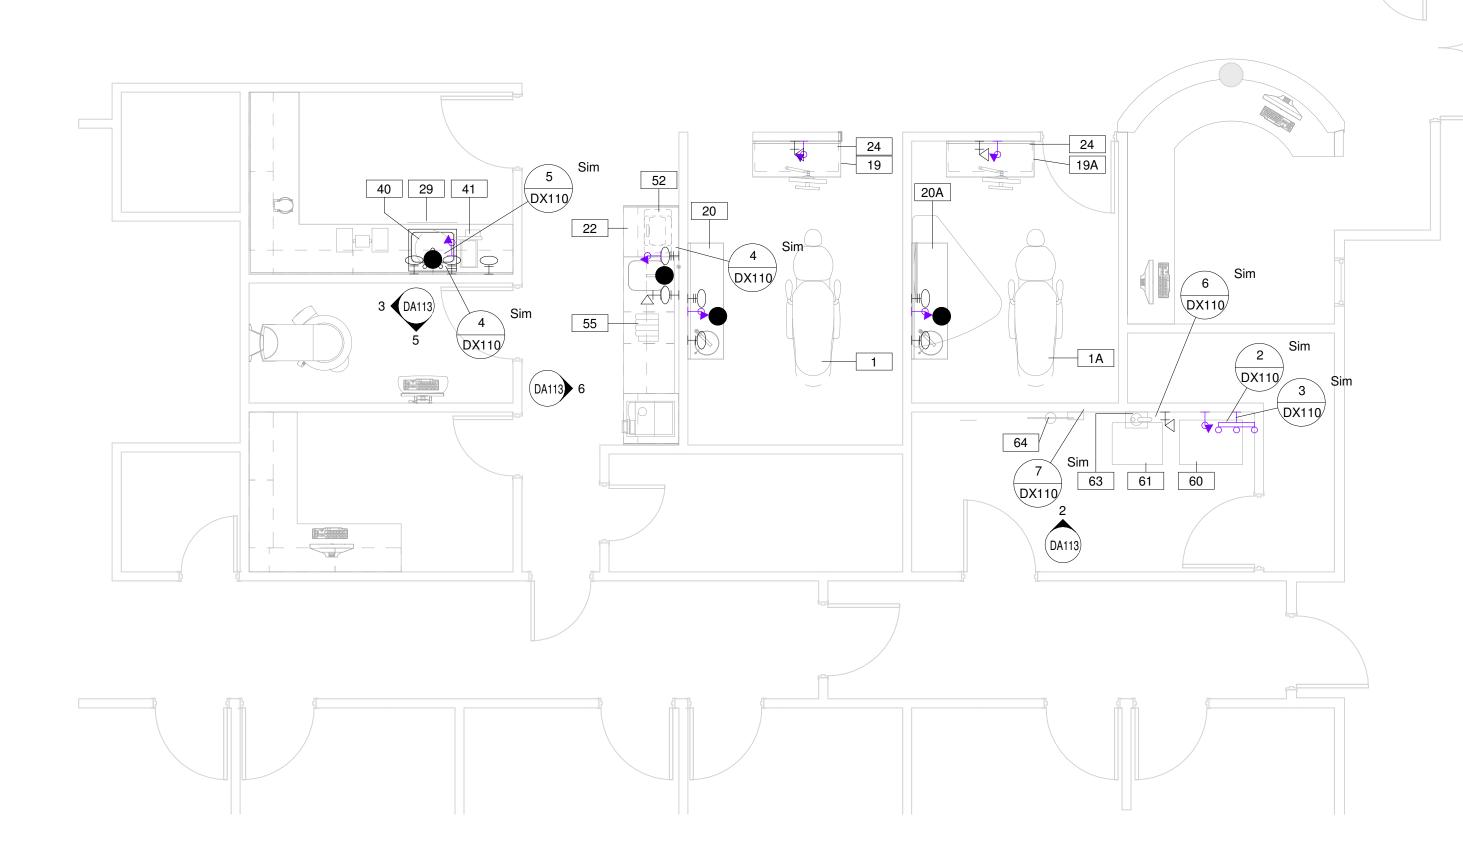

1 LVL 1 PLUMBING PLAN 1/4" = 1'-0"

		EQUIPMENT PLUMBING-DEN	TAL COMPRES	SED AIF	R-VAC SCHEDULE	
ERAL NOTES:						
ITEMS TO BE INSTALLED PER STATE AND LOC	AL CODES					
PLUMBING		PLUMBING INFO			VAC INFO	DENTAL COMPRESSED AIR
ITEM# DESCRIPTION 1 DENTAL CHAIR 1A DENTAL CHAIR 19 SIDE CABINET IN REAR LOCATION 19A SIDE CABINET IN REAR LOCATION 20 SIDE CABINET 20A SIDE CABINET 22 STERILIZATION CABINET 22 STERILIZATION CABINET 29 LAB CABINETS 40 PLASTER TRAP 41 MODEL TRIMMER 52 ULTRASONIC CLEANER 60 COMPRESSOR	AN	SANITARY OP TINGHOS BY A STAND PIPE PER LOCAL CODES PROCOMPRESSOR. / SEE DETAIL AS INDICATED ON PLAN. PLUMBING REMARKS PLUMBING REMARKS	PC VFY TORAIN TORAIN O IN. OF	3/4" PVC SCHEDULE 1-1/2" PVC SCHEDUL	AMBIENT TEMPERATURE MUST NOT EXCEED 105 DEGREES FAHRENHEIT, MUST BE ABOVE 41 DEGREES FAHRENHEIT	
00 000000000000000000000000000000000000		OTHERS				
63 AMALGAM SEPARATOR 64 WATER SHUT OFF W/ FILTER	NW PC •			•		

CLEARANCE QUESTIONS. THESE DRAWINGS AND SPECIFICATIONS ARE THE PROPERTY OF PATTERSON DENTAL SUPPLY AND THE USE LIMITED TO A SPECIFIED PROJECT FOR THE PERSON OR PERSONS NAMED HEREON FOR THE CONSTRUCTION OF ONE BUILDING ONLY. ANY USE OR REPRODUCTIONS OF THESE DRAWINGS ARE STRICTLY PROHIBITED WITHOUT THE WRITTEN PERMISSION OF PATTERSON DENTAL SUPPLY, INC.

CORRECT THESE ISSUES. PLEASE CONSULT PATTERSON

FOR ASSISTANCE IN EQUIPMENT SUPPORT STRUCTURE &

WRITTEN DIMENSIONS SHALL TAKE PREFERENCE OVER SCALE DIMENSIONS AND SHALL BE VERIFIED ON THE JOB SITE. ANY DISCREPANCIES OR CHANGES SHALL BE BROUGHT

TO THE ATTENTION OF PATTERSON DENTAL SUPPLY PRIOR TO THE COMMENCEMENT OF ANY WORK. THE CONTRACTOR SHALL BE RESPONSIBLE FOR ALL CURRENT AMERICAN DISABILITIES ACT, (ADA)

ACCESSABILITY GUIDELINES. THE CONTRACTOR SHALL ALSO BE RESPOSIBLE FOR ALL REQUIRED BACKFLOW PREVENTERS. THE CONTRACTOR SHALL COMPLY WITH ALL STATE, CITY AND LOCAL CODES, PERTAINNG TO THE CONSTRUCTION OF THIS PROJECT.

THE INFORMATION CONTAINED IN THESE DRAWINGS IS FO CONCEPT PURPOSES ONLY. THESE DRAWINGS ARE NO TO BE USED FOR CONSTRUCTION AND DO NOT TAKE TH PLACE OF CONSTRUCTION PLANS AND SPECIFICATIONS THESE DRAWINGS ARE NOT TO SCALE; NOR HAVE FIELD CONDITIONS BEEN VERIFIED. PATTERSON WILL NOT BE HELD RESPONSIBLE FOR THE USE OR MISUSE OF THE

Community Care Clinic of Dare County

LOCATION:

PROJECT #: ISSUE DATE: 9-27-22 REVISIONS	1 477	юп орапом	(737) 021-3401
REVISIONS			
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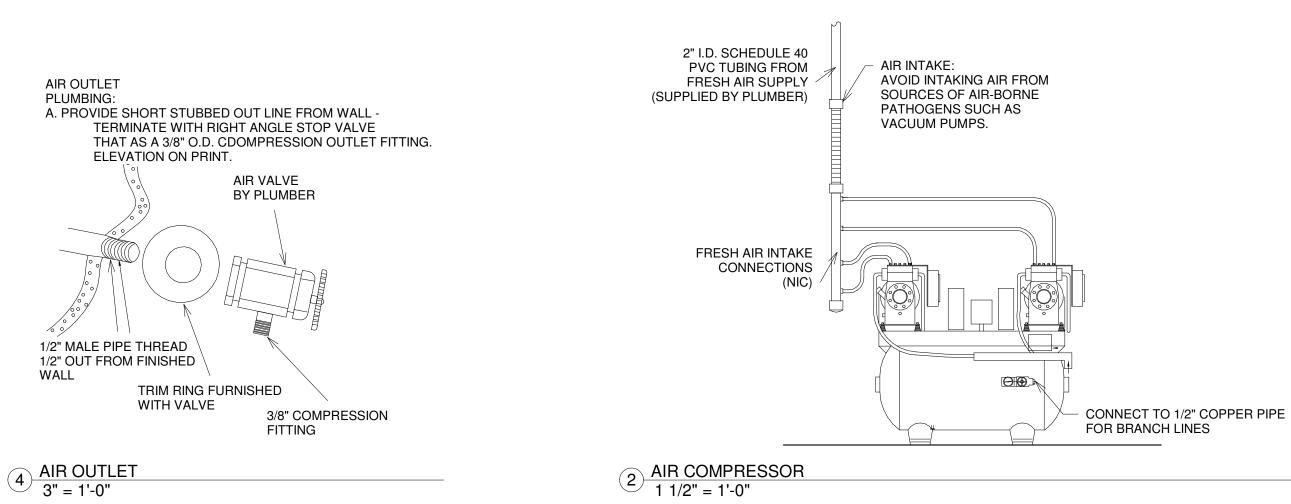
REV #	SCOPE	DRAWN BY	DATE
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1 FRQ JH 10/3	3/2022


425 W. Health Center Dr. Nags Head, NC **DRAWN BY EQUIPMENT REP: EQUIPMENT REP #:** PGW Ron Sparrow (757) 621-5401

ONSTRUCTION


SHEET NO.




5 MODEL TRIMMER W/ PLASTER TRAP 1 1/2" = 1'-0"

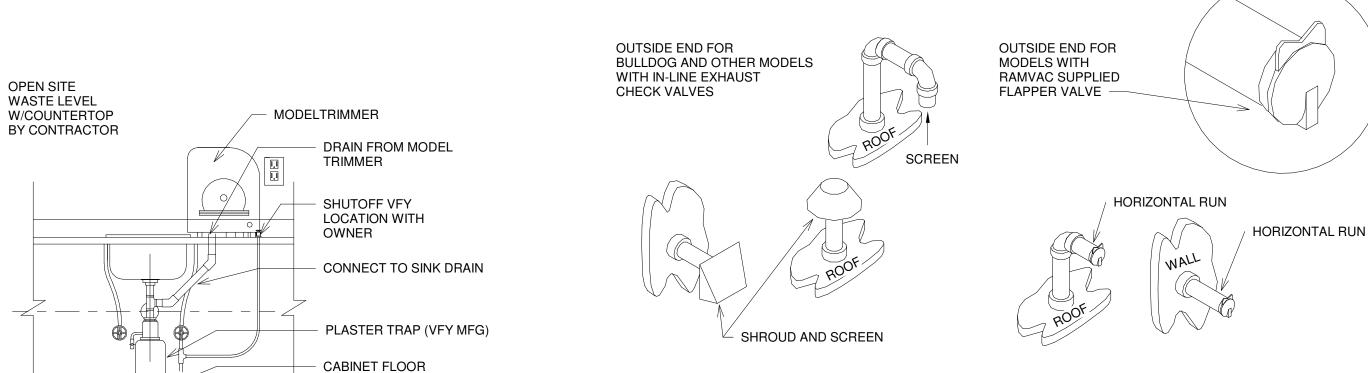

- PROTECT OUTSIDE END OF EXHAUST FROM ENTRY OF WATER, DEBRIS, AND CREATURES. POINT AWAY FROM PREVAILING WINDS, CLEAR OF SNOW OR OTHER OBSTRUCTIONS. CLEAR ROOF TOPS OR OUTSIDE WALLS BY A MINIMUM OF 6 INCHES.
- LOCATE IN AN INCONSPICUOUS SITE AWAY FROM DOORS, WINDOWS OR VENTILATION INTAKES.
- 3 EXHAUST PIPING OUTSIDE END 1 1/2" = 1'-0"

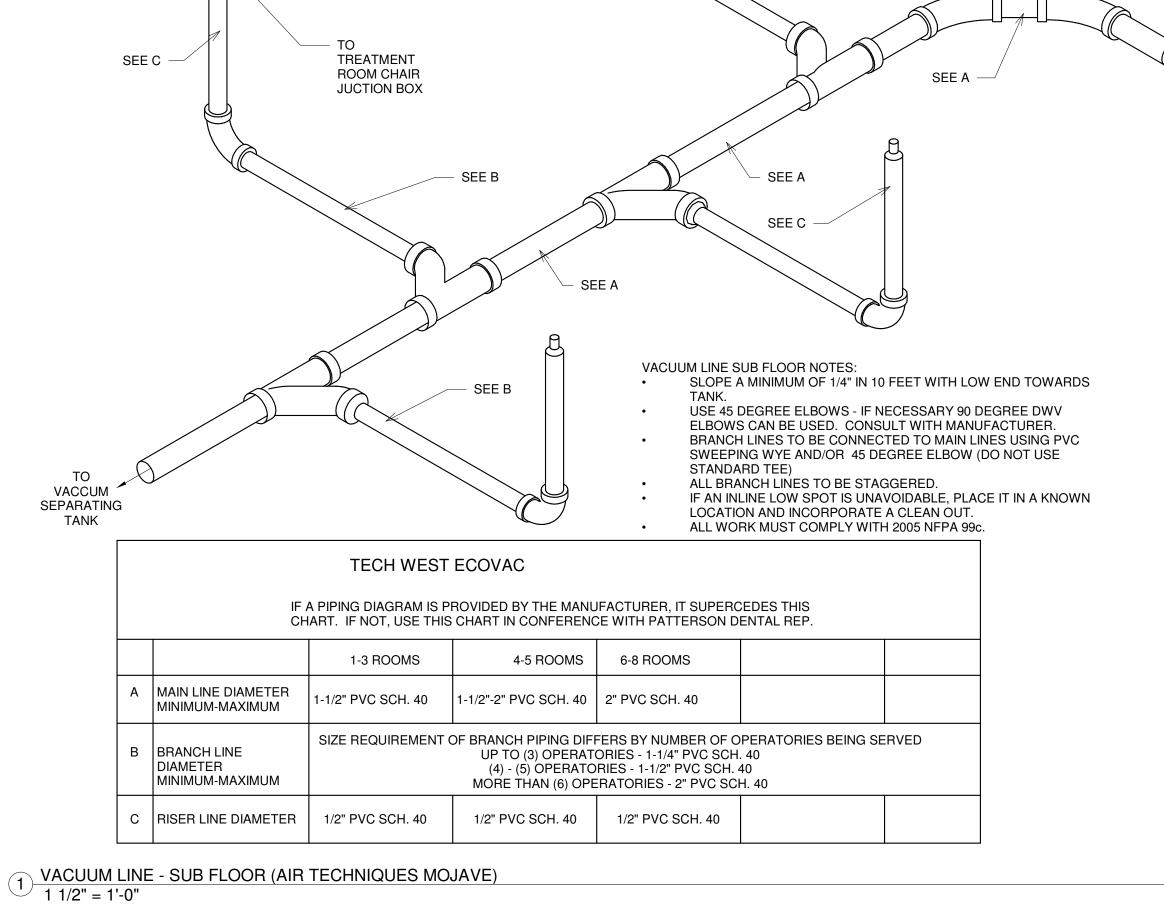

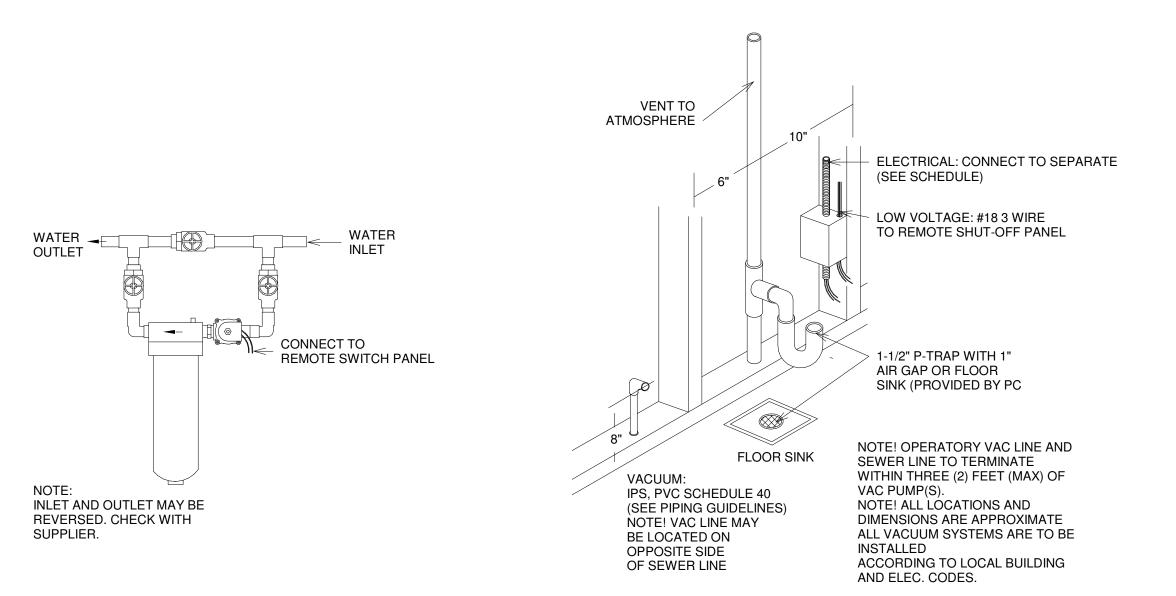

6 VAC DRY 1 1/2" = 1'-0"

7 WATER FILTER MANIFOLD
1 1/2" = 1'-0"