
## REID BUILDING - ROOF REPLACEMENT WESTERN CAROLINA UNIVERSITY


CULLOWHEE, NORTH CAROLINA SCO ID#: 22-24547-01A

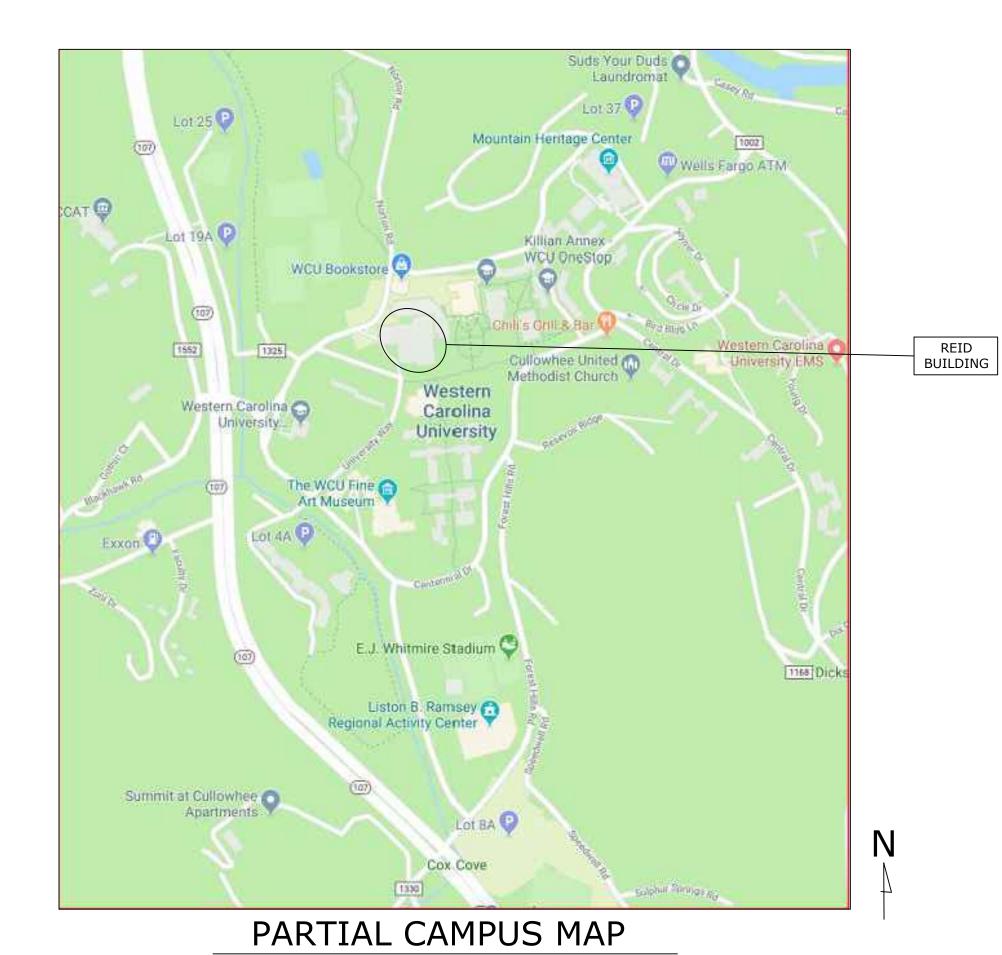

## PREPARED FOR:

WESTERN CAROLINA UNIVERSITY
FACILITIES MANAGEMENT
3476 OLD CULLOWHEE ROAD
CULLOWHEE, NC 28723

DRAW	/ING INDEX
COV	COVER SHEET AND BUILDING CODE SUMMARY
1.0	SITE PLAN
2.0	EXISTING ROOF PLAN
2.1	NEW ROOF PLAN
2.2	ENLARGED ROOF PLAN - SOUTH SECTION
2.3	ENLARGED ROOF PLAN - NORTH SECTION
2.4	BID ALTERNATE ROOF PLAN
3.0	CONSTRUCTION DETAILS
3.1	CONSTRUCTION DETAILS (CONT.)
3.2	CONSTRUCTION DETAILS (CONT.)
3.3	CONSTRUCTION DETAILS (CONT.)
3.4	CONSTRUCTION DETAILS (CONT.)

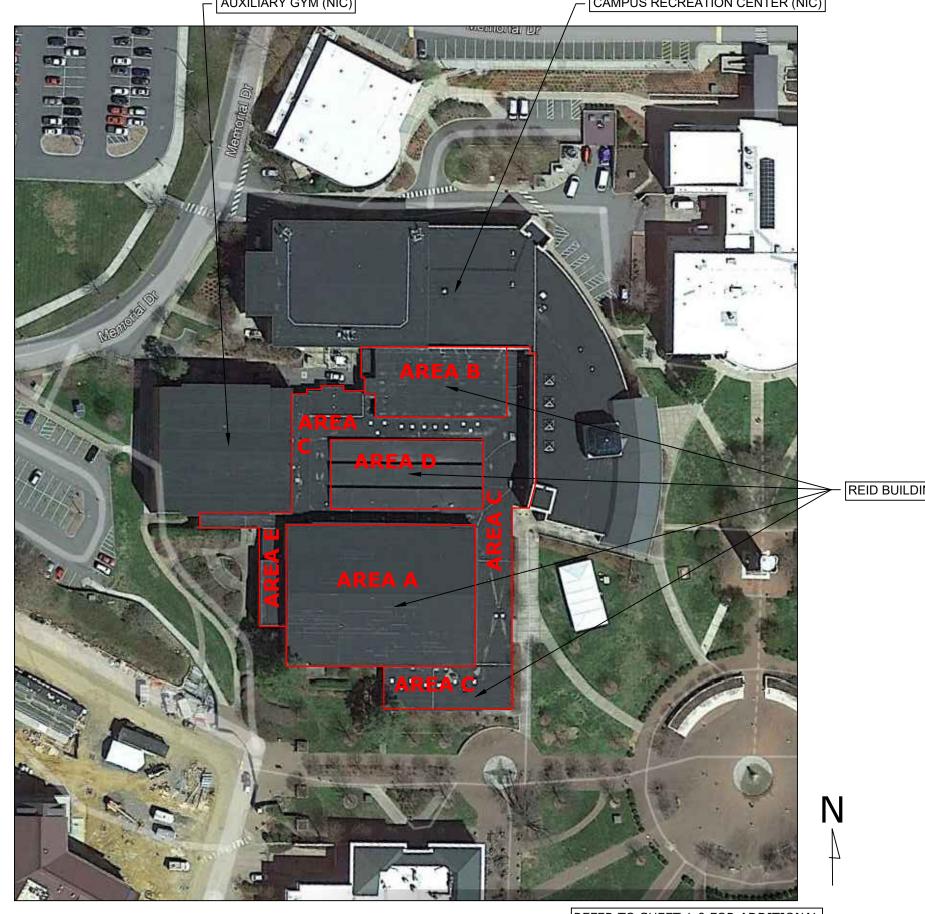

SITE PLAN

NOT TO SCALE


## BUILDING CODE SUMMARY - 2018 APPENDIX B


NOT TO SCALE

Owner or Aut		TY WAY, CL			YPhone #_DAN	p Code: 28723 IIEL FISKEAUX: (828 SKEAUX@EMAIL.WCU	3) 227-3020 J.EDU
Owned By:			County	□ Private	✓ State		
Code Enforce	ment Jurisdi	iction: 🗆 City		☐ County	🛛 Stat	e	
CONTACT: HA	NNAH FOR	RD, PE, RRC	), ATLAS E	NGINEERII	NG, INC.		
DESIGNER	FIRM	NI / A	NAME		LICENSE #	TELEPHONE #	EMAIL
Architectural		N/A N/A			· -		
Civil	N/A						
Electrical	-	N/A			<u></u>		
Fire Alarm	M N/A N/A					· -	
Plumbing Mechanical		N/A					
Sprinkler-Sta	ndnine	N/A					
Structural	поріро	N/A					
Retaining Wal	lls> 5' High						
REROOFING			ING HANN	NAH FORD	NC#54361	(919) 420-7676	HANNAH@ATLASNC
DASIC DUILDII							
Construction (Check all that	Type: □ I- t apply)□ I-	B ⊠ II-	-B □ II			V-B	
Construction (Check all that Sprinklers:   Standpipes:	Type: □ I- t apply)□ I- □ No  図 Pc 図 No □ Ye	B ⊠ II- urtial □ Yes :s Class	-B □ II	I–B 3 □ NFF	□ N		
Construction (Check all that Sprinklers:   Standpipes:   Fire District:	Type: □ I- t apply) □ I- □ No  図 Pc 図 No □ Ye □ No  図 Ye	B ⊠ II- artial □ Yes as Class as (Primary)	-B          NFPA 1 	I−B  3 □ NFF □ □ III  Gross Area (	□ \ PA 13R □ N □ Wet	V-B IFPA 13D	
Construction (Check all that Sprinklers:   Standpipes:   Fire District:    AREA A	Type: □ I- t apply) □ I- □ No  図 Pc 図 No □ Ye □ No  図 Ye	B ⊠ II- urtial □ Yes us Class us (Primary)  AREA C	B   II	I-B 3 □ NFF □ □ III  Gross Area (	□ \ PA 13R □ N □ Wet	V-B IFPA 13D	SUB-TOTAL
Construction (Check all that Sprinklers:   Standpipes:   Fire District:	Type: □ I- t apply) □ I- □ No  図 Pc 図 No □ Ye □ No  図 Ye	B ⊠ II- artial □ Yes as Class as (Primary)	-B          NFPA 1 	I−B  3 □ NFF □ □ III  Gross Area (	□ \ PA 13R □ N □ Wet	V-B IFPA 13D	SUB-TOTAL 68,035*
Construction (Check all that Sprinklers:   Standpipes:   Fire District:    AREA A	Type: □ I- t apply) □ I- □ No  図 Pc 図 No □ Ye □ No  図 Ye	B ⊠ II- urtial □ Yes us Class us (Primary)  AREA C	B   II	I-B 3 □ NFF □ □ III  Gross Area (	□ \ PA 13R □ N □ Wet	V-B IFPA 13D	68,035*
Construction (Check all that Sprinklers:   Standpipes:   Fire District:    AREA A 22,400*	Type: □  - t apply) □  - □ No ☑ Po ☑ No □ Ye □ No ☑ Ye □ AREA B 8,030*	B ⊠ II- urtial □ Yes us Class us (Primary)  AREA C	B   II	I-B 3 □ NFF □ □ III  Gross Area (	□ \ PA 13R □ N □ Wet	V-B IFPA 13D	
Construction (Check all that Sprinklers:   Standpipes:   Fire District:   AREA A	Type: □  - t apply) □  - □ No ☑ Po ☑ No □ Ye □ No ☑ Ye □ AREA B 8,030*	B ⊠ II- urtial □ Yes us Class us (Primary)  AREA C	-B	I−B  3 □ NFF  □ III  Gross Area (  AREA E  5,250*	PA 13R	V−B IFPA 13D □ Dry	68,035*
22,400* *ROOF ARE	Type: □  - t apply) □  - □ No ☑ Po ☑ No □ Ye □ No ☑ Ye □ AREA B 8,030*	B ⊠ II- artial □ Yes as Class as (Primary)  AREA C  23,022*	-B	I-B 3 □ NFF □ □ III  Gross Area (	PA 13R	V−B  IFPA 13D  □ Dry  TOTAL	68,035*


NOT APPLICABLE: ROOF REPLACEMENT WILL NOT CHANGE THE EXISTING FIRE SEPARATION DISTANCE OR RATING OF THE OVERALL ROOF ASSEMBLY OF ORIGINAL CONSTRUCTION. SYSTEM WILL REMAIN A UL

CLASS A RATED SYSTEM.

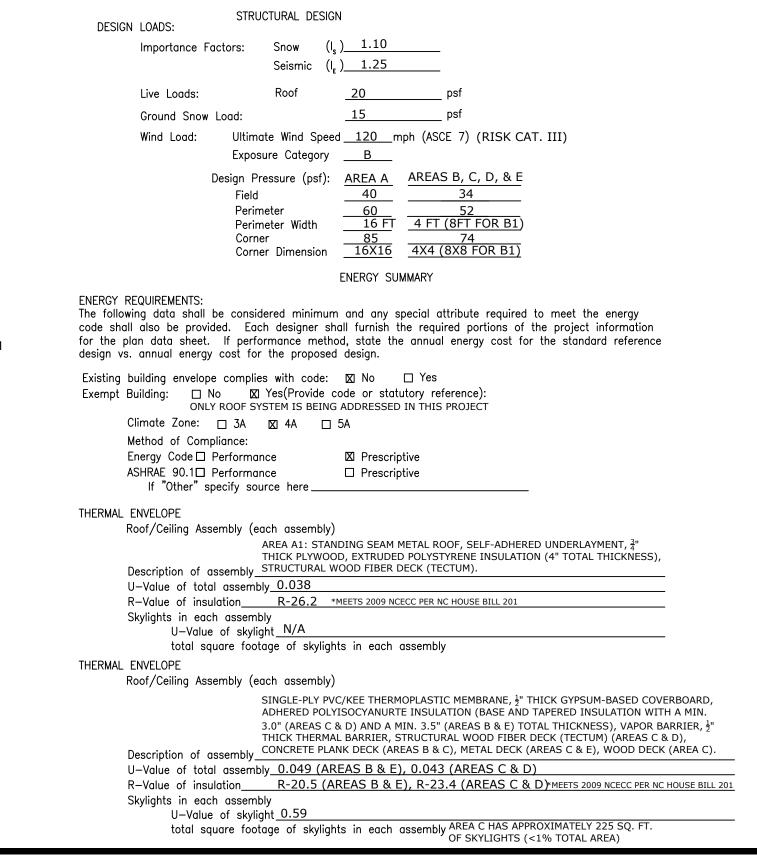

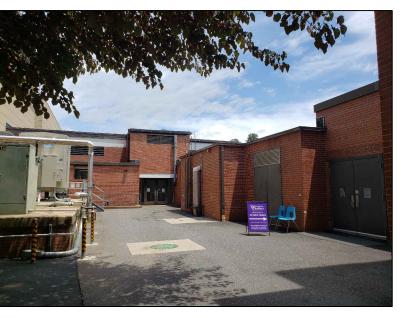


NORTH ROOF ACCESS LADDER

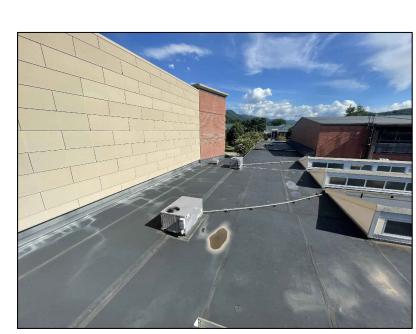

PARTIAL OVERVIEW OF ROOF AREA C



OVERVIEW OF ROOF AREA A AT RIDGE

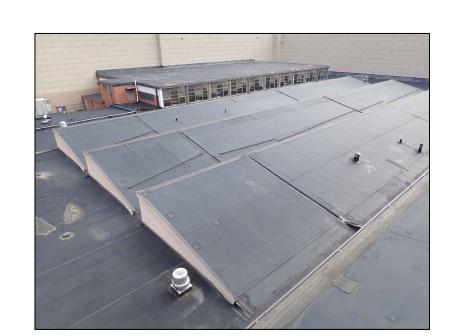

OVERVIEW OF ROOF AREA D



NOTES REGARDING DESIGNATED SITE

STAGING AND STORAGE


OVERVIEW OF ROOF AREA B




PARTIAL OVERVIEW OF ROOF AREA E

**BID DOCUMENTS** 



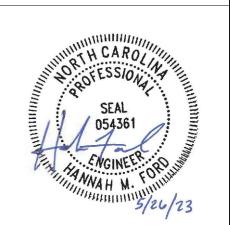



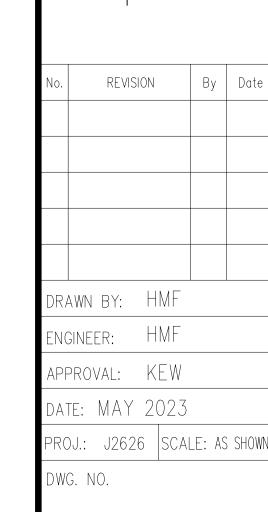

AUXILIARY GYMNASIUM (NOT IN CONTRACT)

OVERHEAD PROTECTION -

PROPOSED CONTRACTOR PARKING AND

## **NOTES TO SITE PLAN:**

- 1. THIS DRAWING ACCOMPANIES A PROJECT MANUAL BY ATLAS ENGINEERING DATED MAY 2023. PRIOR TO THE START OF WORK, PERFORM A PRE-JOB DAMAGE SURVEY IN ACCORDANCE WITH THE PROJECT MANUAL.
- 2. PROTECT EXISTING BUILDING EXTERIORS, SITE UTILITIES, EQUIPMENT, LANDSCAPING, AND OTHER SITE FEATURES FROM DAMAGE DUE TO CONSTRUCTION ACTIVITIES, INCLUDING RUNNING AND STANDING WATER. IF DAMAGE OCCURS, REPAIR AREAS AND RETURN THEM TO THEIR PRIOR CONDITION.
- PROVISION OF A STORAGE AND STAGING AREA, PERMANENT OR TEMPORARY, BY THE OWNER DOES NOT REMOVE THE RESPONSIBILITY OF THE CONTRACTOR TO PROTECT THE AREA(S) DURING USE AND TO MAKE REPAIRS TO RETURN THE AREA TO ITS CONDITION PRIOR TO USE. IN ADDITION, THE CONTRACTOR MUST COMPLY WITH REQUESTS/REQUIREMENTS BY WCU, BUILDING, GROUNDS, AND DPS REQUIREMENTS TO MAINTAIN PEDESTRIAN AND VEHICULAR SAFETY AROUND EACH STAGING AND STORAGE AREA AND PROTECT LANDSCAPING WHETHER OR NOT SPECIFICALLY NOTED IN THE DESIGN DOCUMENTS.
- 4. INSTALL FENCING MEETING THE REQUIREMENTS OF WCU AROUND EACH STAGING AND STORAGE AREA AND AROUND AREAS FOR ROOF ACCESS (MATERIALS, EQUIPMENT, AND WORKERS). UTILIZE 6' TALL CHAIN-LINK FENCING FOR MAIN STORAGE AND STAGING AREAS. ORANGE SNOW FENCING MAY BE USED AT TEMPORARY STAGING AREAS. FENCING IN PAVED/CONCRETE AREAS MUST HAVE WEIGHTED BASES TO PREVENT DAMAGE.
- 5. INSTALL OVERHEAD PROTECTION AT DOORS ADJACENT TO AREAS OF ROOF WORK. ENSURE OVERHEAD PROTECTION EXTENDS FAR ENOUGH FROM THE BUILDING TO PROTECT PEDESTRIANS. NOT ALL LOCATIONS MAY BE SHOWN ON THE SITE PLAN. VERIFY LOCATIONS OF OVERHEAD PROTECTION REQUIRED.
- 6. MAINTAIN ALL POINTS OF EGRESS FROM THE BUILDING. IF ACCESS POINTS/TEMPORARY STAGING AREAS ARE LOCATED ADJACENT TO DOORS, KEEP ACCESS POINTS CLEAR OF DEBRIS AND OBSTRUCTIONS.
- 7. IF THE BID WILL BE IMPACTED BY USE OF STAGING/STORAGE AREAS THAT DIFFERS SIGNIFICANTLY FROM WHAT IS SHOWN, BIDDER SHOULD OBTAIN APPROVAL IN WRITING PRIOR TO BIDDING.
- 8. NO INTERRUPTION OF UTILITIES MAY OCCUR WITHOUT ADVANCED APPROVAL AND SCHEDULING BY THE OWNER. ELECTRICAL SERVICE EQUIPMENT AND UTILITIES (LIGHT POLES, SITE LIGHTING, ETC.), FIRE PROTECTION SYSTEM COMPONENTS (HYDRANTS, PIV, ETC.), HVAC EQUIPMENT, STORM DRAINAGE LINES AND CATCH BASINS, ETC. MAY EXIST WITHIN OR DIRECTLY ADJACENT TO PROPOSED STORAGE AND STAGING AREAS OR INTENDED. CONSTRUCTION TRAFFIC ROUTES MUST BE LOCATED AND MARKED TO ALLOW FOR PROTECTION AT ALL TIMES THROUGHOUT THE ROOF REPLACEMENT PROJECT. ACCESS TO THESE ITEMS FOR EMERGENCY USE MUST BE PROVIDED. COVERING OF UTILITIES WITH PERMANENT FIXTURES DURING CONSTRUCTION IS NOT ALLOWED.
- 9. CRANES UTILIZED FOR LOADING MATERIALS AND EQUIPMENT TO THE ROOF MUST BE OPERATED BY CERTIFIED CRANE OPERATORS. THE CONTRACTOR WILL BE RESPONSIBLE FOR COORDINATING ACCEPTABLE CRANE LIFT DATES IN ADVANCE WITH THE OWNER AND FOR PROVIDING ALL REQUIRED/REQUESTED CRANE LIFT PLANS AND INFORMATION REQUIRED BY

OVERHEAD PROTECTION


- CAMPUS RECREATION CENTER (NOT IN CONTRACT)

REID BUILDING

# REID

SITE


REVISION drawn by: HMF 'engineer: HMF approval: KEW DATE: MAY 2023 PROJ.: J2626 SCALE: AS SHOW DWG. NO.

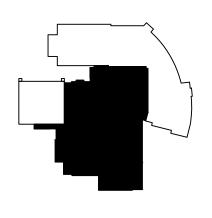

**KEY PLAN** 


1 SITE PLAN - STAGING AND STORAGE 1.0 SCALE: NOT TO SCALE

CONTRACTOR MUST MAINTAIN ACCESS

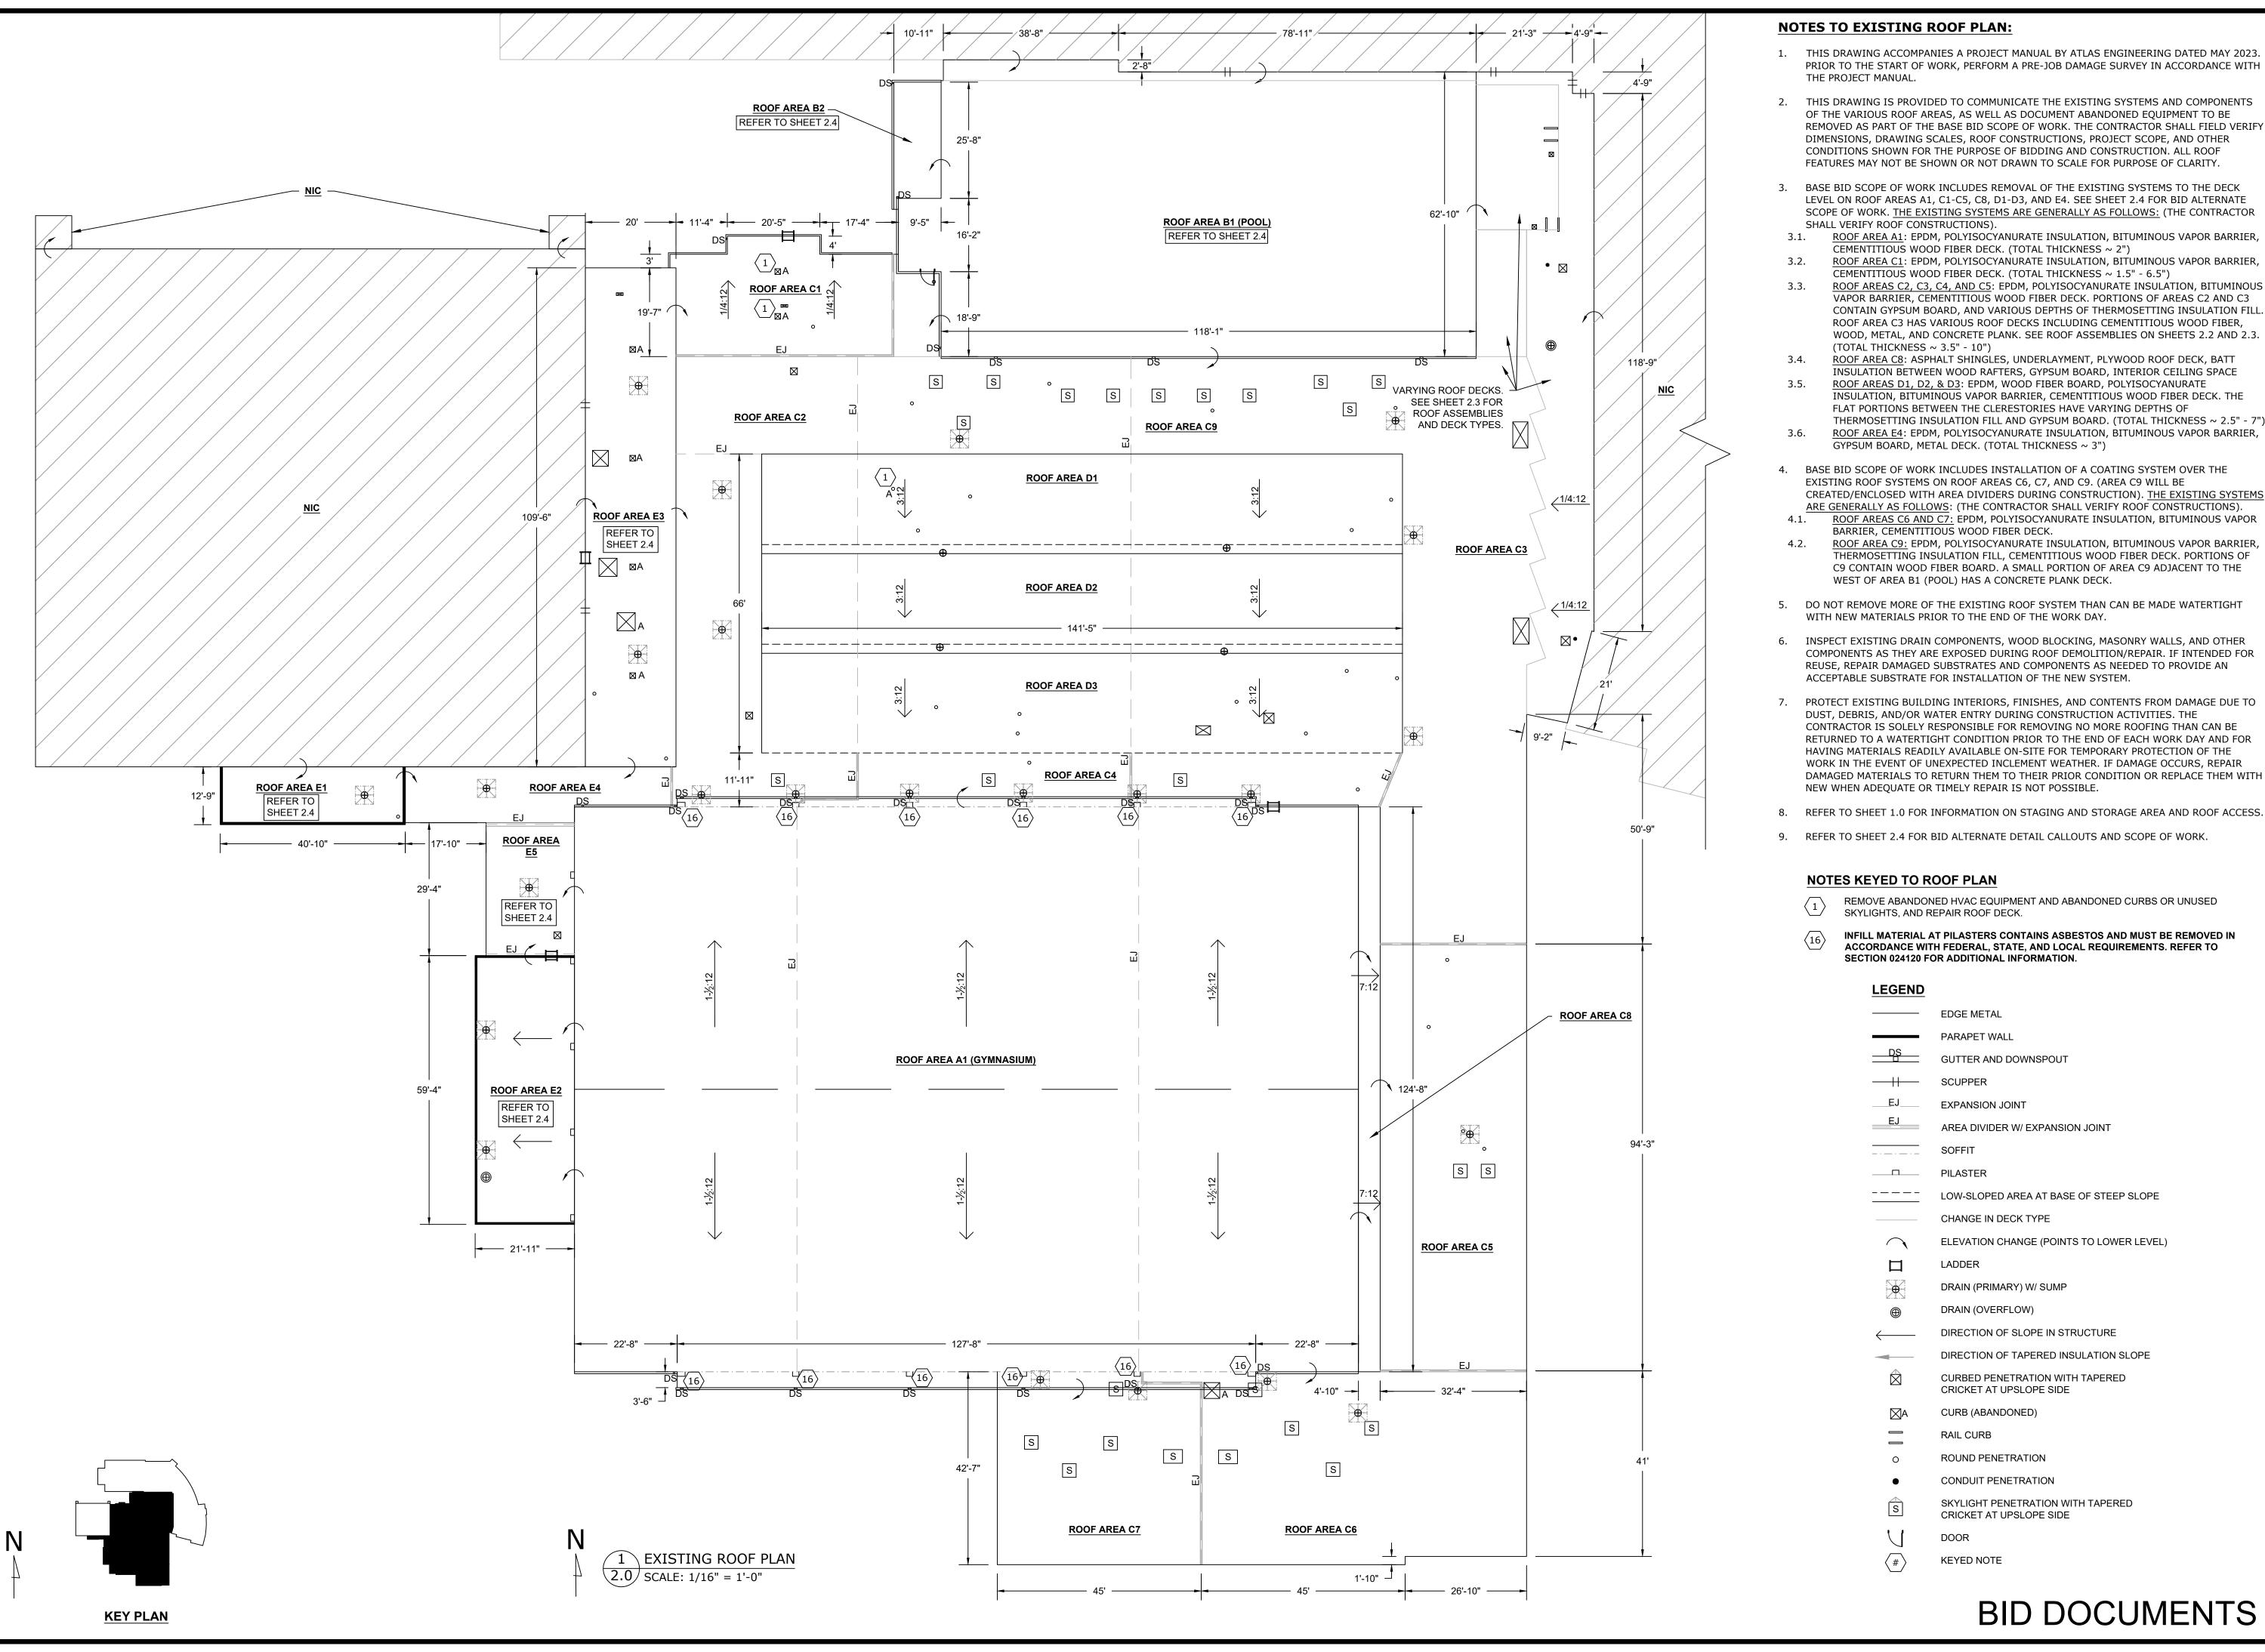

- 2. THIS DRAWING IS PROVIDED TO COMMUNICATE THE EXISTING SYSTEMS AND COMPONENTS REMOVED AS PART OF THE BASE BID SCOPE OF WORK. THE CONTRACTOR SHALL FIELD VERIFY
- LEVEL ON ROOF AREAS A1, C1-C5, C8, D1-D3, AND E4. SEE SHEET 2.4 FOR BID ALTERNATE SCOPE OF WORK. THE EXISTING SYSTEMS ARE GENERALLY AS FOLLOWS: (THE CONTRACTOR
  - ROOF AREA A1: EPDM, POLYISOCYANURATE INSULATION, BITUMINOUS VAPOR BARRIER,
  - ROOF AREA C1: EPDM, POLYISOCYANURATE INSULATION, BITUMINOUS VAPOR BARRIER,
- VAPOR BARRIER, CEMENTITIOUS WOOD FIBER DECK. PORTIONS OF AREAS C2 AND C3 CONTAIN GYPSUM BOARD, AND VARIOUS DEPTHS OF THERMOSETTING INSULATION FILL. ROOF AREA C3 HAS VARIOUS ROOF DECKS INCLUDING CEMENTITIOUS WOOD FIBER, WOOD, METAL, AND CONCRETE PLANK. SEE ROOF ASSEMBLIES ON SHEETS 2.2 AND 2.3.
- INSULATION, BITUMINOUS VAPOR BARRIER, CEMENTITIOUS WOOD FIBER DECK. THE
- ROOF AREA E4: EPDM, POLYISOCYANURATE INSULATION, BITUMINOUS VAPOR BARRIER,
- ROOF AREA C9: EPDM, POLYISOCYANURATE INSULATION, BITUMINOUS VAPOR BARRIER,
- THERMOSETTING INSULATION FILL, CEMENTITIOUS WOOD FIBER DECK. PORTIONS OF C9 CONTAIN WOOD FIBER BOARD. A SMALL PORTION OF AREA C9 ADJACENT TO THE
- COMPONENTS AS THEY ARE EXPOSED DURING ROOF DEMOLITION/REPAIR. IF INTENDED FOR
- RETURNED TO A WATERTIGHT CONDITION PRIOR TO THE END OF EACH WORK DAY AND FOR WORK IN THE EVENT OF UNEXPECTED INCLEMENT WEATHER. IF DAMAGE OCCURS, REPAIR DAMAGED MATERIALS TO RETURN THEM TO THEIR PRIOR CONDITION OR REPLACE THEM WITH
- 8. REFER TO SHEET 1.0 FOR INFORMATION ON STAGING AND STORAGE AREA AND ROOF ACCESS.




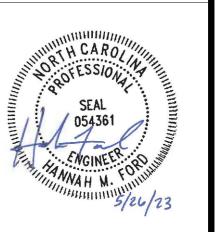



EMENT PLA RE <u>O</u> K 4 SCO ID#: 2 REID


REVISION DRAWN BY: HMF 'ENGINEER: HMF approval: KEW DATE: MAY 2023

PROJ.: J2626 | SCALE: AS SHOW DWG. NO.

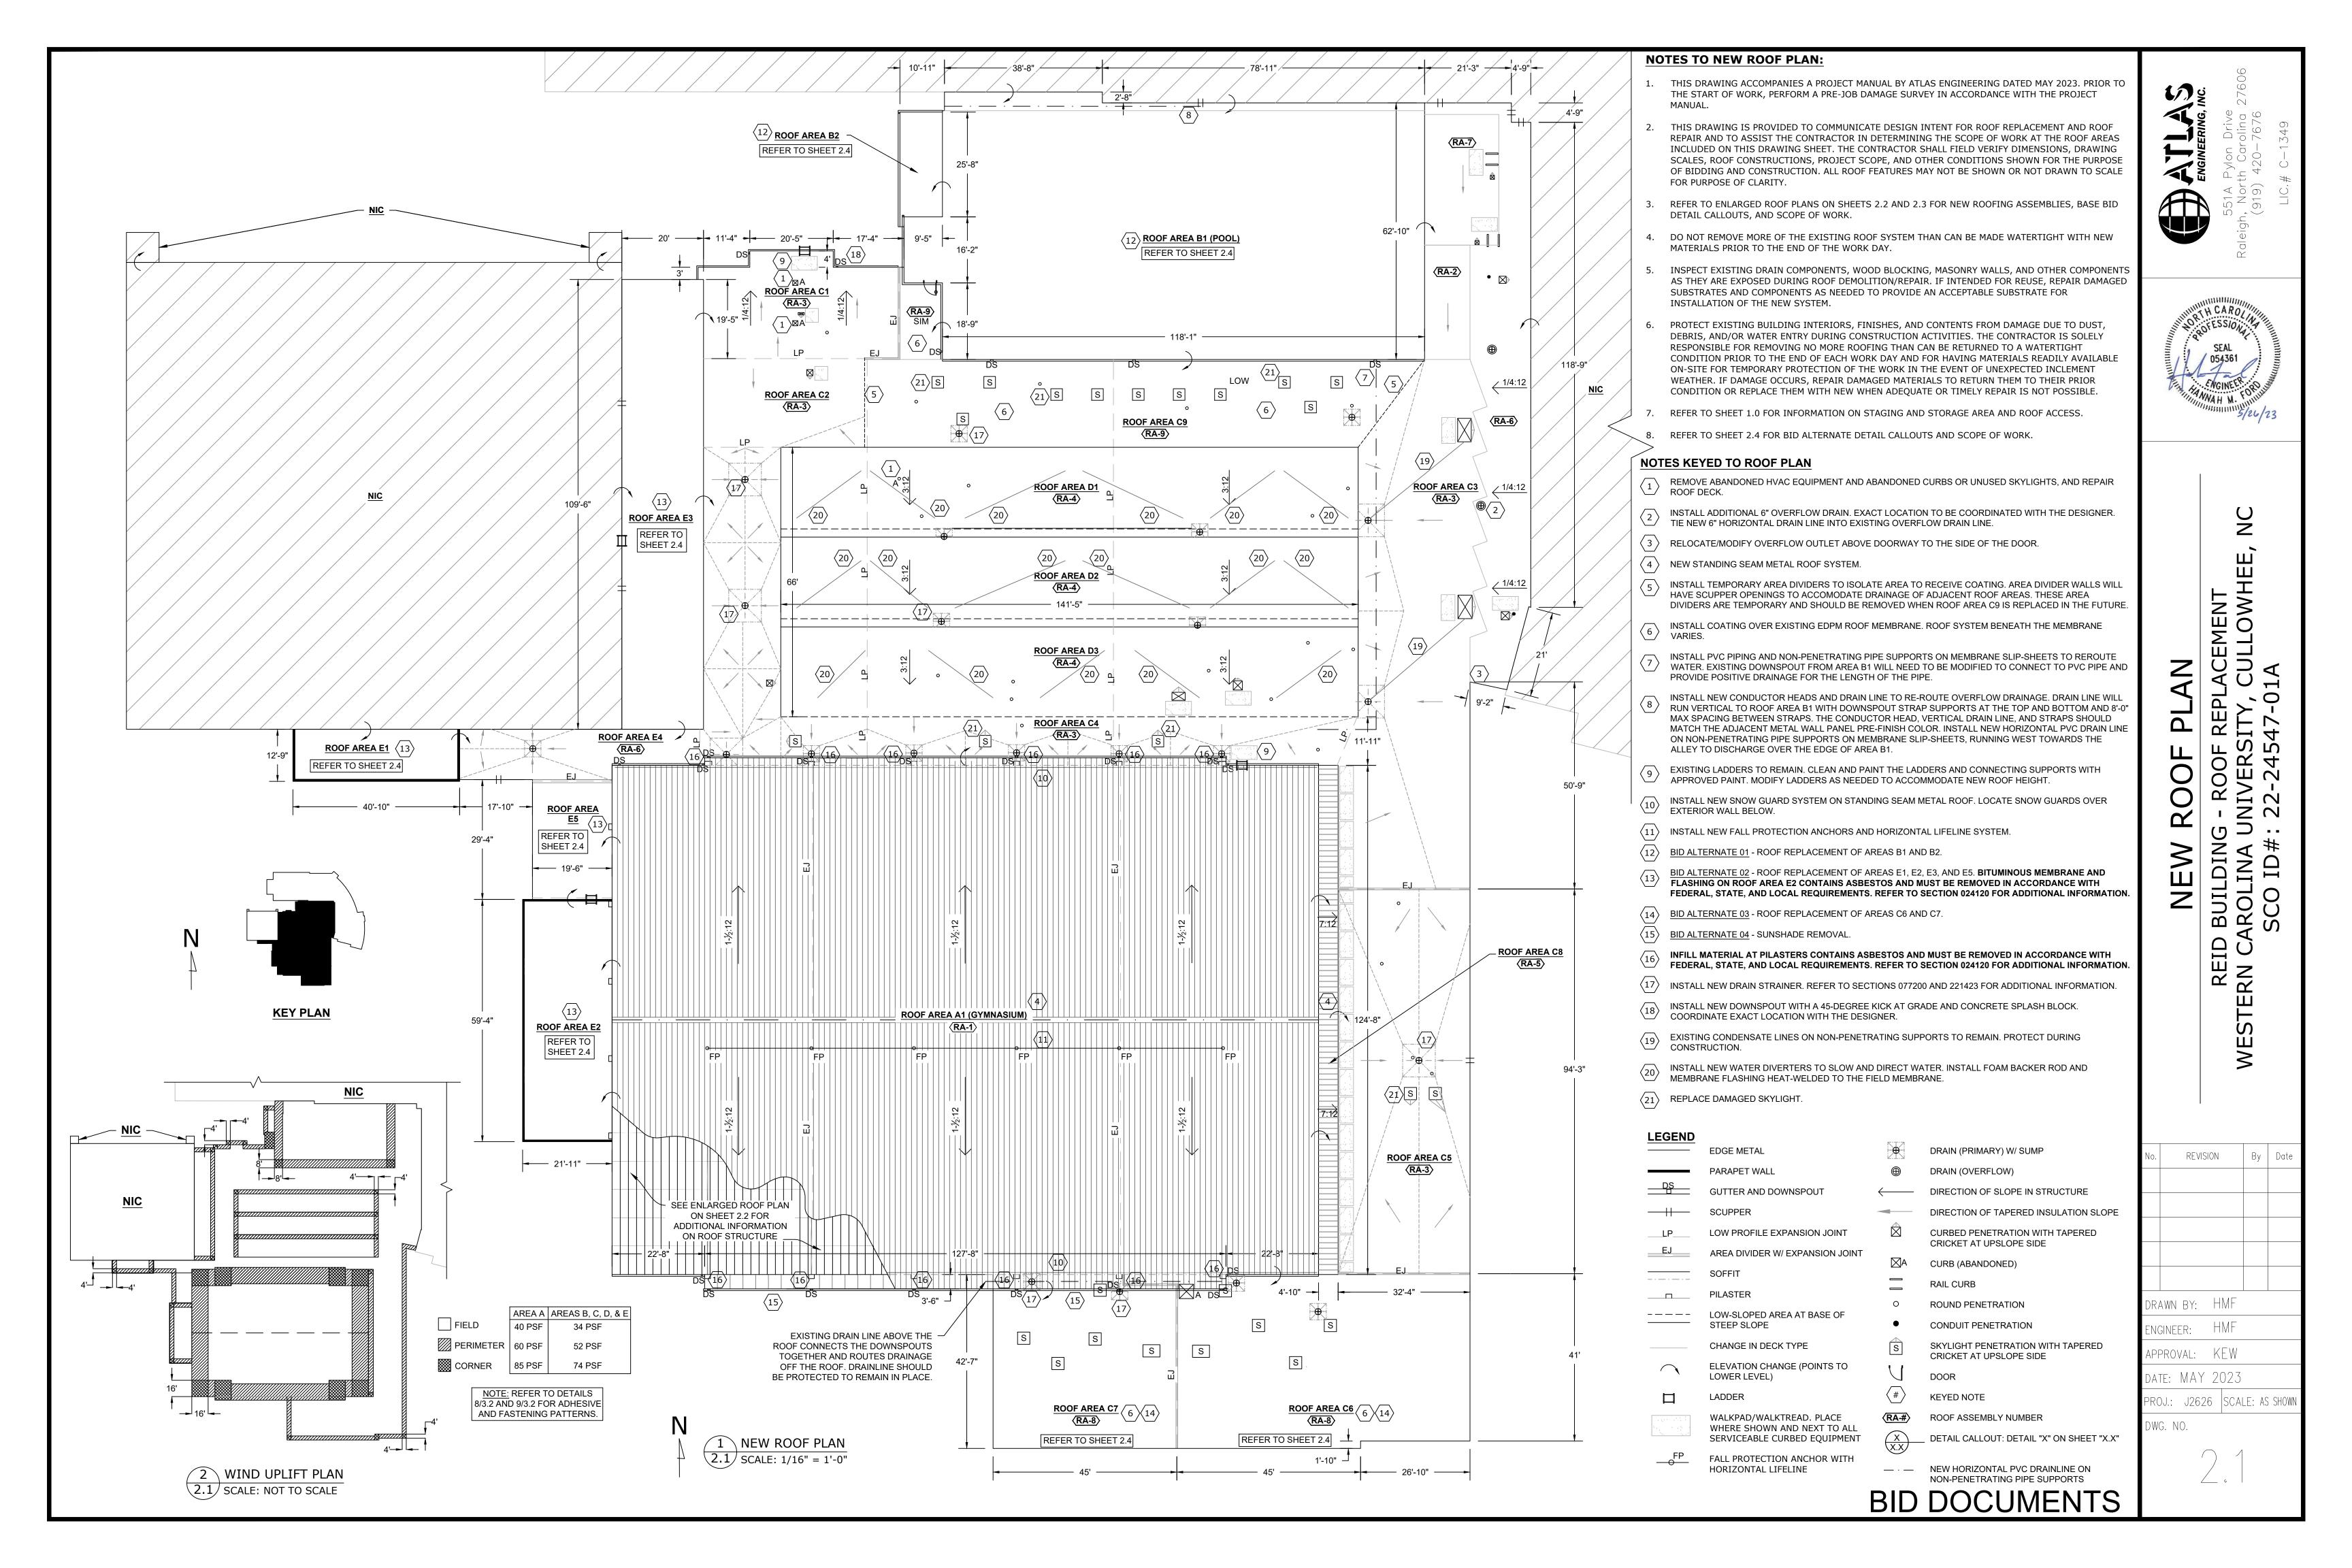

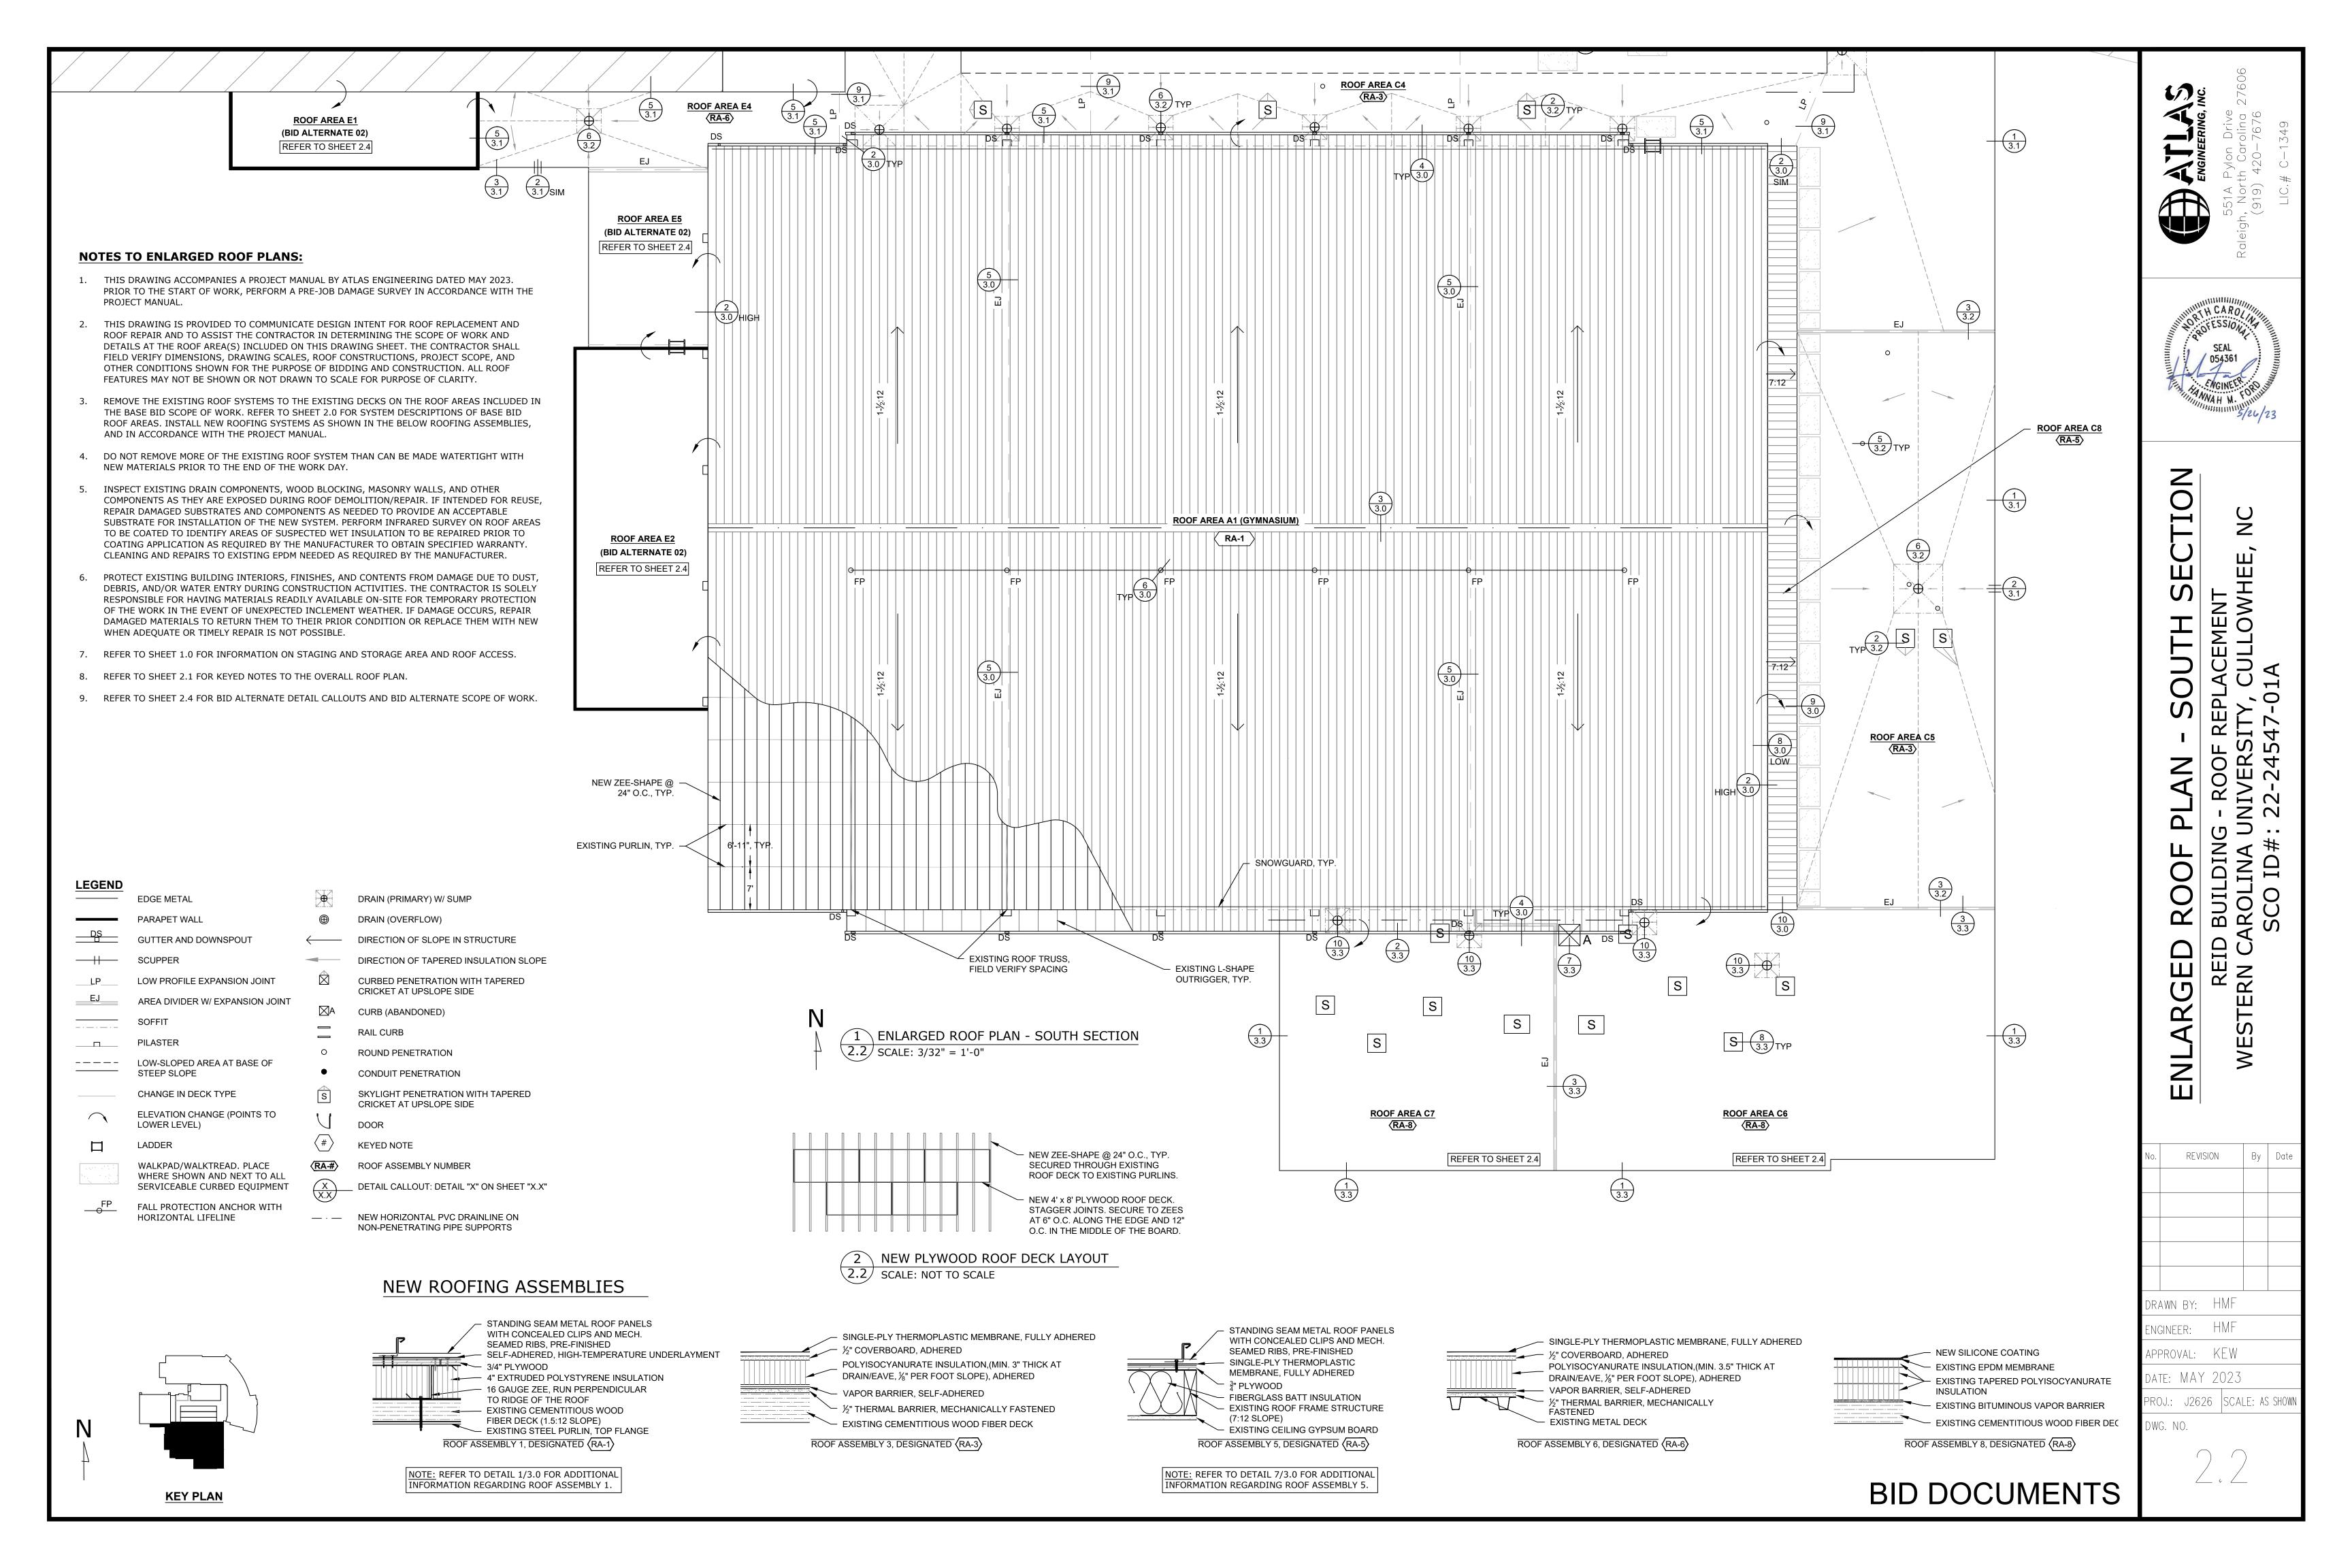


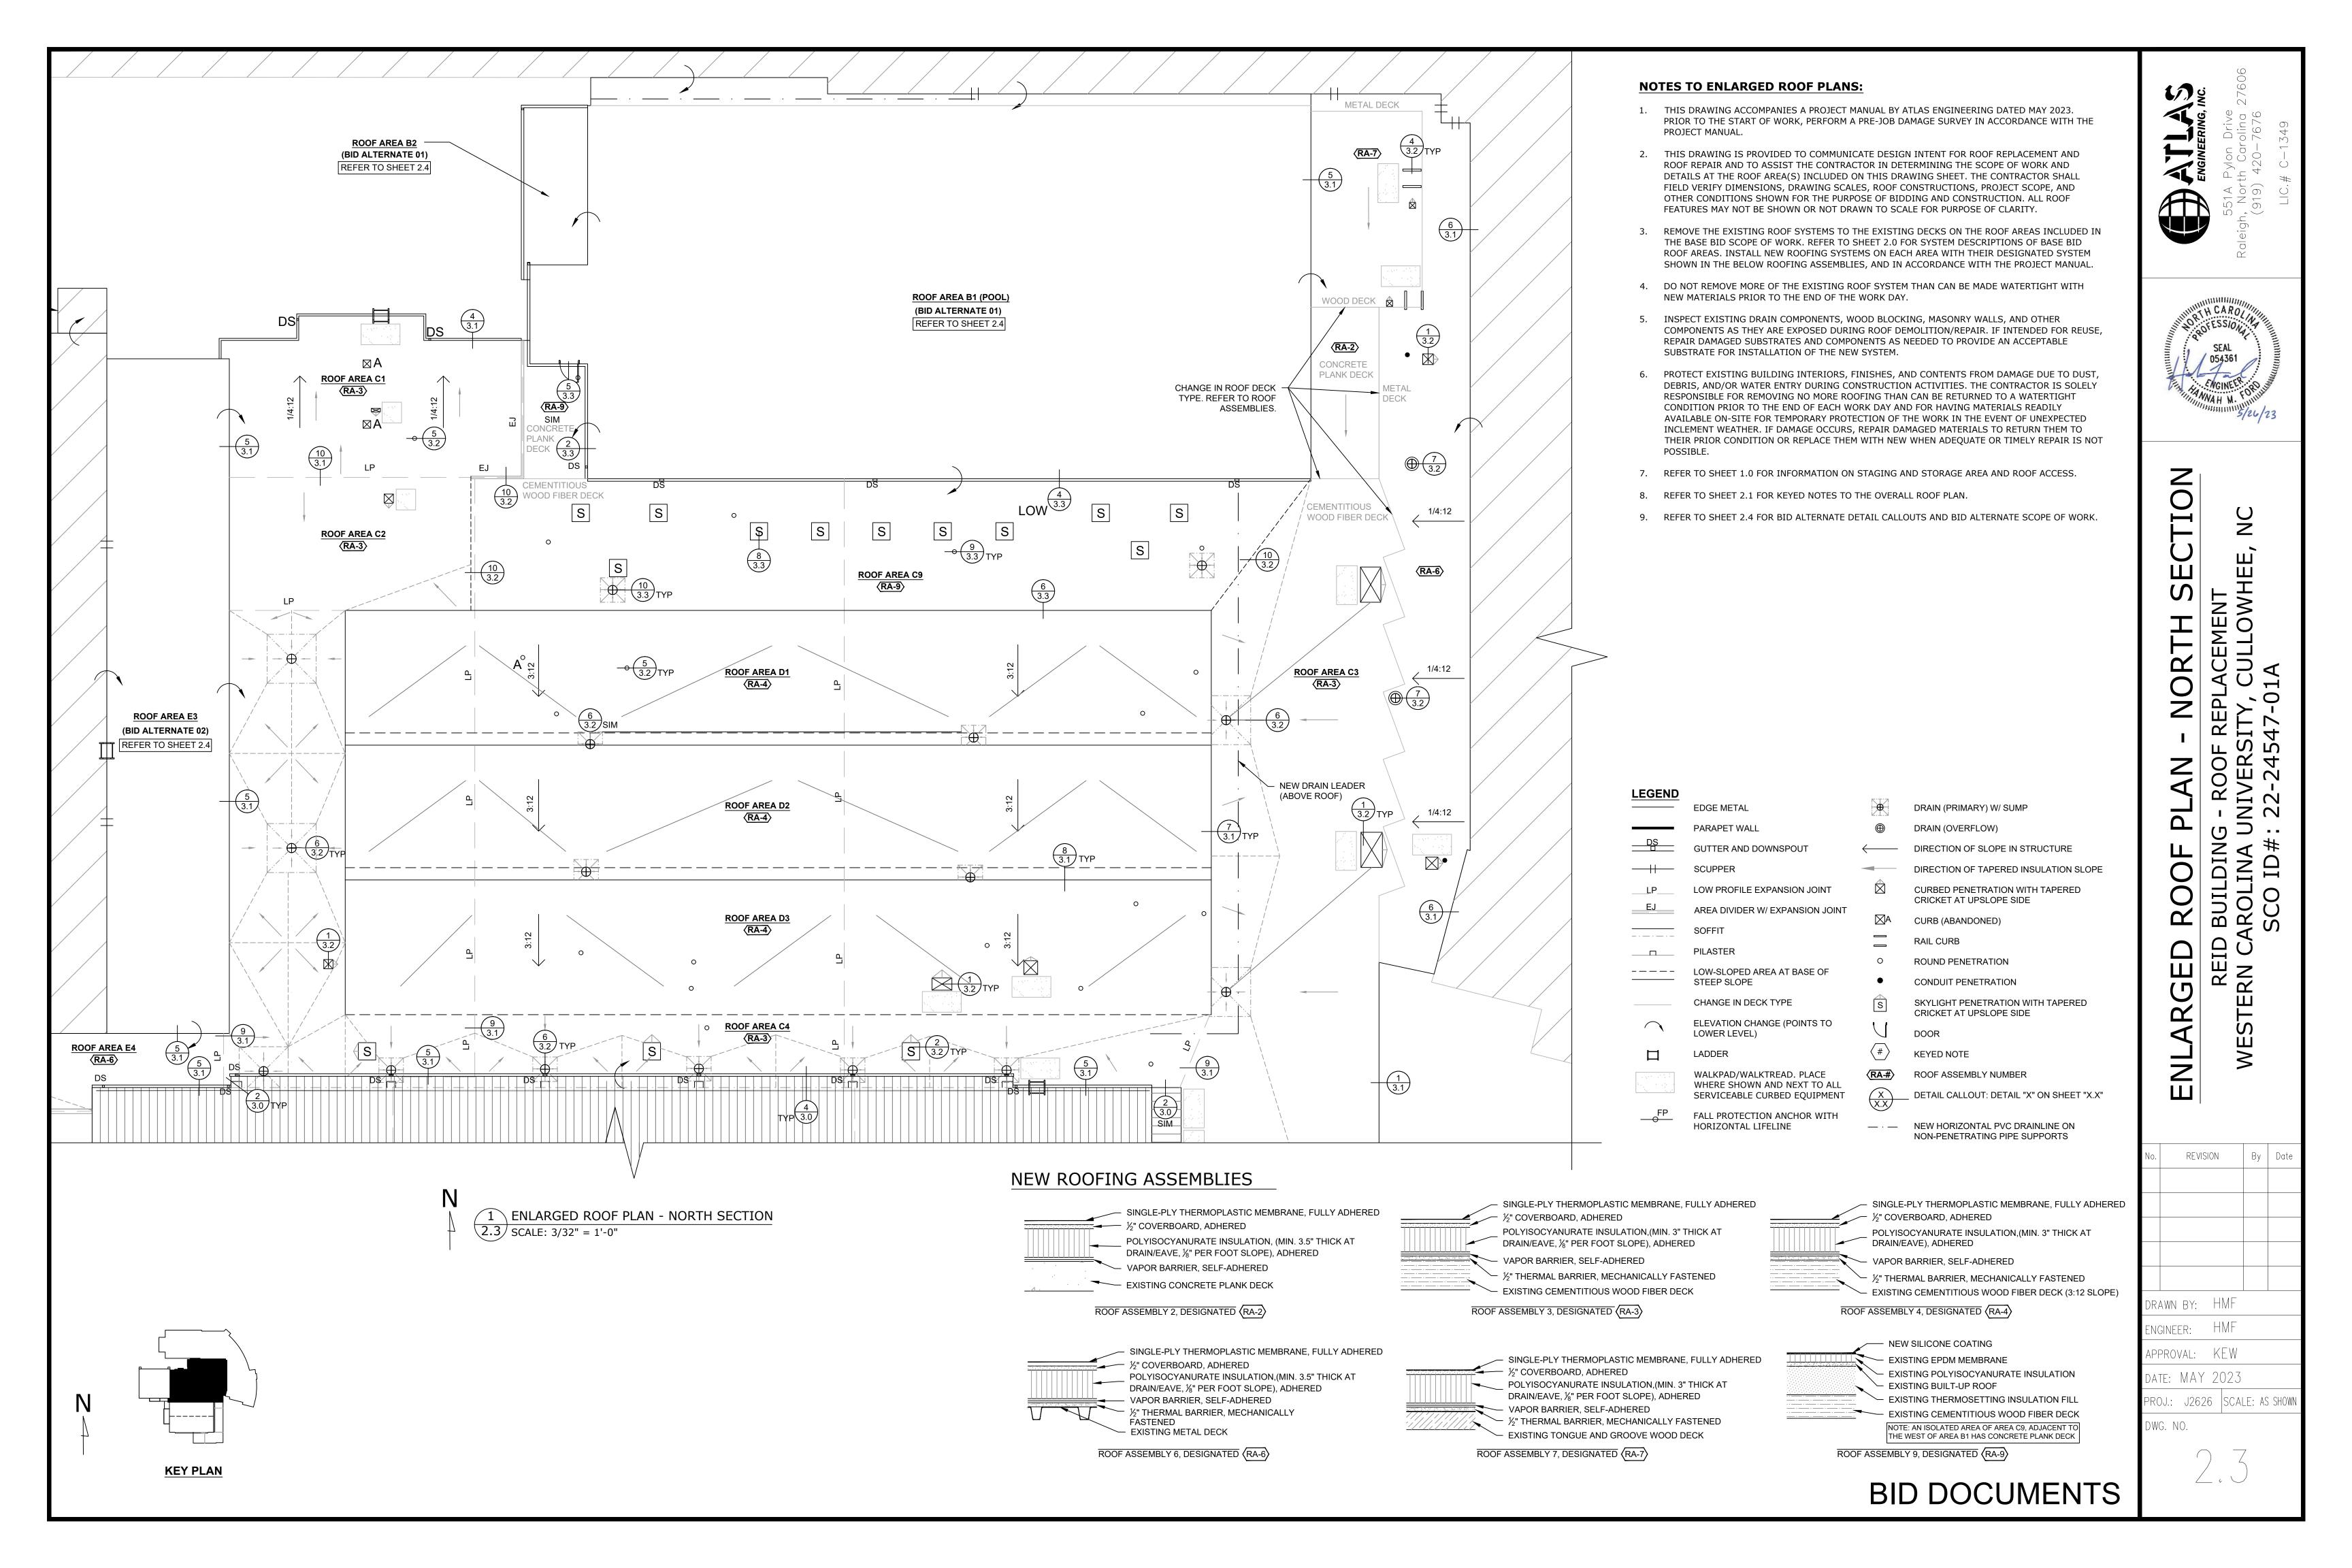

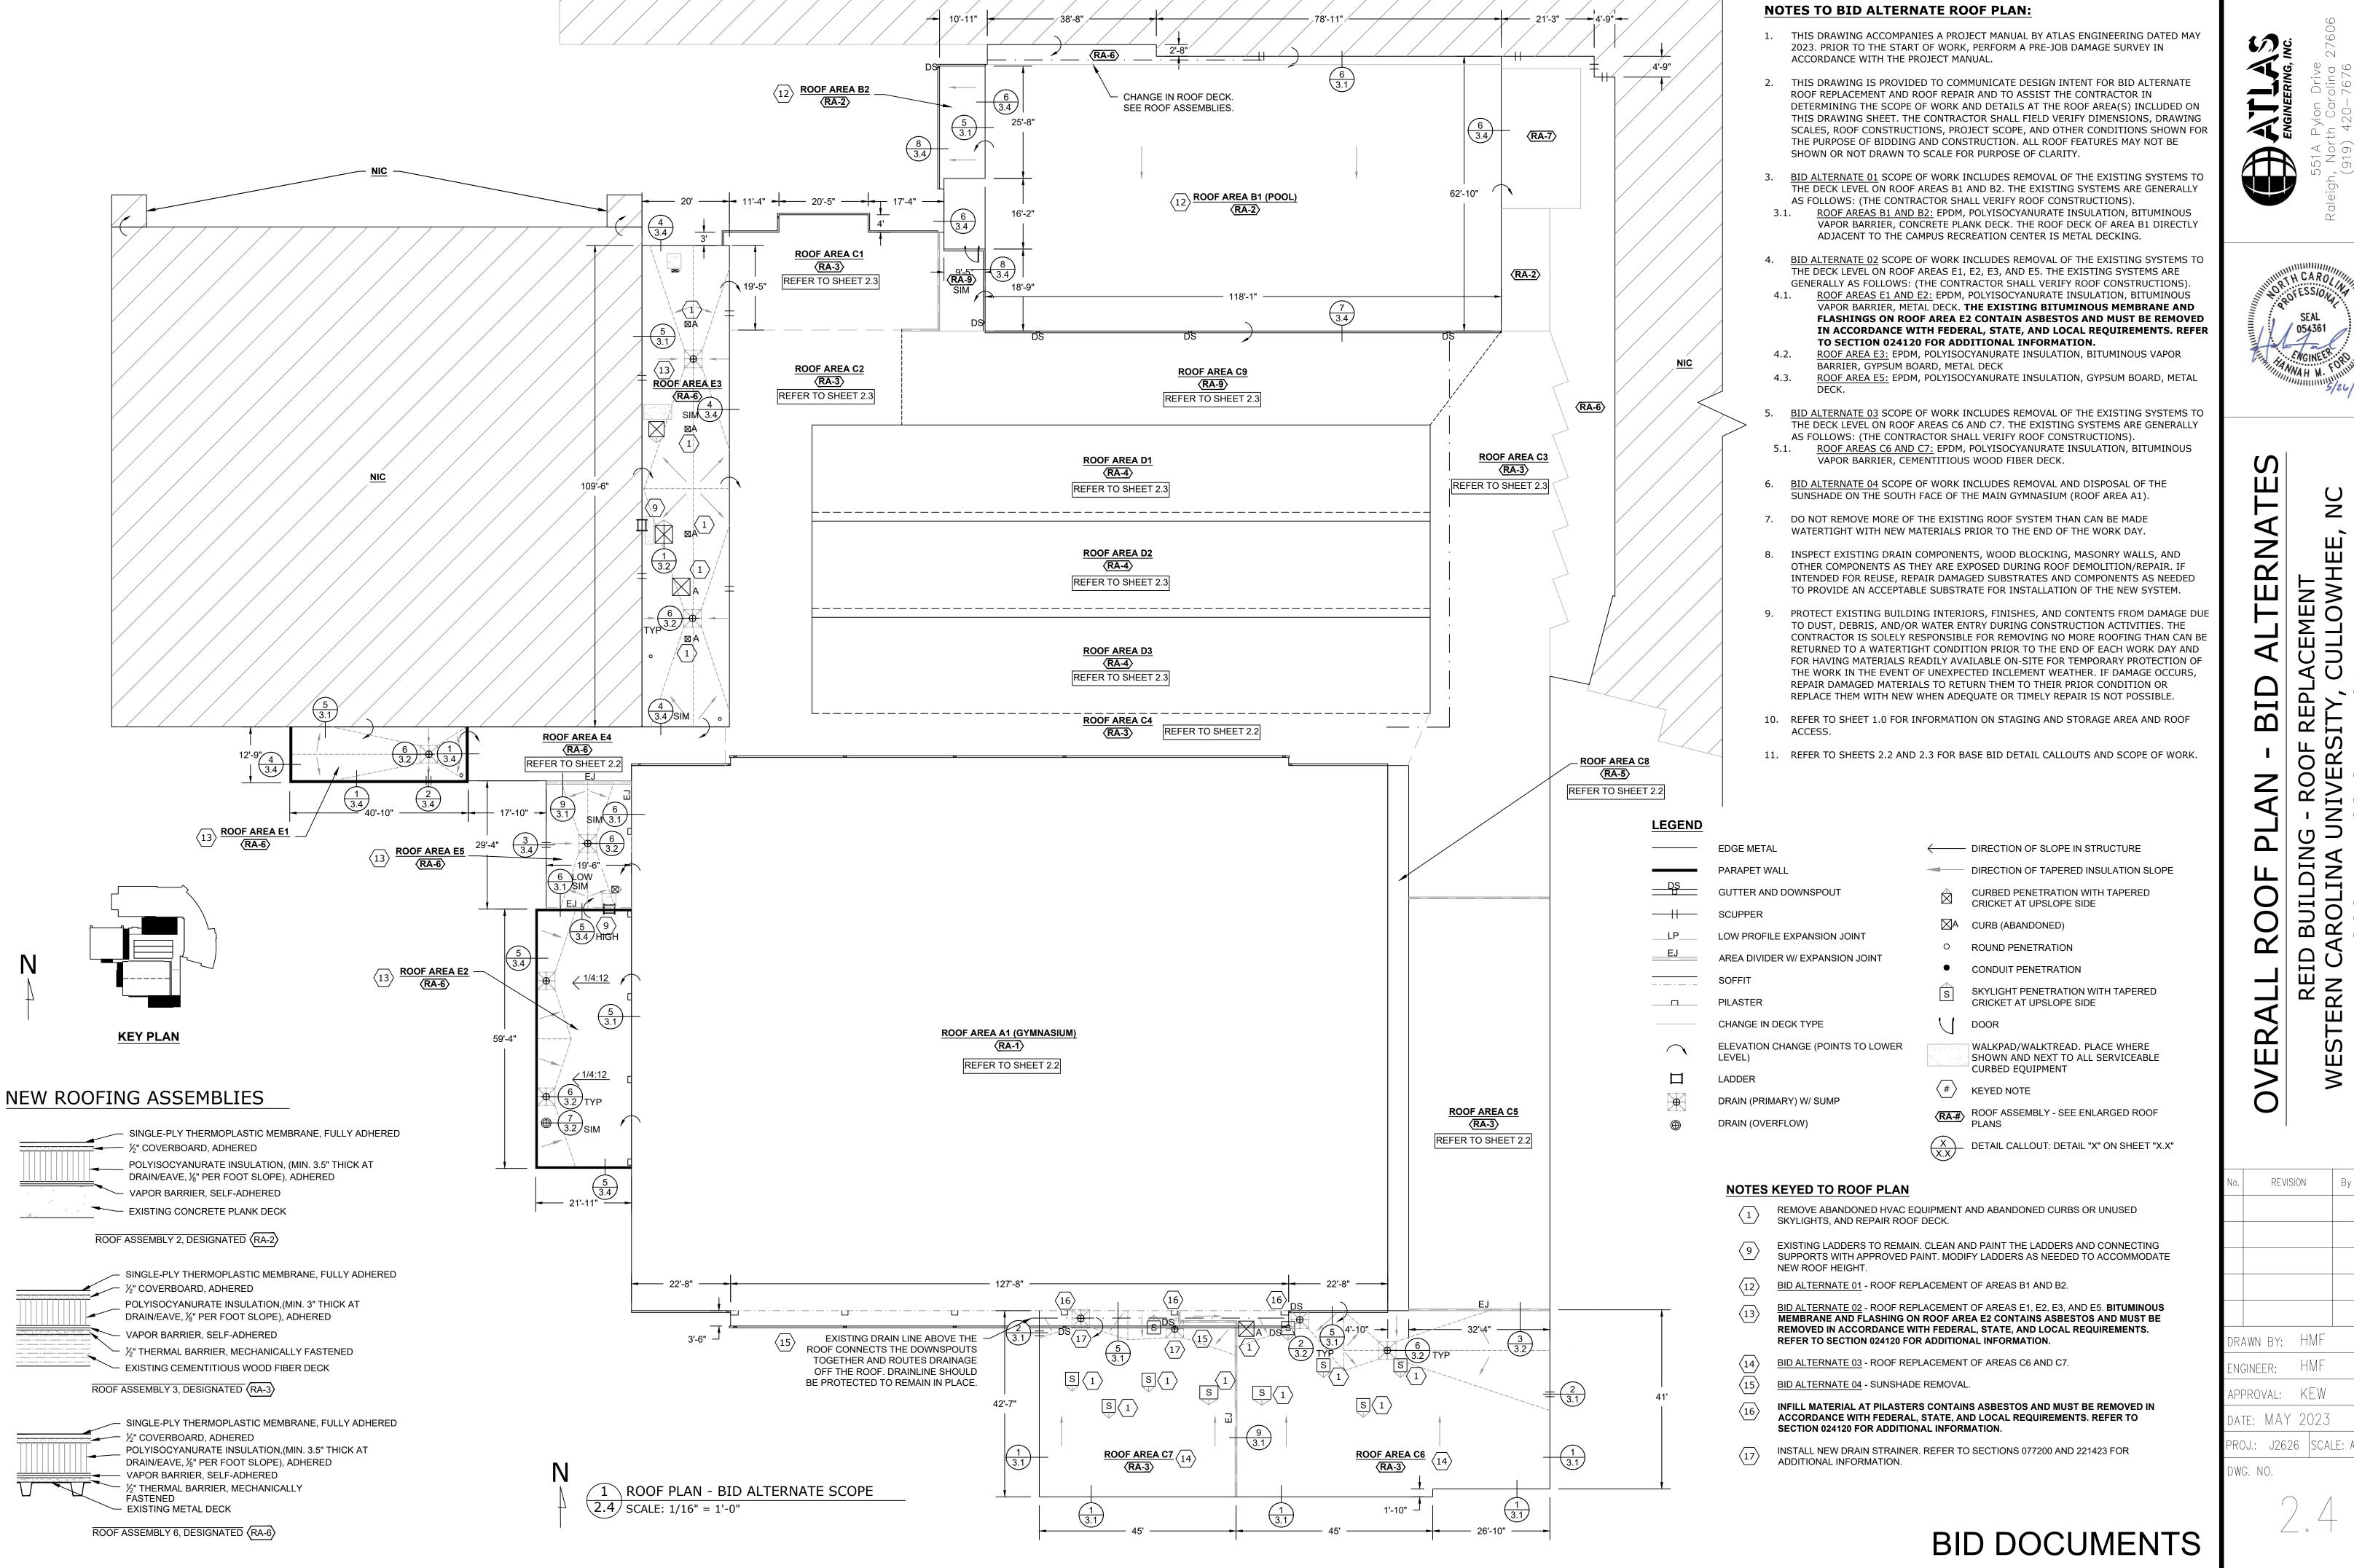




PROJ.: J2626 | SCALE: AS SHOW

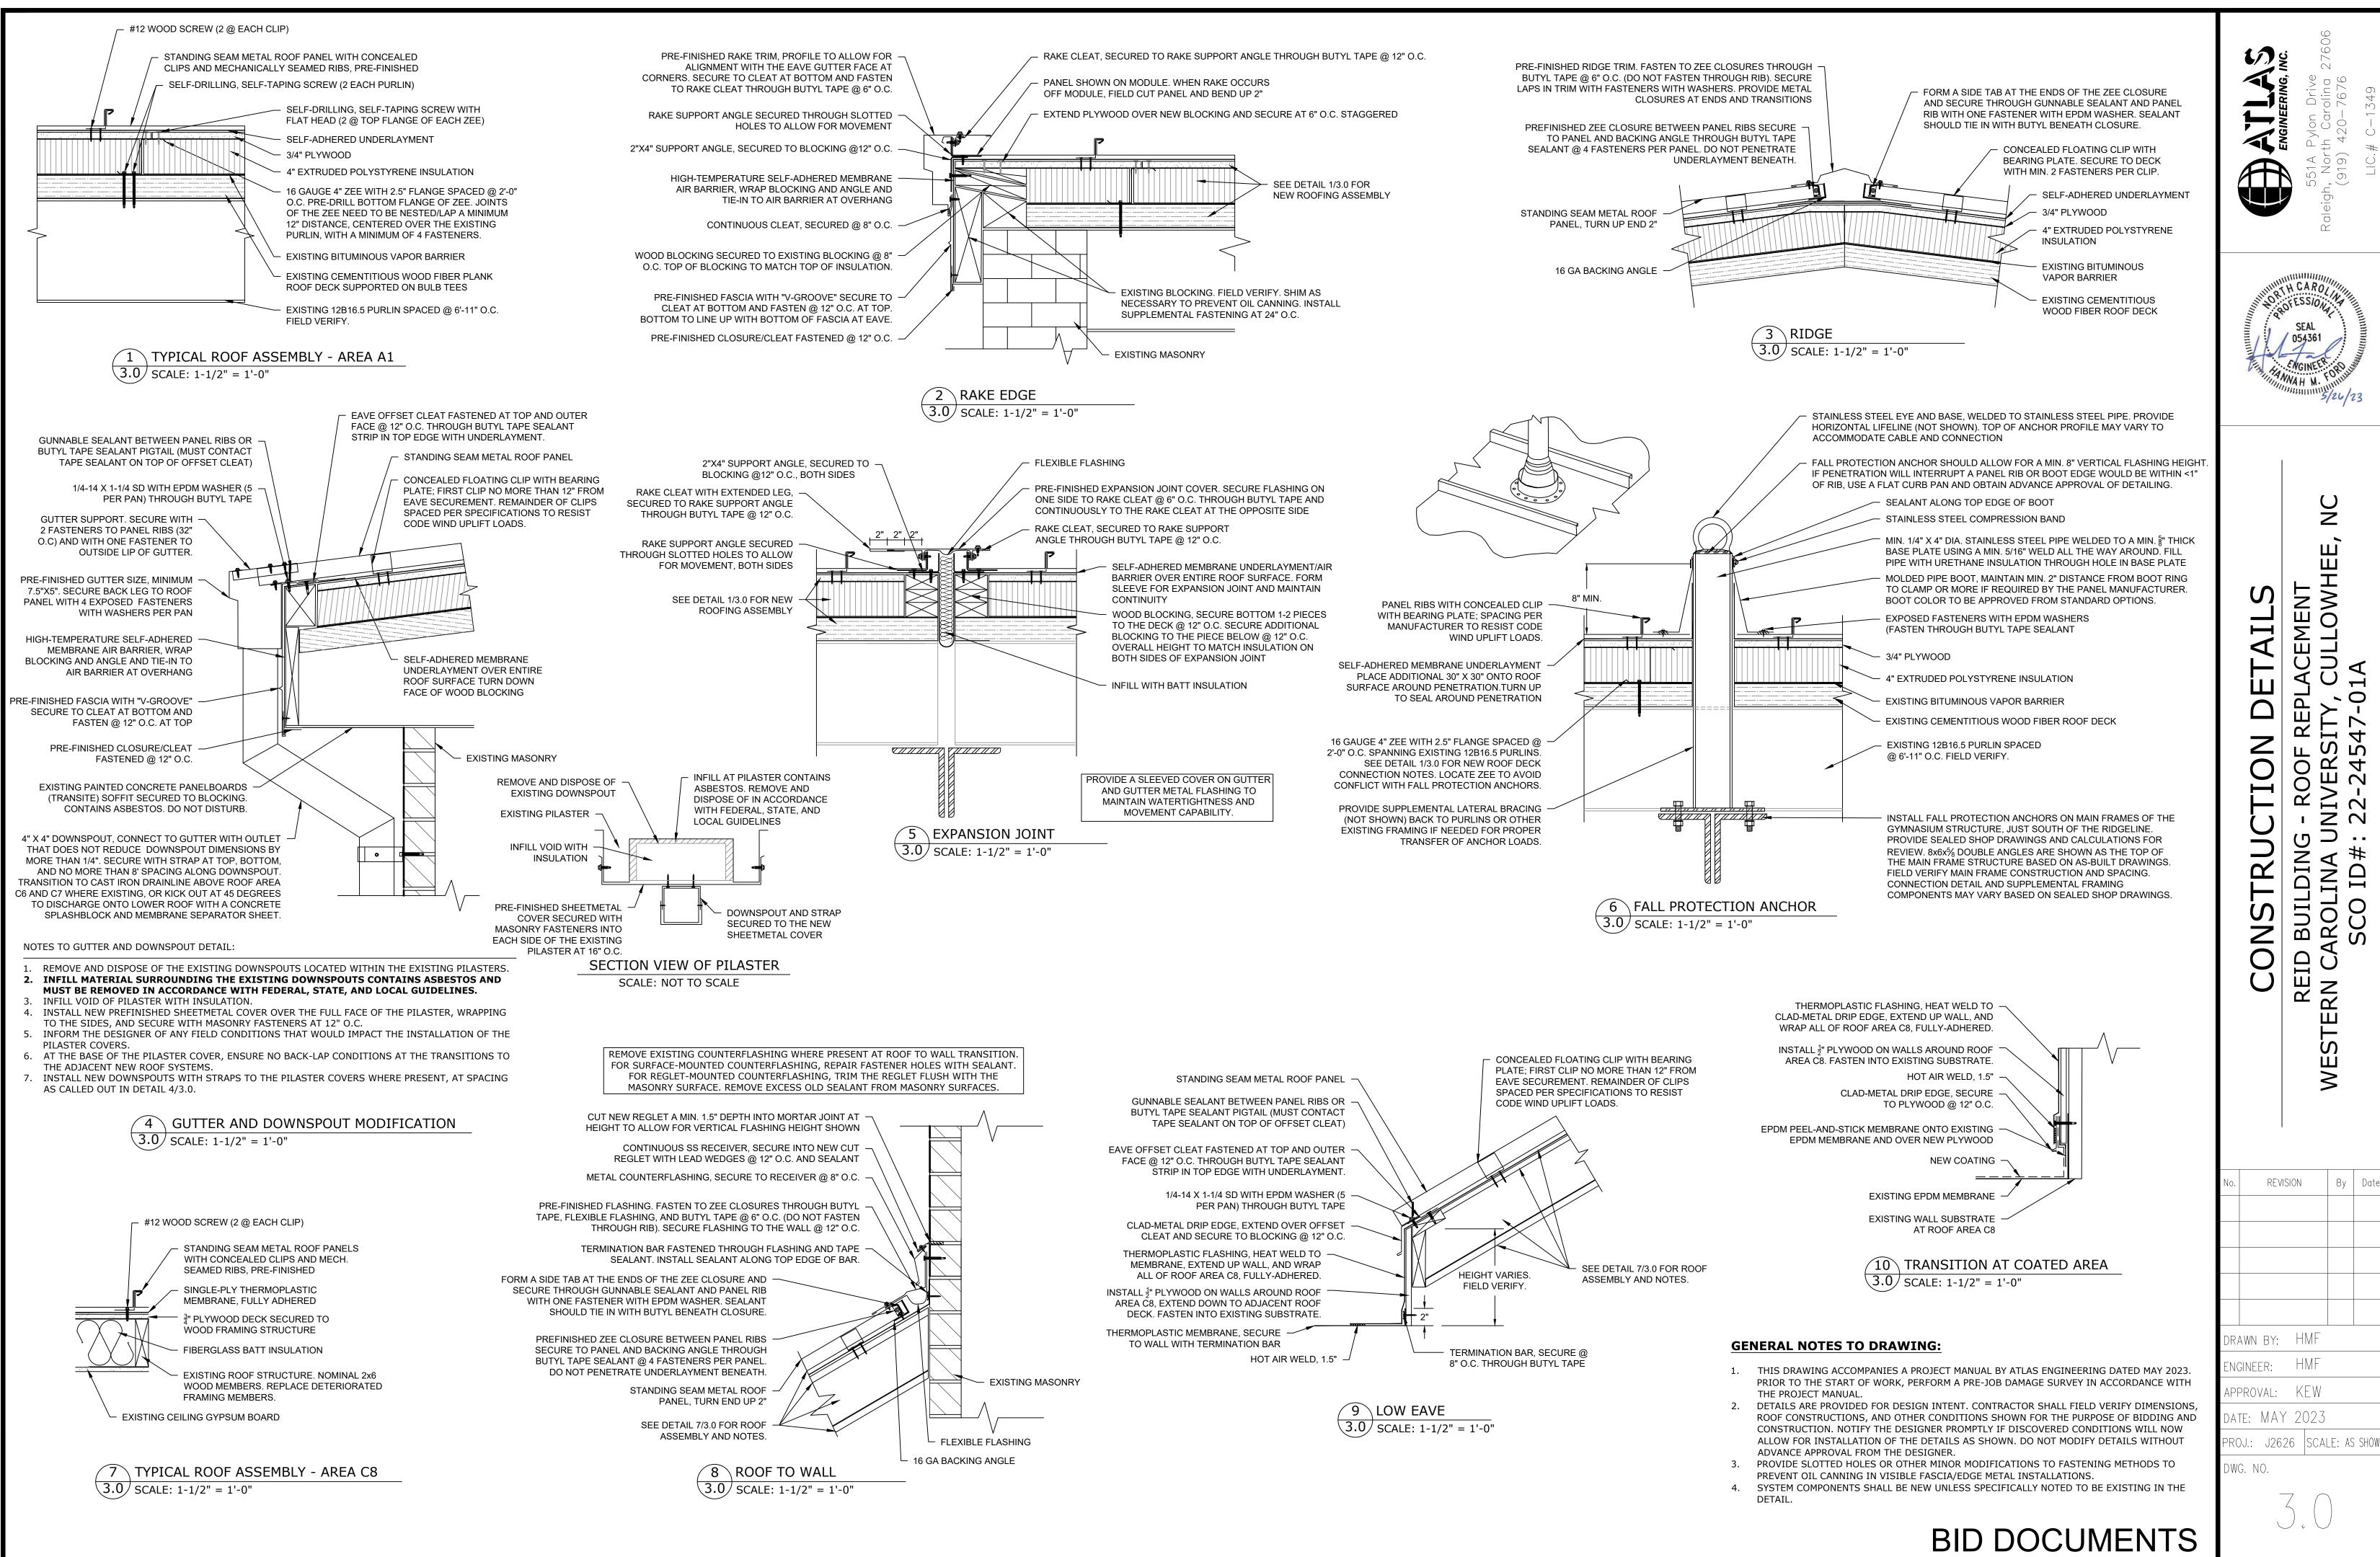

0 2 BUILDING -AROLINA UN SCO ID#: 7

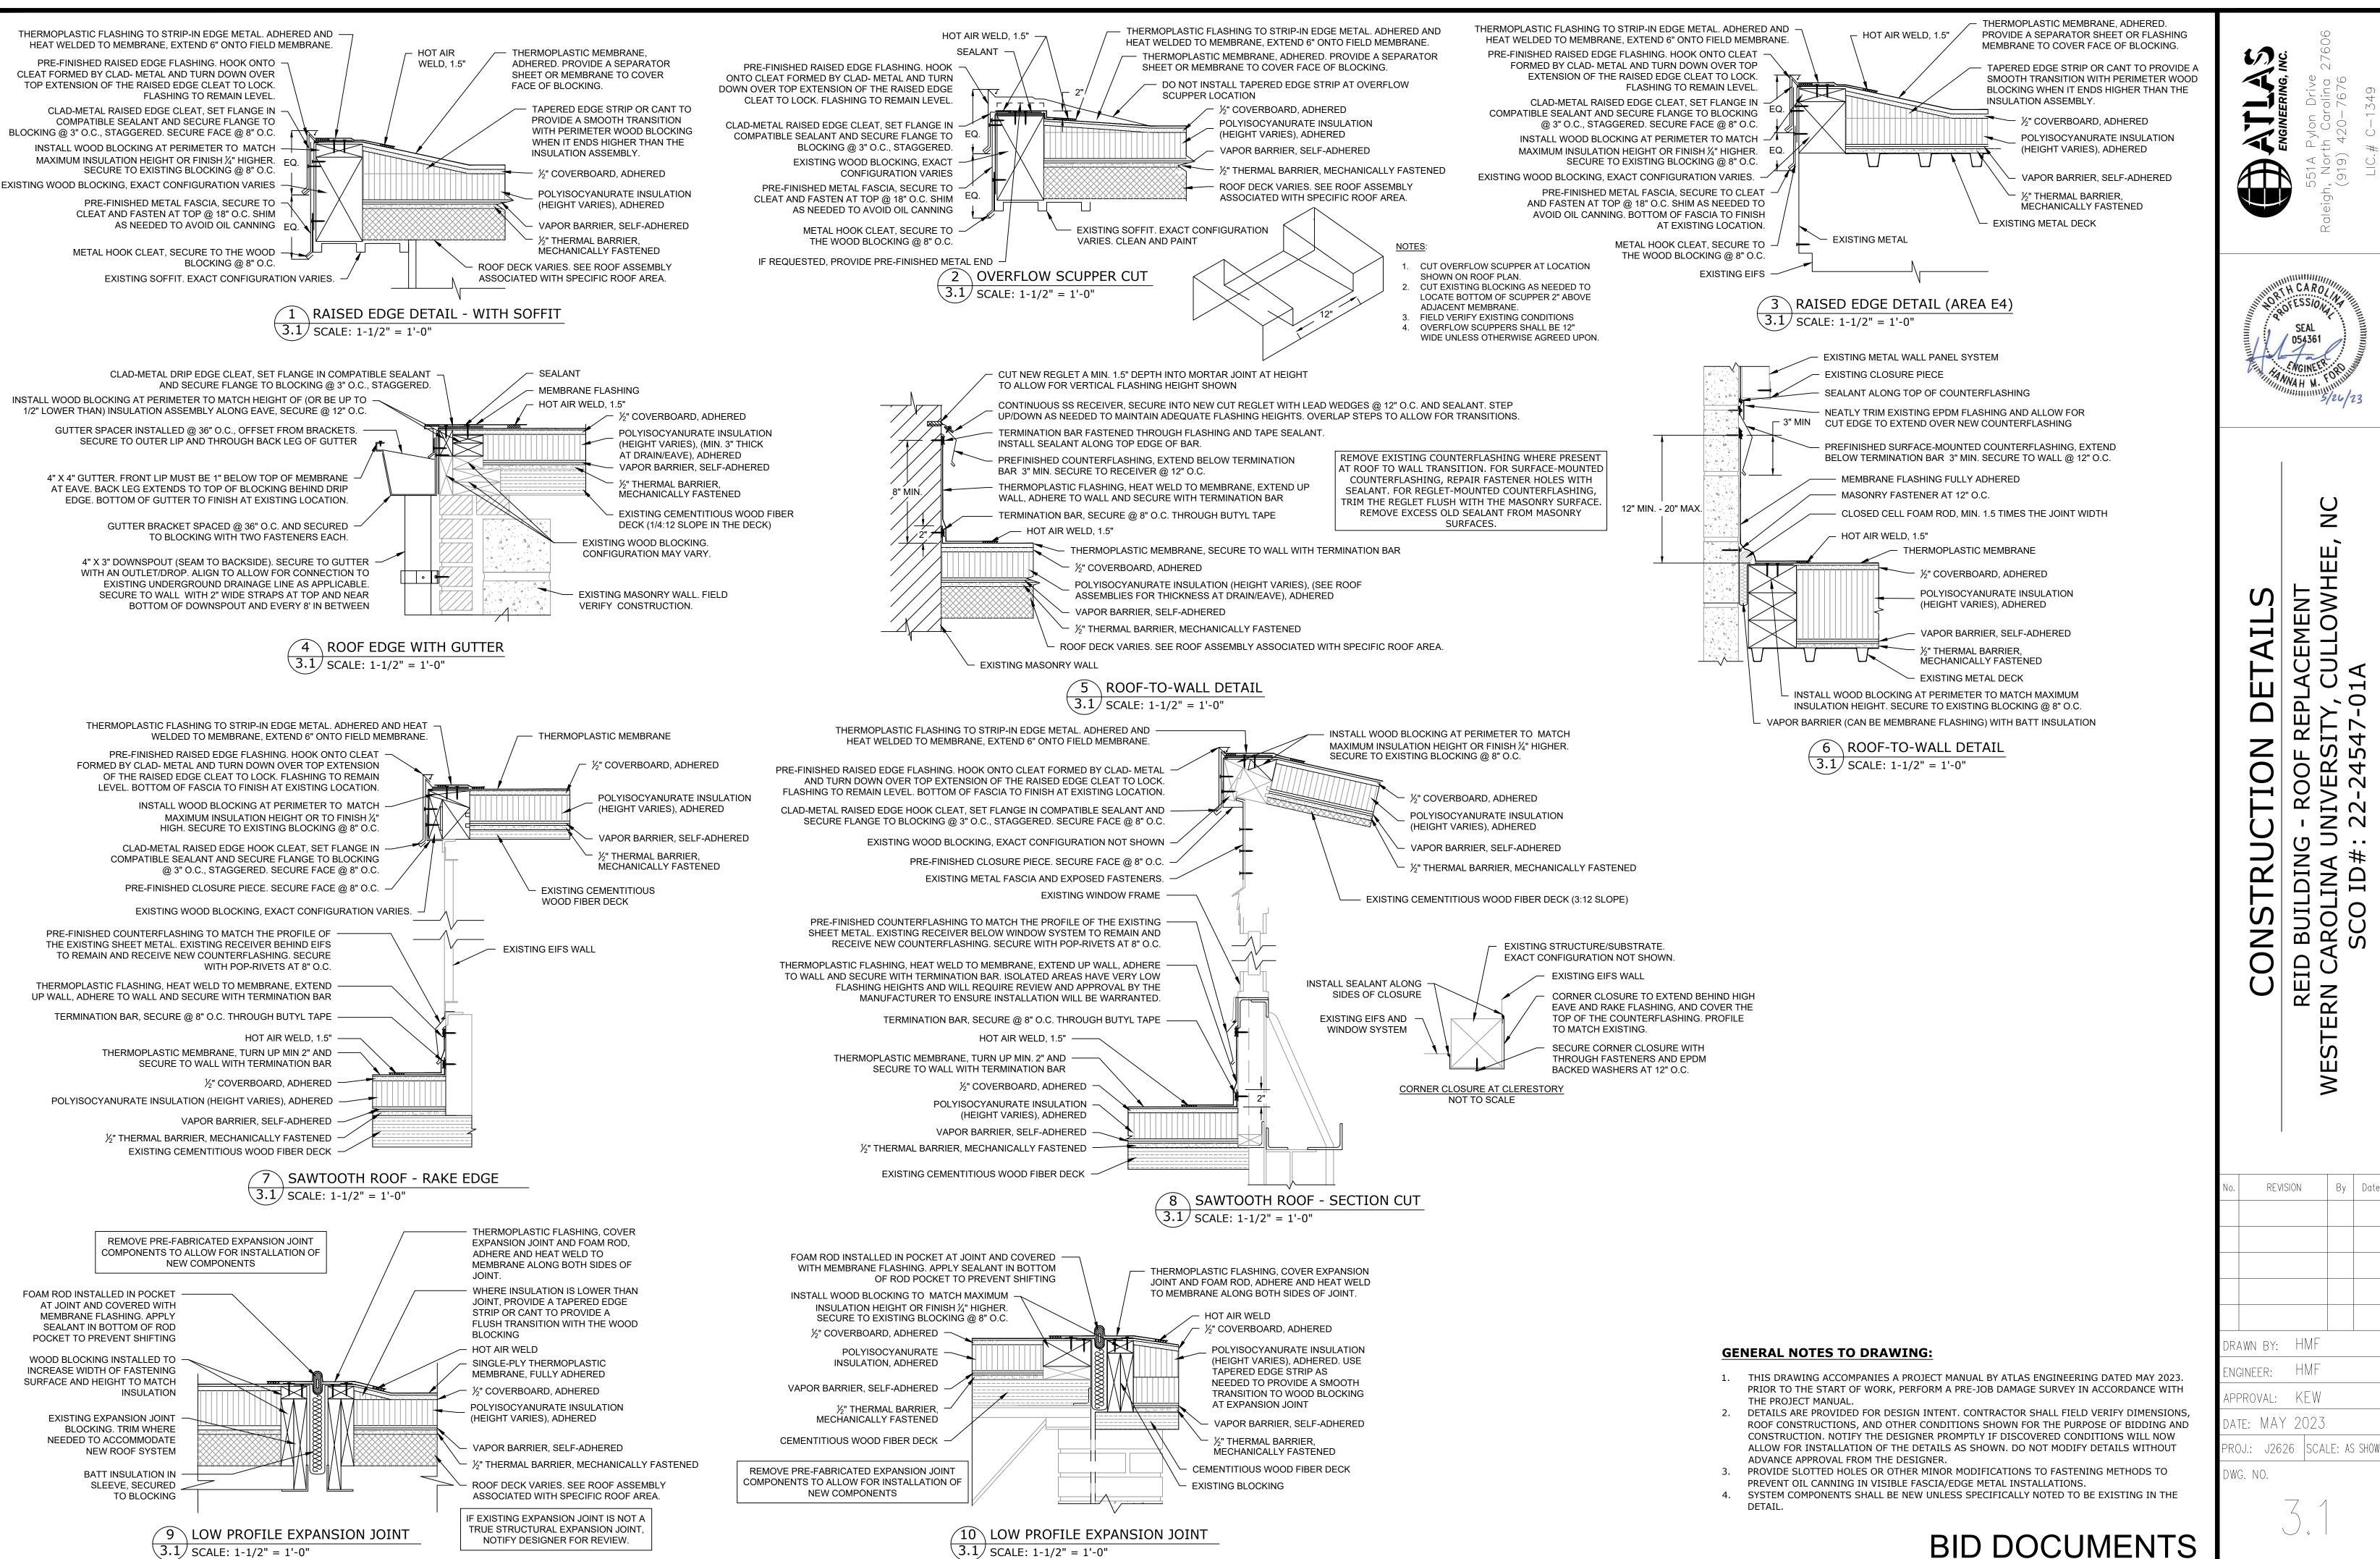


(3.1) SCALE: 1-1/2" = 1'-0"

3.1 SCALE: 1-1/2" = 1'-0"

 $\Xi$ Σ  $\Delta$  $\circ$ AROLINA UN SCO ID#: 2 REID

REVISION



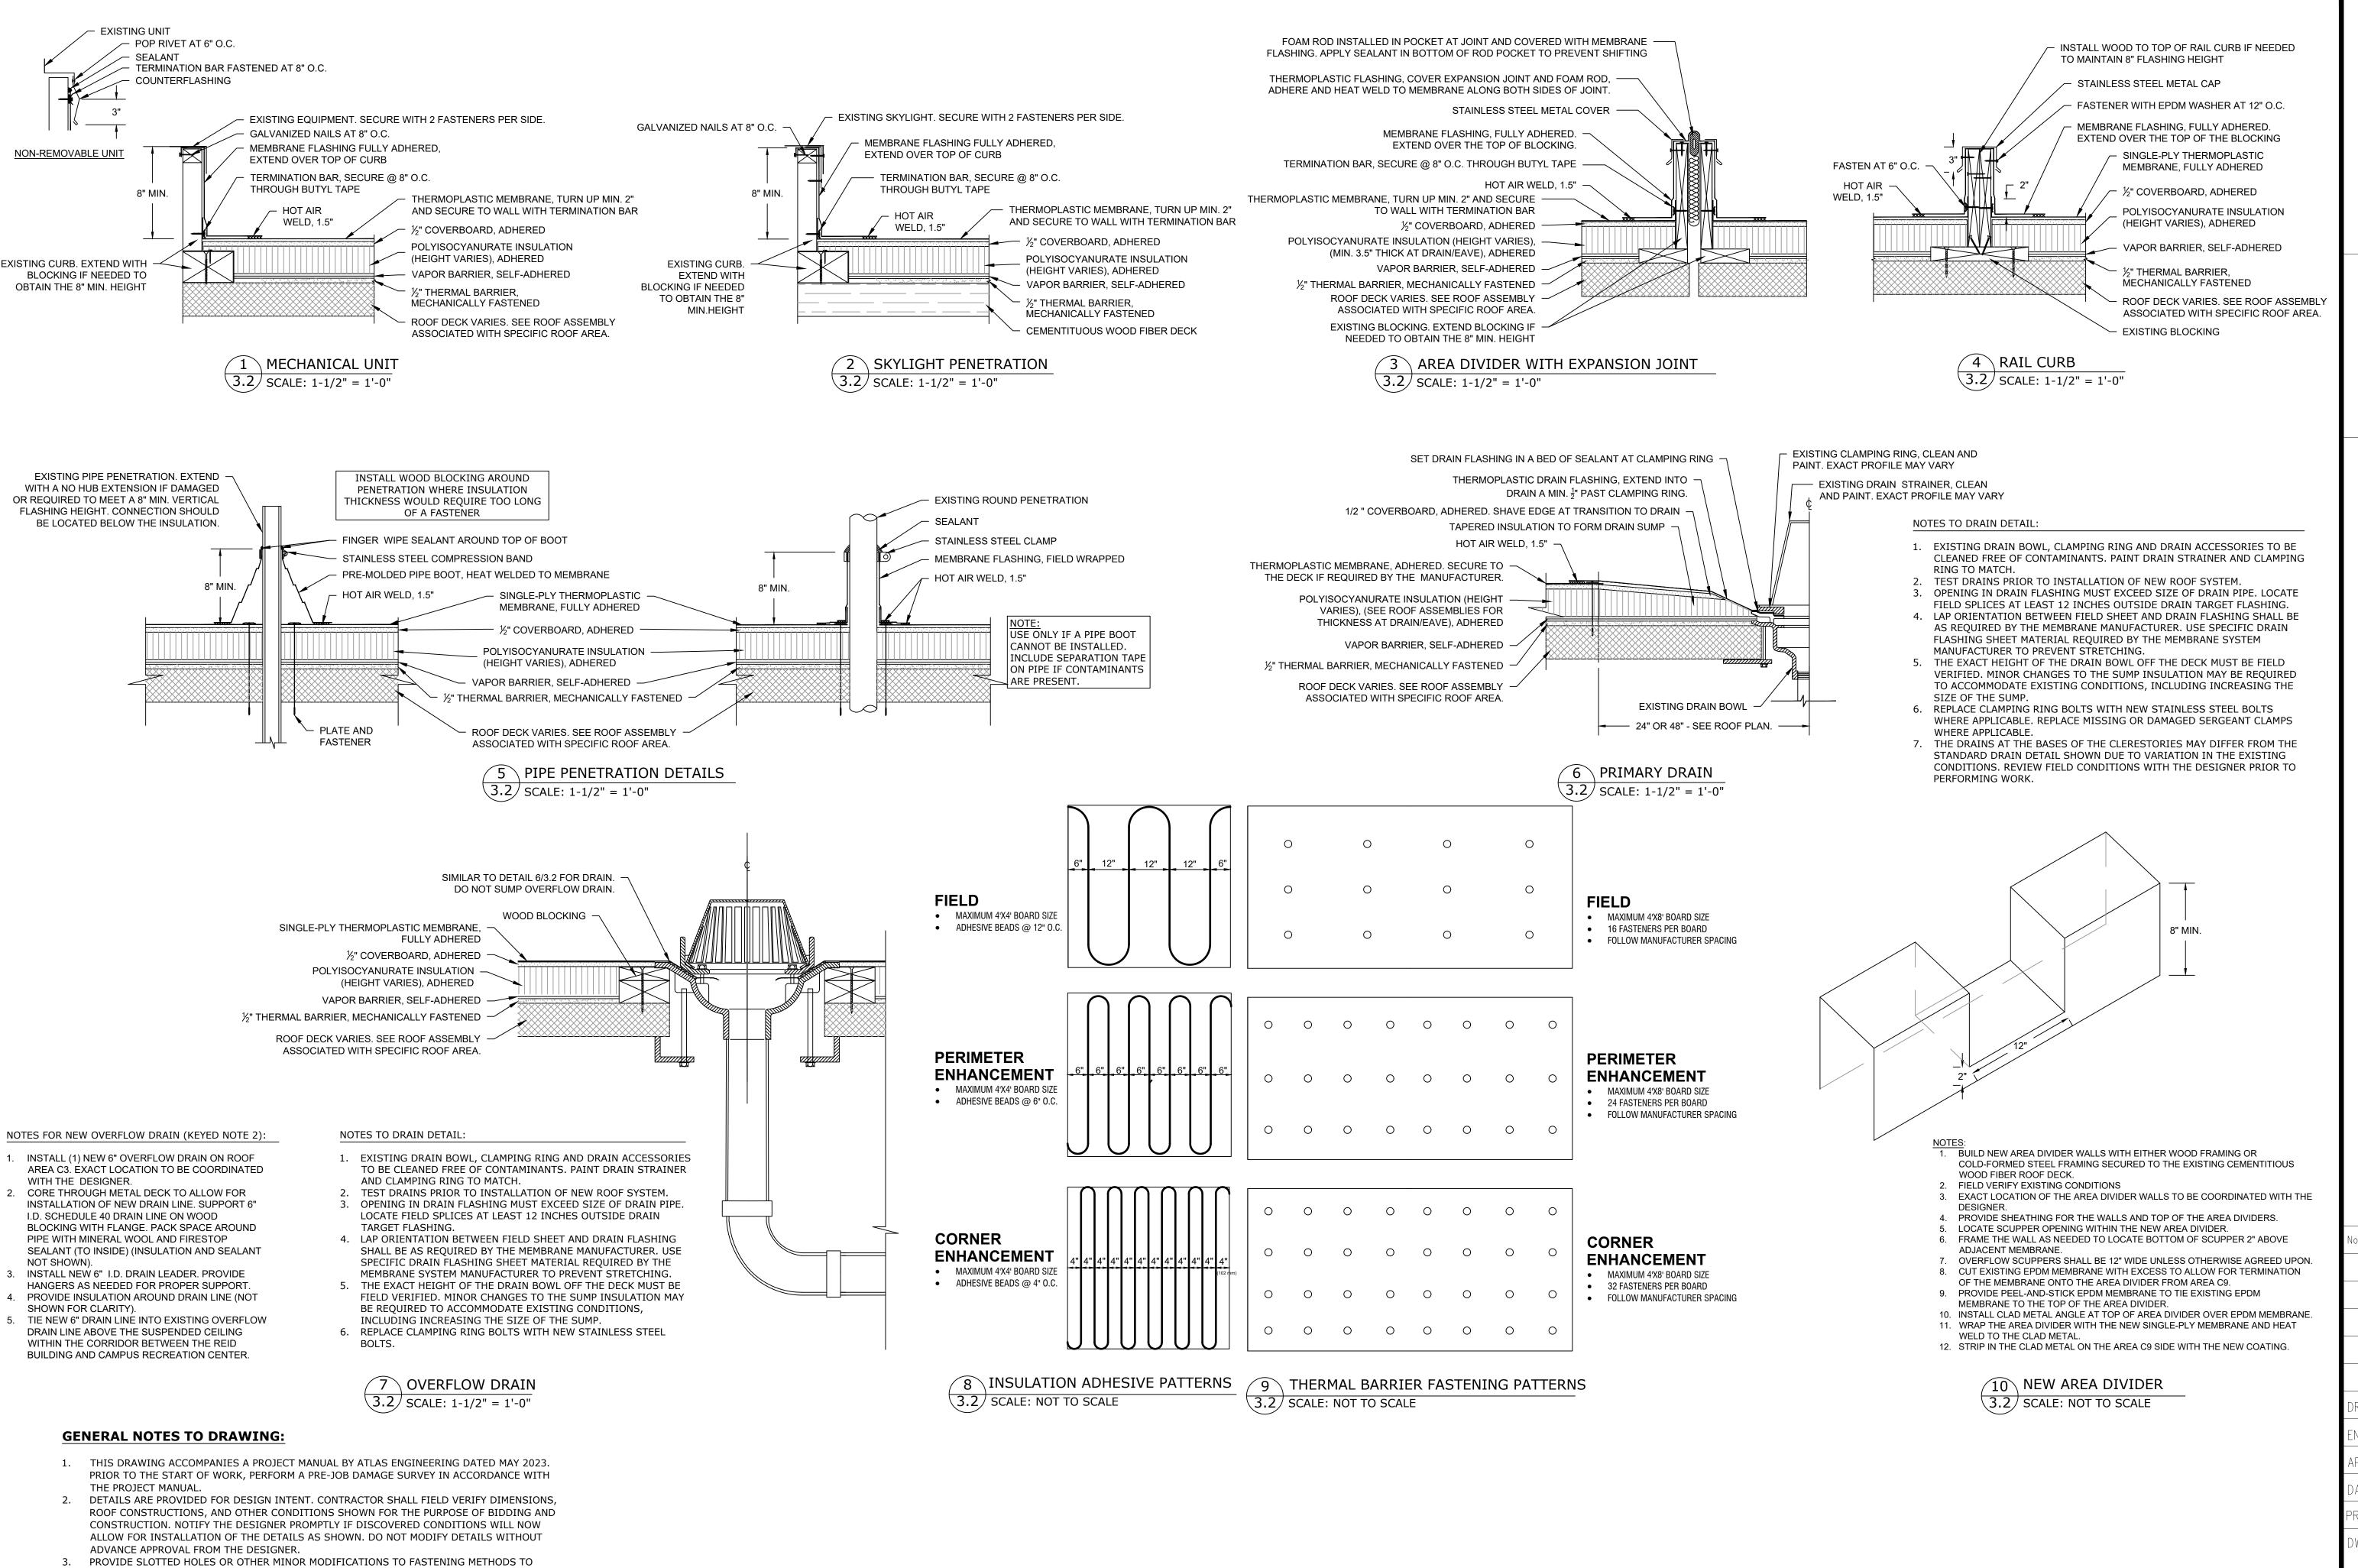

PREVENT OIL CANNING IN VISIBLE FASCIA/EDGE METAL INSTALLATIONS.

4. SYSTEM COMPONENTS SHALL BE NEW UNLESS SPECIFICALLY NOTED TO BE EXISTING IN THE

BID DOCUMENTS

ENGINEERING, INC.
551A Pylon Drive
Raleigh, North Carolina 27606
(919) 420-7676



## VAHEE, NC

CONSTRUCTION DETAILS

REID BUILDING - ROOF REPLACEMENT

WESTERN CAROLINA UNIVERSITY, CULLOWHEE, N

SCO ID#: 22-24547-01A

No. REVISION By Date

DRAWN BY: HMF


ENGINEER: HMF

APPROVAL: KEW

DATE: MAY 2023

PROJ.: J2626 SCALE: AS SHOW

DWG. NO.

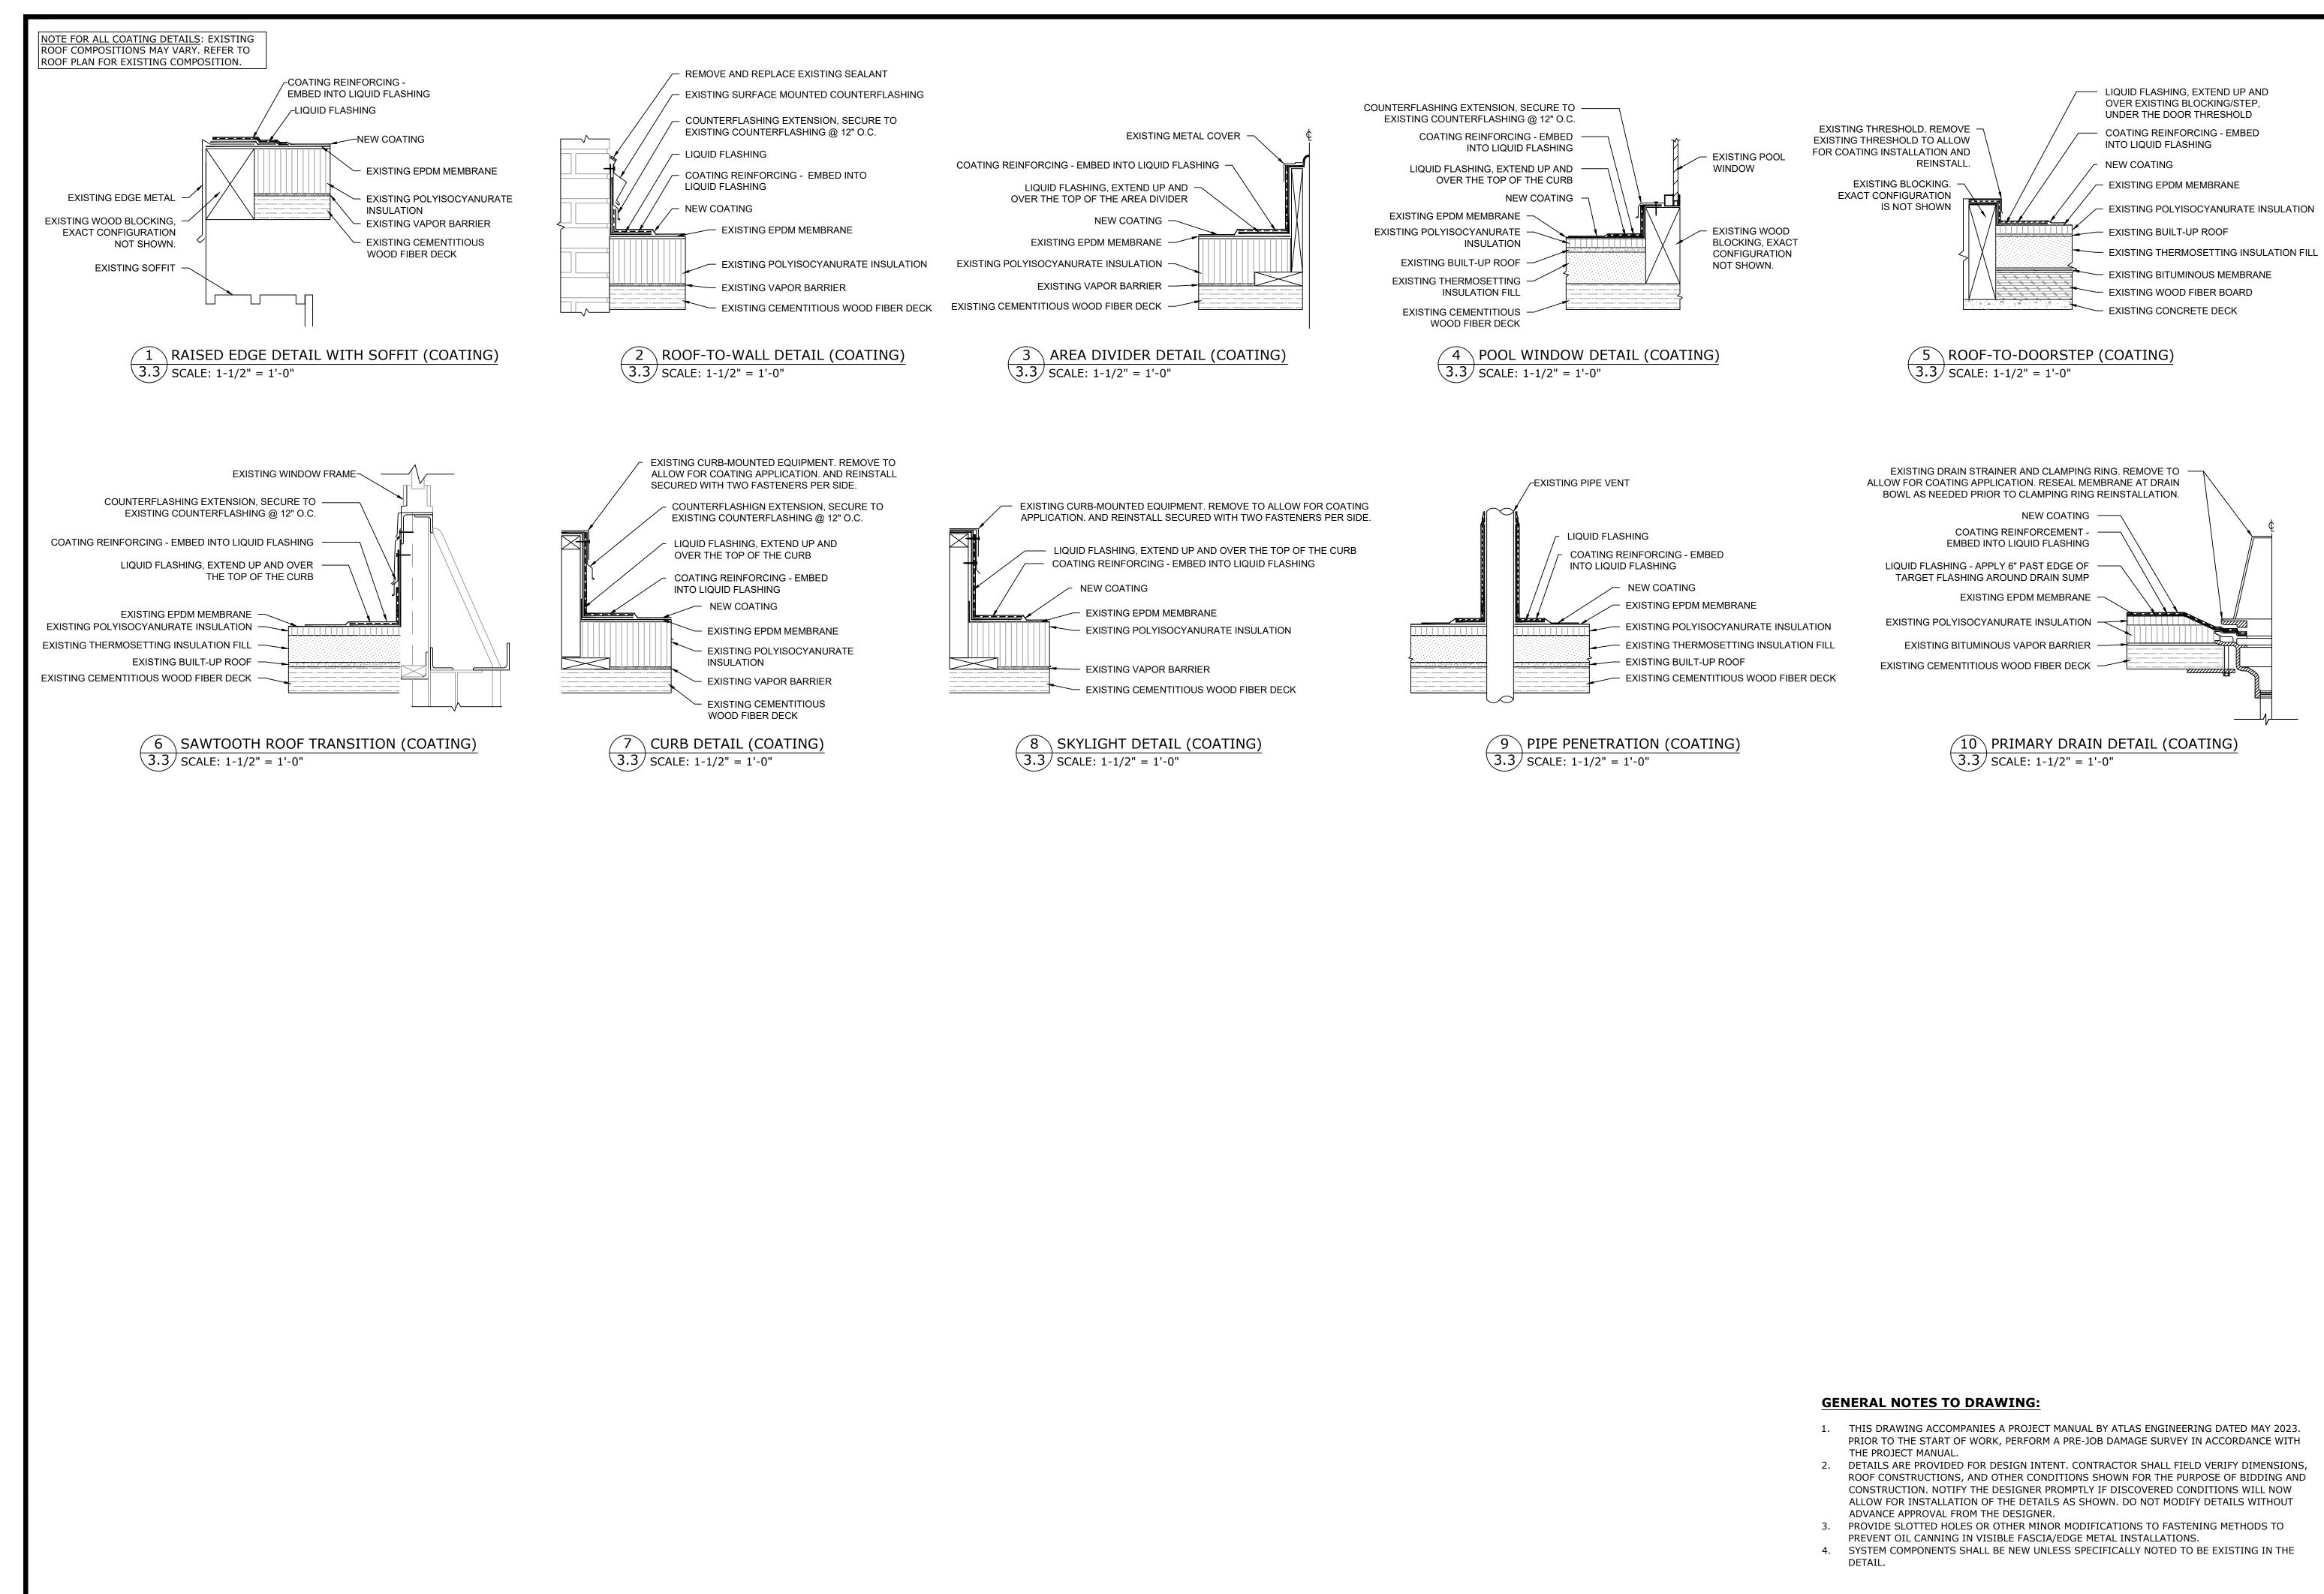

BID DOCUMENTS




## MENT RE BUILDING -AROLINA UN

REVISION DRAWN BY: HMF ENGINEER: HMF approval: KEW

DATE: MAY 2023

PROJ.: J2626 SCALE: AS SHOW DWG. NO.

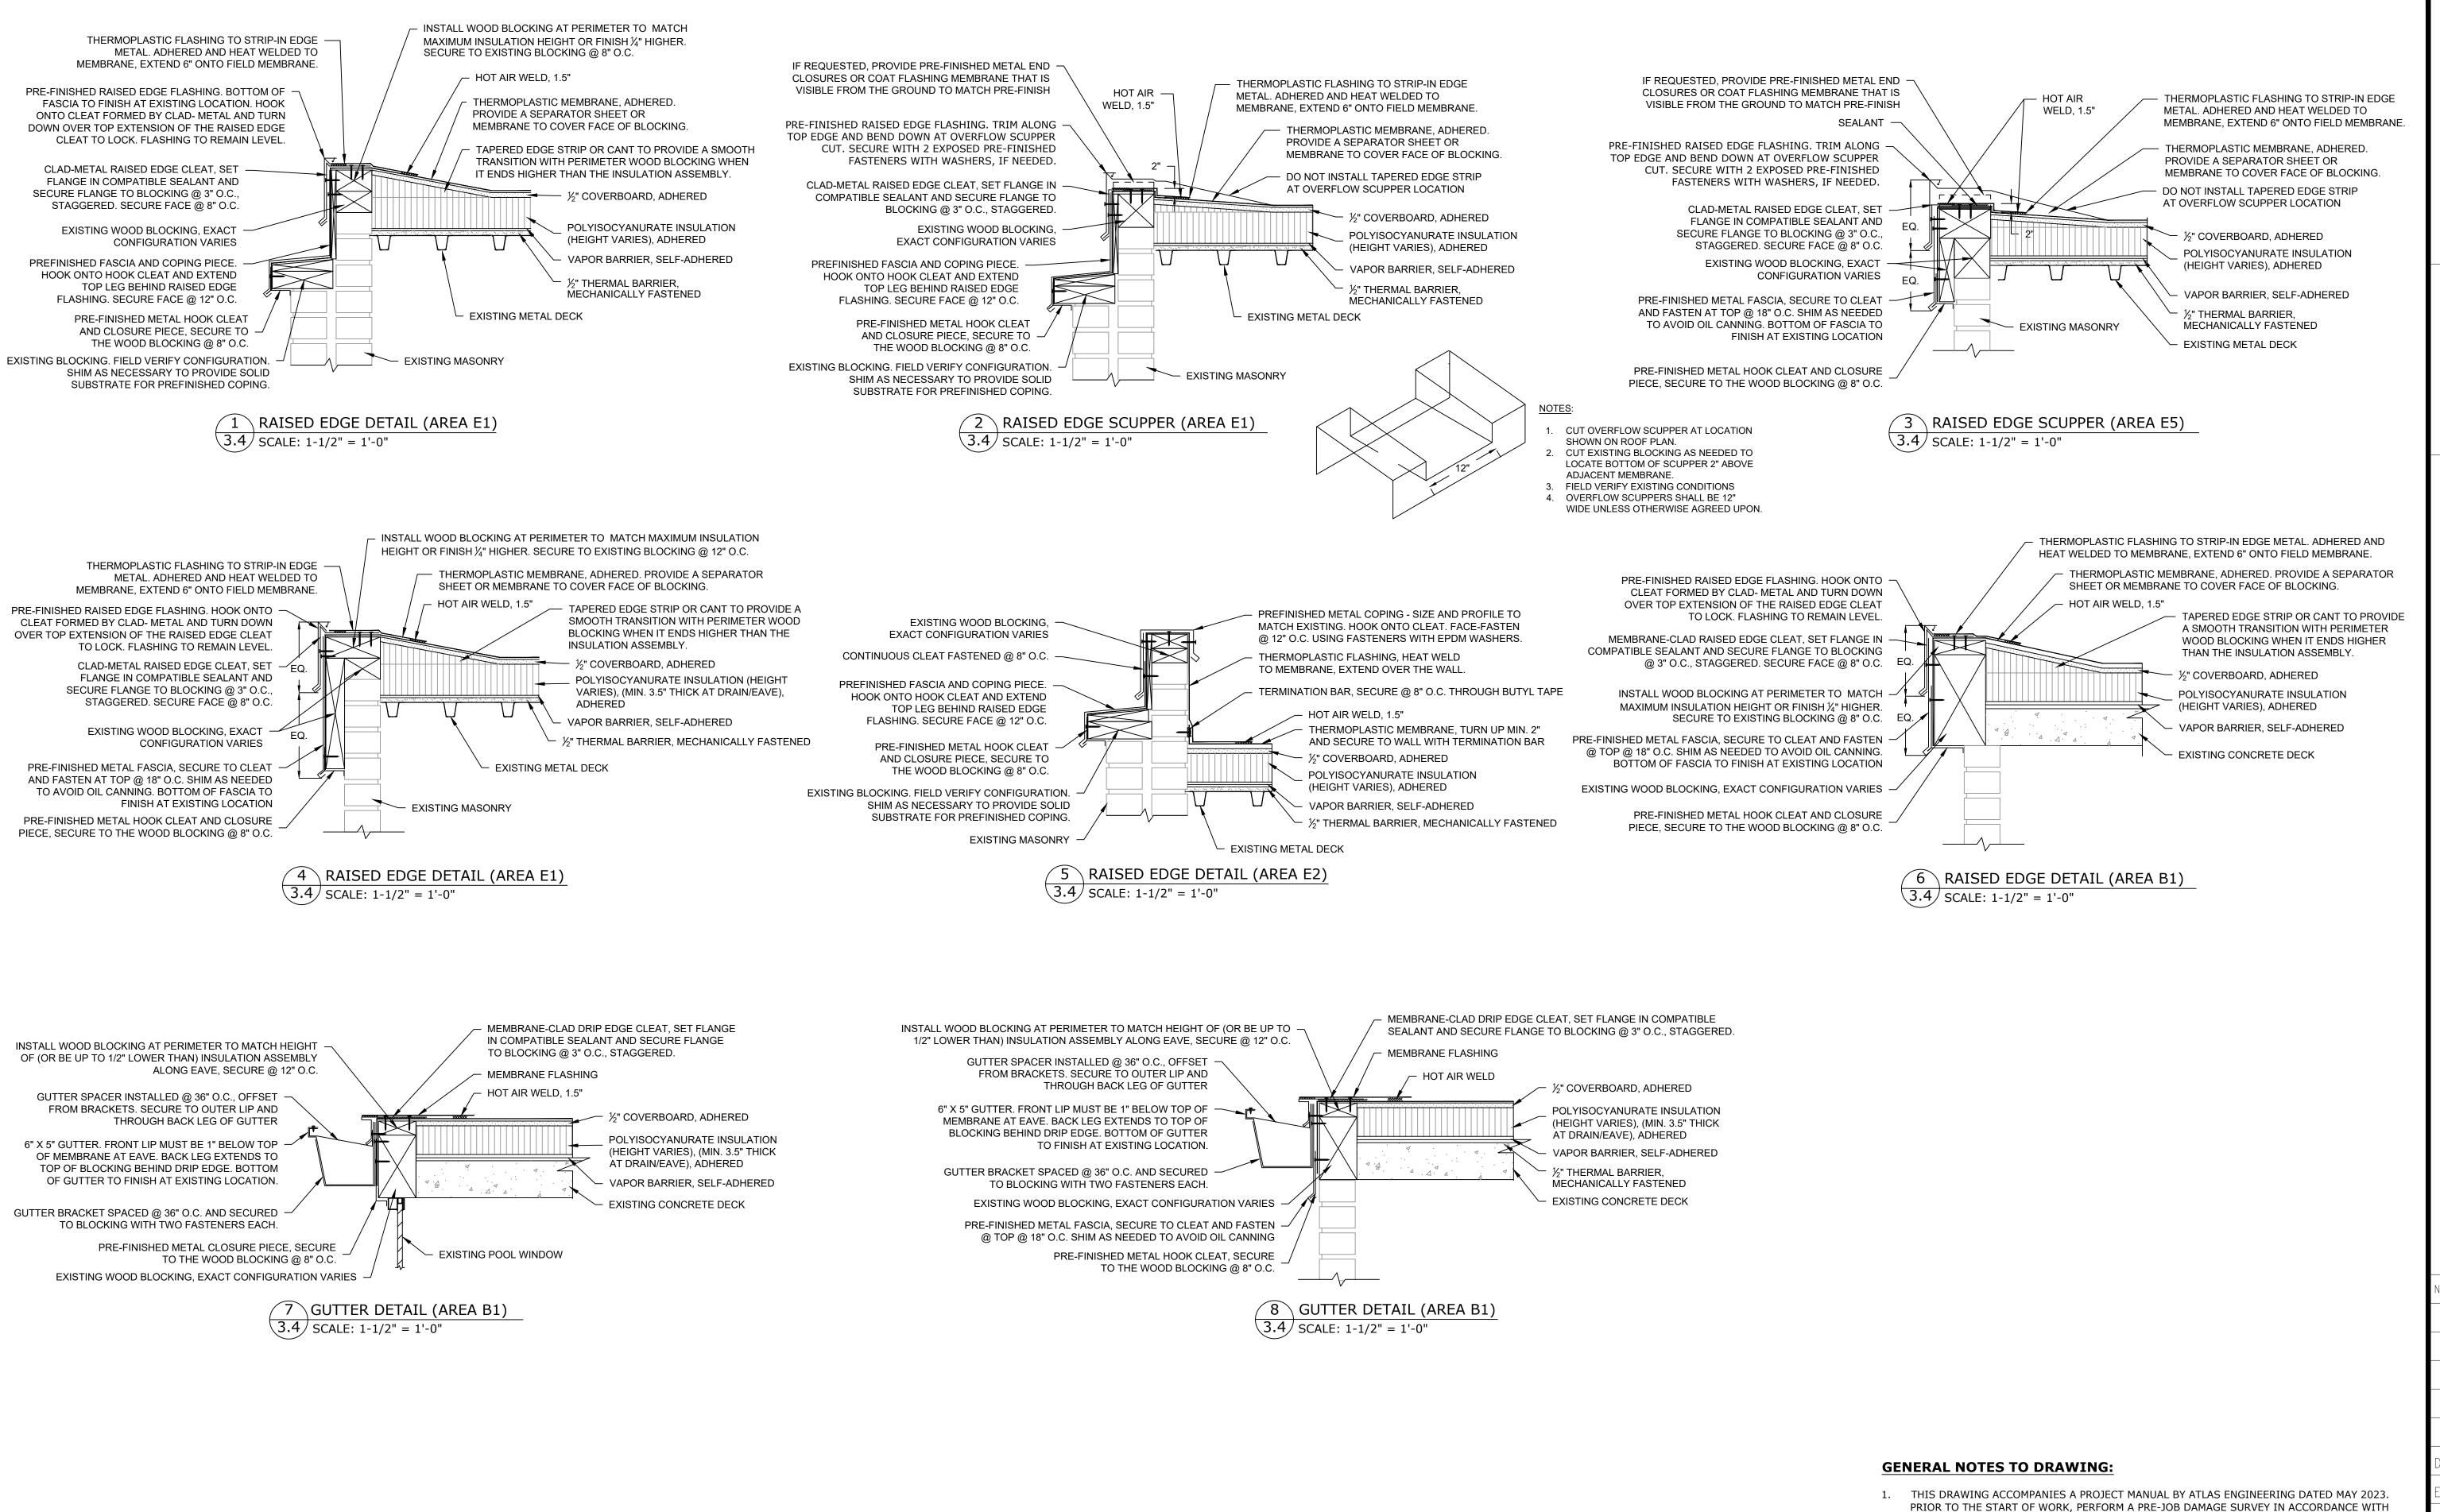

BID DOCUMENTS

2. DETAILS ARE PROVIDED FOR DESIGN INTENT. CONTRACTOR SHALL FIELD VERIFY DIMENSIONS

3. PROVIDE SLOTTED HOLES OR OTHER MINOR MODIFICATIONS TO FASTENING METHODS TO

4. SYSTEM COMPONENTS SHALL BE NEW UNLESS SPECIFICALLY NOTED TO BE EXISTING IN THE

PREVENT OIL CANNING IN VISIBLE FASCIA/EDGE METAL INSTALLATIONS.

ROOF CONSTRUCTIONS, AND OTHER CONDITIONS SHOWN FOR THE PURPOSE OF BIDDING AND CONSTRUCTION. NOTIFY THE DESIGNER PROMPTLY IF DISCOVERED CONDITIONS WILL NOW ALLOW FOR INSTALLATION OF THE DETAILS AS SHOWN. DO NOT MODIFY DETAILS WITHOUT

THE PROJECT MANUAL.

DETAIL.

ADVANCE APPROVAL FROM THE DESIGNER.

054361 . ENGINEE

ME

 $\Delta$ 0 2 AROLINA UN SCO ID#: 7 REID 0

REVISION rawn by: HMF ENGINEER: HMF approval: KEW

DATE: MAY 2023 PROJ.: J2626 | SCALE: AS SHOW

DWG. NO.