

N.C. A&T STATE UNIVERSITY

PROCTOR ACADEMIC HALL EXTERIOR FACADE REPAIR PROJECT

STATE PROJECT NO. 23-26581-01A

PROJECT ADDRESS 116 DANIEL STREET GREENSBORO, NC 27401

Abbreviations

General

COVER SHEET APPENDIX B APPENDIX B

Architectural

CLIENT

Project Manager

Mr. Shaban K. Kaji, PE, M ASCE

Office of the University Engineer

Greensboro, North Carolina 27411

ENGINEERING CONSULTANT

TERRACON CONSULTANTS, INC.

7327-G West Friendly Ave.

Greensboro, North Carolina

Stewart S. Swing, EI, RWC, RRC

Senior Project Manager/Facilities

e: stewart.swing@terracon.com

PROJECT CONTACT:

p: 704.594.8905

DeHuguley (Facility) Building

1601 East Market Street

North Carolina Agricultural and Technical University

ROOF PLAN & ELEVATIONS **EXISTING CONDITION PHOTOS**

R-501 **DETAILS** R-502 **DETAILS**

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ISSUE DATE:

08.31.2023

ISSUE FOR:

CONSTRUCTION DOCUMENTS NOT FOR CONSTRUCTION

ADDENDUM:

PROJECT TEAM: DESIGNED BY

SSS DRAWN BY: LJG APR REVIEWER:

CMQ

TERRACON'S PROJECT NUMBER:

FY226137


SHEET TITLE:

COVER SHEET

Terracon G-101

Explore with us

Project Location

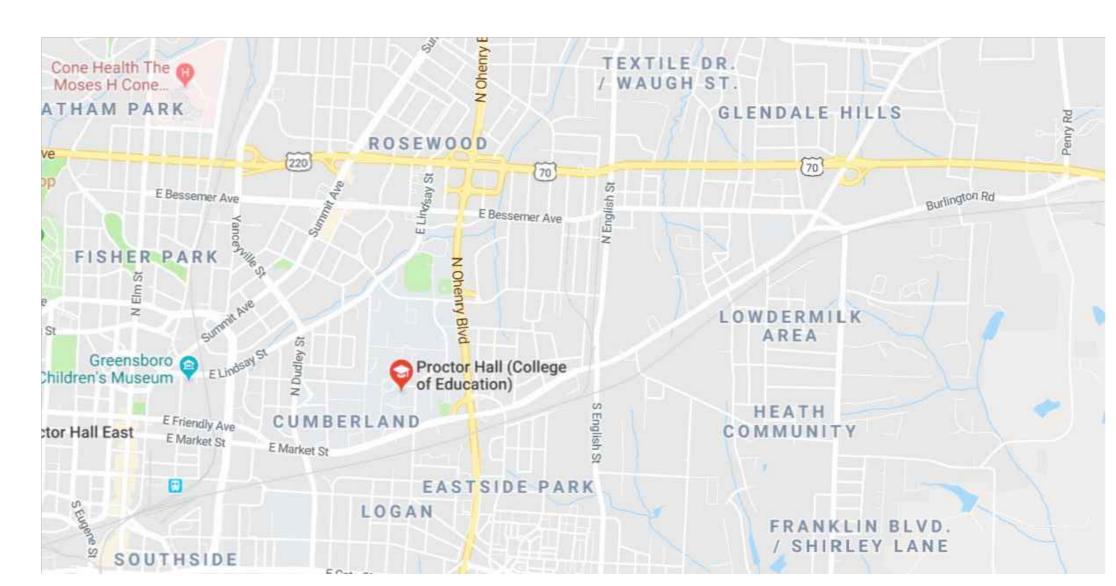

VICINITY MAP




LOCATION MAP

Abbreviations

MAXIMUM MINIMUM **NOT IN CONTRACT ON CENTER**

Details / Elevations / Sections Identifier

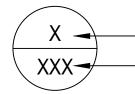

ELEVATION/DETAIL/SECTION LABEL



CONDITIONS AND NOT IN SCOPE OF WORK

SHEET SHOWN ON

SHADING IDENTIFIES EXISTING

2018 APPENDIX B **BUILDING CODE SUMMARY** FOR ALL COMMERCIAL PROJECTS (EXCEPT 1 AND 2-FAMILY DWELLINGS AND TOWNHOUSES) (Reproduce the following data on the building plans sheet 1 or 2)

O WITCH/I TUHIO	Daniel Street, Greensborized Agent: Shaban Ka	•			e <u>274011</u> CAT.edu
Owned By:		City/County	·	rivate	State State
-	ment Jurisdiction: (•		County	
Code Emoree	ment suriscitetion.				
CONTACT:	Christine Quig	ley, PE, RRO	C		
DESIGNER	FIRM	NAME	LICENSE#	TELEPHONE #	E-MAIL
Architectural	Terracon Consultants, I	nc. Christine Quigley	20723	(<u>704</u>) <u>594-8926</u>	Christine.Quigley@terracon.con
Civil				()	
Electrical				()	
Fire Alarm				()	
Plumbing				()	
Mechanical				()	
Sprinkler-Stand				()	
Structural				()	
Other	8 > 3 Trigii <u>N/A</u> N/A			()	
	ld include firms and indivi	duals such as truss.	precast, pre-engir	neered, interior des	igners, etc.)
CON REN	STRUCTED:(date) OVATED: (date) GORY (table 1604.5)	ion: Level I Historic 2005 ORIGIN	Le Property IAL OCCUPA NT OCCUPA I	vel II	
BASIC BUII Construction (check all that	t apply)	ass I II	□ III-A □ III-B PA 13 □ NF □ III ⊠ Wo Flood Hazard	et 🗌 Dry _	V-A V-B PA 13D
Standpipes: Fire District:	\square No \square Yes (Princtions Required: \square N	• /			
-	`	• /		Appendix B	for Building

		Gross Buildi	ng Area:	
FLOOR	EXISTING (SQ FT)	NEW (SQ FT)	RENO/ALTER (SQ.FT)	SUB-TOTAL
6 th Floor	N/A			
5 th Floor	N/A			
4 th Floor	N/A			
3 rd Floor	N/A			
2 nd Floor	N/A			
Mezzanine	N/A			
1 st Floor	N/A			
Basement	N/A			
TOTAL	N/A			
		ALLOWABI	LE AREA	
	ncy Classification:			
• =	\square A-1 \square A-2 \square A	A-3 ∐ A-4 ∐ A-5		
Business				
Educational				
Factory	F-1 Moderate	F-2 Low		
Hazardous [H-1 Detonate] H-3 Combust 🔲 H-4 H	ealth H-5 HPM
Institutional [I-1 Condition	1 2		
Ţ	1-2 Condition	1		
Ţ	1-3 Condition [<u></u> 1 <u></u> 2	\square 3 \square 4 \square 5	
	1-4			
Mercantile [
Residential [☐ R-1 ☐ R-2 ☐ F			
Storage	S-1 Moderate	\square S-2 L	_ 2 1	
	Parking Garage [Open Enclos	sed Repair Garage	
Utility and M	liscellaneous			
Accessory Occupa	ncy Classification(s)	:		
ncidental Uses (T	able 509):			
Special Uses (Chap	oter 4 – List Code Sect	tions)		
Special Provisions	(Chapter 5 – List Coo	de Sections):		
		Yes Separation	n: 2 Hr. Exception:	
•	': ∐ No [
Mixed Occupancy	r:			
Mixed Occupancy Non-Separ The require	ated Use (508.3) ed type of construction	for the building shall b	e determined by applying the	e height and area limitation
Mixed Occupancy Non-Separ The require for each of	ated Use (508.3) ad type of construction the applicable occupa	for the building shall b		e height and area limitation
Mixed Occupancy Non-Separ The require for each of determined	ated Use (508.3) d type of construction the applicable occupa , shall apply to the ent	for the building shall b	e determined by applying the	e height and area limitation
Mixed Occupancy Non-Separ The require for each of determined Separated	ated Use (508.3) and type of construction the applicable occupa , shall apply to the ent Use (508.4) -	for the building shall be noted to the entire build tire building.	e determined by applying the ing. The most restrictive type	e height and area limitation be of construction, so
Mixed Occupancy Non-Separ The require for each of determined Separated See below	ated Use (508.3) and type of construction the applicable occupa , shall apply to the ent Use (508.4) - for area calculations for	for the building shall be noticed to the entire building building.	e determined by applying the	e height and area limitation be of construction, so the that the sum of the

STORY NO.	DESCRIPTION AND USE	(A) BLDG AREA PER STORY (ACTUAL)	(B) TABLE 506.2 ⁴ AREA	(C) AREA FOR FRONTAGE INCREASE ^{1,5}	(D) ALLOWABLE AREA PER STORY OR UNLIMITED ^{2,3}
	N/A				
_	rea increases from Se		•	feet minimum width =	(F)

- a. Perimeter which fronts a public way or open space having 20 feet minimum width = _____(F)
- b. Total Building Perimeter = ____(P)
- c. Ratio $(F/P) = \underline{\hspace{1cm}} (F/P)$
- d. $W = Minimum width of public way = ____ (W)$ e. Percent of frontage increase $I_f = 100 [F/P - 0.25] \times W/30 =$ _____ (%)
- ² Unlimited area applicable under conditions of Section 507.
- ³ Maximum Building Area = total number of stories in the building x D (maximum 3 stories) (506.2).
- ⁴ The maximum area of open parking garages must comply with Table 406.5.4 ⁵ Frontage increase is based on the unsprinklered area value in Table 506.2.

ALLOWABLE HEIGHT

	ALLOWABLE (TABLE 503)	SHOWN ON PLANS	CODE REFERENCE
Building Height in Feet (Table 504.3)	55		
Building Height in Stories (Table 504.4)	4		

Provide code reference if the "Show on Plans" quantity is not based on Table 504.3 or 504.4.

- ² The maximum height of air traffic control towers must comply with Table 412.3.1 ³ The maximum height of open parking garages must comply with Table 406.5.4

2018 NC Administrative Code and Policies

Allowable Area of Occupancy A Allowable Area of Occupancy B

2018 NC Administrative Code and Policies

Appendix B for Building

Appendix B for Building

BUILDING ELEMENT	FIRE SEPARATION	REQ'D	RATING PROVIDED	DETAIL# AND	DESIGN # FOR	DESIGN # FOR RATED	DESIGN # FOR
	DISTANCE (FEET)		(W/* REDUCTION)	SHEET #	RATED ASSEMBLY	PENETRATION	RATED JOINTS
Structural Frame,	N/A						
including columns, girders, trusses							
Bearing Walls	N/A						
Exterior							
North							
East							
West							
South							
Interior							
Nonbearing Walls and Partitions	N/A						
Exterior walls							
North							
East							
West							
South							
Interior walls and partitions							
Floor Construction Including supporting beams and joists	N/A						
Floor Ceiling Assembly	N/A						
Column Supporting Floors	N/A						
Roof Construction, including supporting beams and joists	N/A						
Roof Ceiling Assembly	N/A						
Column Supporting Roof	N/A						
Shaft Enclosures - Exit	N/A						
Shaft Enclosures - Other	N/A						
Corridor Separation	N/A						
Occupancy/Fire Barrier Separation	N/A						
Party/Fire Wall Separation	N/A						
Smoke Barrier Separation	N/A						
Smoke Partition	N/A						
Tenant/Dwelling Unit/ Sleeping Unit Separation	N/A						
Incidental Use Separation	N/A						

* Indicate section number permitting reduction

PERCENTAGE OF WALL OPENING CALCULATIONS

FIRE SEPARATION DISTANCE (FEET FROM PERPERTY LINES	DEGREES OF OPENINGS PROTECTION (TABLE 705.8)	ALLOWABLE AREA (%)	ACTUAL SHOWN ON PLANS (%)
N/A			

2018 NC Administrative Code and Policies Appendix B for Building

LIFE SAFETY SYSTEM REQUIREMENTS

Appendix B for Building

Emergency Lighting:	☐ No ☐ Yes
Exit Signs:	☐ No ☐ Yes
Fire Alarm:	☐ No ☐ Yes
Smoke Detection Systems:	☐ No ☐ Yes ☐ Partial
Carbon Monoxide Detection:	☐ No ☐ Yes

LIFE SAFETY PLAN REQUIREMENTS

Life Safety Plan Sheet #: N/A
Fire and/or smoke rated wall locations (Chapter 7)
Assumed and real property line locations (if not on the site plan)
Exterior wall opening area with respect to distance to assumed property lines (705.8)
Occupancy types for each area as it relates to occupant load calculation (Table 1004.1.2)
Occupant loads for each area
Exit access travel distances (1017)
Common path of travel distances (1006.2.1 & 2006.3.2(1))
Dead end lengths (1020.4)

- Clear exit widths for each exit door Maximum calculated occupant load capacity each exit door can accommodate based on egress width (1005.3)
- Actual occupant load for each exit door A separate schematic plan indicating where fire rated floor/ceiling and/or roof structure is provided for purposes of occupancy separation and supporting construction for a fire barrier/fire partition/smoke barrier.
- Location of doors with panic hardware (1010.1.10) Location of doors with delayed egress locks and the amount of delay (1010.1.9.7)
- Location of doors with electromagnetic egress locks (1010.1.9.9) Location of doors equipped with hold-open devices
- Location of emergency escape windows (1030) ☐ The square footage of each fire area (202)
- The square footage of each smoke compartment for Occupancy Classification I-2 (407.5)
- Note any code exceptions or table notes that may have been utilized regarding the items above

Section/Table/Note	Title

ACCESSIBLE DWELLING UNITS (SECTION 1107)

TOTAL	Accessible	Accessible	Түре А	Түре А	Түре В	Түре В	TOTAL
Units	Units	Units	Units	Units	Units	Units	ACCESSIBLE UNITS
	Required	Provided	Required	Provided	Required	Provided	PROVIDED

2018 NC Administrative Code and Policies Appendix B for Building

ACCESSIBLE PARKING (SECTION 1106)

LOT OR PARKING	TOTAL# OF PA	ARKING SPACES	# OF AC	CESSIBLE SPACES PRO	OVIDED	TOTAL#
AREA	REQUIRED PROVIDED REGULAR WITH VAN SPACES WITH		ACCESSIBLE			
			5' ACCESS	132" ACCESS	8' ACCESS	PROVIDED
			AISLE	AISLE	AISLE	
N/A						
TOTAL						

PLUMBING FIXTURE REQUIREMENTS (TABLE 2902.1)

(1ABLE 2902.1)	

USE		WATERCLOSETS			URINALS	LAVATORIES			SHOWERS	DRINKING FOUNTAINS	
		MALE	FEMALE	UNISEX		MALE	FEMALE	UNISEX	/ TUBS	REGULAR	ACCESSIBLE
SPACE	EXIST'G										
	NEW										
	REQ'D										

SPECIAL APPROVALS

Special approval: (Local Jurisdiction, Department of Insurance, SCO, DPI, DHHS, ICC, etc., describe below)

2018 NC Administrative Code and Policies



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HALL EXTERIOR R PROJECT N.C. A&T STATE UNIVERSITY

PROCTOR ACADEMIC FACADE REPAIR

ISSUE DATE:

08.31.2023

ISSUE FOR:

CONSTRUCTION DOCUMENTS NOT FOR CONSTRUCTION

ADDENDUM: No.: DATE: DESCRIPTION:

PROJECT TEAM: DESIGNED BY:

DRAWN BY:

APR REVIEWER:

CMQ

TERRACON'S PROJECT NUMBER:

FY226137

SHEET TITLE:

APPENDIX B

ENERGY SUMMARY
ENERGY REQUIREMENTS: The following data shall be considered minimum and any special attribute required to meet the North Carolina Energy Conservation Code shall also be provided. Each Designer shall furnish the required portions of the project information for the plan data sheet. If performance method, state the annual energy cost for the standard reference design vs annual energy cost for the proposed design.
Existing building envelope complies with code: No Yes (The remainder of this section is not applicable)
Exempt Building: No Yes (Provide Code or Statutory reference):
Climate Zone: 3A 4A 5A
Method of Compliance: Energy Code Performance Prescriptive ASHRAE 90.1 Performance Prescriptive (If "Other" specify source here)
THERMAL ENVELOPE (Prescriptive method only)
Roof/ceiling Assembly (each assembly) Description of assembly:
Floors over unconditioned space (each assembly) Description of assembly: U-Value of total assembly: R-Value of insulation:
Floors slab on grade Description of assembly: U-Value of total assembly: R-Value of insulation: Horizontal/Vertical requirement:

(PROV	DE SUMMARY FOR ALL COMMERCIAL PROJECTS STRUCTURAL DESIGN VIDE ON THE STRUCTURAL SHEETS IF APPLICABLE)
DESIGN LOADS:	
Importance Factors:	$\begin{array}{cccccccccccccccccccccccccccccccccccc$
Live Loads:	Roof Mezzanine Floor Psf psf psf psf
Ground Snow Load:	psf
	Ultimate Wind Speed mph (ASCE-7) Exposure Category
Provide the following Seismic De Occupancy Category (Spectral Response Acc Site Classification (AS	(Table 1604.5)
Basic structural system Analysis Procedure: Architectural, Mechan LATERAL DESIGN CONTRO SOIL BEARING CAPACITIE	Bearing Wall Building Frame Dual w/Special Moment Frame Dual w/Intermediate R/C or Special Steel Inverted Pendulum Equivalent Lateral Force Dynamic Simplified Yes No OL: Earthquake Wind Simplified Wind CS:
Basic structural system Analysis Procedure: Architectural, Mechan LATERAL DESIGN CONTRO SOIL BEARING CAPACITIE Field Test (provide copy	Bearing Wall Building Frame Moment Frame Simplified Dual w/Special Moment Frame Inverted Pendulum Equivalent Lateral Force Dynamic Nical, Components anchored? Wind S: y of test report) pacity psf

2018 NC Administrative Code and Policies

Appendix B for Building

MECHANICAI	L SUMMARY
CHANICAL SYSTEMS, SERVICE SYSTEMS AND E	QUIPMENT
Thermal Zone	
winter dry bulb:	
summer dry bulb:	
Interior design conditions	
winter dry bulb:	/ -
summer dry bulb:	IN / AI
relative humidity:	11/21
Building heating load:	
Building cooling load:	
Mechanical Spacing Conditioning System	
Unitary	
description of unit:	
heating efficiency:	
cooling efficiency:	
size category of unit:	
Boiler	
Size category. If oversized, state reason.:	
Chiller	
Size category. If oversized, state reason.:	
List equipment efficiencies:	

2018 APPENDIX B
BUILDING CODE SUMMARY FOR ALL COMMERCIAL PROJECTS

ELECTRICAL DESIGN
(PROVIDE ON THE ELECTRICAL SHEETS IF APPLICABLE)

ELECTRICAL SUMMARY

ELECTRICAL SYSTEM AND EQUIPMENT

Method of Compliance: Energy Code: Prescriptive Performance

ASHRAE 90.1: Prescriptive Performance

Lighting schedule (each fixture type)

lamp type required in fixture
number of lamps in fixture
ballast type used in the fixture
number of ballasts in fixture
total wattage per fixture
total interior wattage specified vs. allowed (whole building or space by space)
total exterior wattage specified vs. allowed

Slab Heated:

2018 NC Administrative Code and Policies

N/A

Appendix B for Building

☐ C406.2 More Efficient Mechanical Equipment
☐ C406.3 Reduced Lighting Power Density
☐ C406.4 Enhanced Digital Lighting Controls
☐ C406.5 On-Site Renewable Energy
☐ C406.6 Dedicated Outdoor Air System
☐ C406.7 Reduced Energy Use in Service Water Heating

2018 NC Administrative Code and Policies

Appendix B for Building

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Appendix B for Building

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PROCTOR ACADEMIC HALL EXTERIOR
FACADE REPAIR PROJECT

FACADE REPAIR PR STATE PROJECT NO. 23-265

ISSUE DATE:

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NOT FOR CONSTRUCTION

ADDENDUM:

No.: DATE: DESCRIPTION:

PROJECT TEAM:
DESIGNED BY:

SSS DRAWN BY: LJG

APR REVIEWER:

TERRACON'S PROJECT NUMBER:


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SHEET TITLE:

SHEET NUMBER:

APPENDIX B

G-103

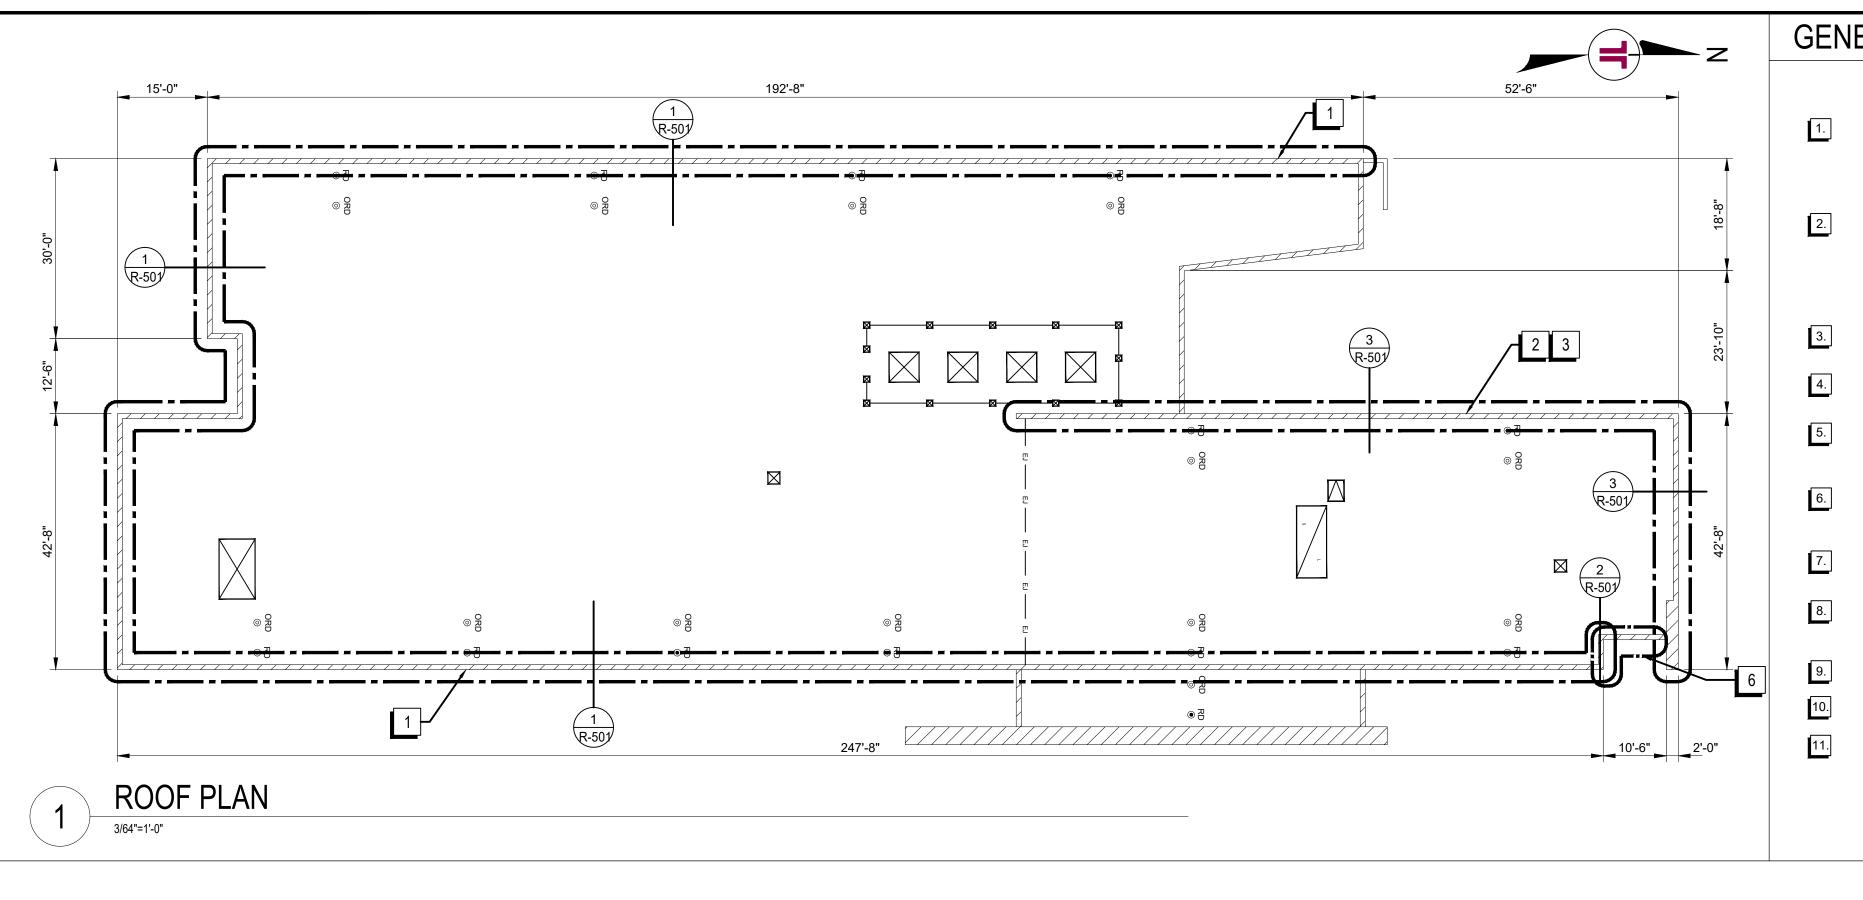

GENERAL REPAIR PROCEDURES

REMOVE EXISTING LIGHTNING PROTECTION FROM COPING CAP AND STORE FOR RE-INSTALLATION. INSTALL NEW WOOD BLOCKING AND PLYWOOD OVER EXISTING METAL COPING AT AREAS DESIGNATED ON DRAWINGS. NEW HIGH TEMPERATURE SELF-ADHERING MEMBRANE SHOULD BE APPLIED OVER THE NEW WOOD BLOCKING AND PLYWOOD SHEATHING. NEW 22-GAUGE CONTINUOUS CLEATS AND 24-GAUGE COPING DRIVE CLEAT COPING CAP IS TO BE INSTALLED. COPING CAP MUST EXTEND DOWN THE FACE OF THE EXISTING WALL CLADDING SYSTEM A MINIMUM OF 1-1/2". REFER TO DETAIL 1/R-501 ONCE LIGHTNING PROTECTION HAS BEEN INSTALLED. LPI-CERTIFIED PERSONNEL SHOULD RE-INSPECT AND RE-CERTIFY LIGHTNING PROTECTION.

REMOVE THE EXISTING BASE FLASHING, 24 INCHES OF EXISTING ROOFING MEMBRANE AND THE EXISTING COPING CAP ALONG HIGH PARAPET WALL AND DISCARD. LIGHTNING PROTECTION ALONG THE COPING CAP SHOULD BE REMOVED AND STORED FOR RE-INSTALLATION. INSTALLATION OF NEW BASE FLASHINGS AND ROOFING MEMBRANE SHOULD BE INSTALLED ALONG THE HIGH PARAPET WALL. WALL FLASHING SHOULD BE SPLIT INTO TWO EQUAL SECTION TO HELP PREVENT SAGGING. INSTALL NEW HIGH TEMP SELF-ADHERING MEMBRANE OVER EXISTING WOOD BLOCKING AND NEW 24-GAUGE COPING CAP WITH DRIVE CLEAT AND 22-GAUGE CONTINUOUS CLEATS. REFER TO DETAIL 2/R-501AND 3/R-501. ROOFING AND PARAPET WALL FLASHING MATERIAL AND INSTALLATION METHODS, MUST BE CONDUCTED PER THE MANUFACTURER. ROOFING IS STILL UNDER WARRANTY. CONTRACTOR MUST BE AN APPROVED ROOF APPLICATOR OF THE EXISTING ROOF SYSTEM TO CONDUCT REMEDIAL REPAIR.

INSTALL NEW BACKER ROD, SILICONE SEALANT AND PREFABRICATED SILICONE STRIP AT COPING TO ALUMINUM HEADER TRANSITION AT HIGH PARAPET WALL. REFER TO DETAIL

REMOVE EXISTING SEALANT AT CLERESTORY STOREFRONT WINDOWS ALONG WEST AND SOUTH ELEVATION AND DISCARD. INSTALL NEW BACKER ROD AND SILICONE SEALANT.

INSTALL NEW SLIP FLASHING AT EXISTING METAL FLASHING AT STOREFRONT WINDOWS ALONG THE WEST ELEVATION. SLIP FLASHING SHOULD BE INSTALLED WITH POP RIVETS AND EXTEND DOWN THE FACE OF THE METAL PANELS A MINIMUM OF 1-1/2". FLASHING SHOULD BE INSTALLED IN A MANNER TO PROMOTE POSITIVE DRAINAGE. REFER TO DETAIL 5/18-501

REMOVE WALL CLADDING PANELS ADJACENT TO CURTAINWALL SYSTEM ON THE EAST ELEVATION TO REVEAL CURTAIN WALL PERIMETER JOINT. CUT BACK EXPOSED FOAM SPRAYED INSULATION APPLIED IN THE JOINT. CLEAN AND PREP SUBSTRATES TO RECEIVE NEW BACKER ROD AND SEALANT. ONCE SEALANT HAS CURED, REINSTALL EXTERIOR WALL CLADDING PANELS. REFER TO PHOTOS 1 AND 2 ON R-201 FOR REFERENCE.


REMOVE WALL CLADDING PANELS, INSULATION AND METAL FRAMING (AS REQUIRED) ADJACENT TO BALCONIES AS INDICATED ON DRAWINGS. REPAIR ALL DAMAGED WATERPROOFING UTILIZING SELF-ADHERING MEMBRANE AND LIQUID MASTIC. SEE PHOTOGRAPH 3 AND 4 FOR REFERENCE.


REMOVE WALL CLADDING PANELS, METAL FRAMING (AS REQUIRED) AND EXISTING INSULATION ALONG THE WEST AND SOUTH ELEVATION ABOVE CLEARSTORY WINDOWS AS INDICATED ON DRAWINGS. REPAIR ALL DAMAGED WATERPROOFING UTILIZING SELF-ADHERING MEMBRANE AND LIQUID MASTIC. METAL LEG OF FLASHING SHOULD BE STRIPPED IN WITH SELF-ADHERING MEMBRANE AND TERMINATED WITH LIQUID MASTIC. SEE DETAIL 1/R-502.


INSTALL NEW SEALANT AND BACKER ROD AT ALL SUNSHADE STEEL CLIPS ON WEST ELEVATION. SEE PHOTOGRAPH 5 FOR REFERENCE.

INSTALL NEW COVE BEAD ALONG BRICK MASONRY FLASHING THAT DOES NOT EXTEND PASS BRICK FACE A CLEARSTORY WINDOW ALONG WEST AND SOUTH ELEVATION.

CAREFULLY RELOCATE ALL LIGHTNING PROTECTION, ELECTRICAL, CO-AXIAL, TELEPHONE, FIBER OPTIC, INTERCOM AND MISCELLANEOUS WIRES, CABLES, ETC. AS REQUIRED TO ACCOMPLISH WORK SPECIFIED HEREIN. ACCOMPLISH SUCH RELOCATION WITHOUT INTERRUPTING THE SERVICE PROVIDED BY THESE LINES EXCEPT AS SPECIFICALLY AUTHORIZED BY THE OWNER. BECOME FAMILIAR WITH EACH LINE AND THE LEVEL OF PRECAUTION NECESSARY TO RELOCATE THEM OR WORK AROUND THEM. UPON COMPLETION OF ROOFING WORK, RELOCATE LINES TO THEIR ORIGINAL POSITIONS AND SECURE THEM AS ORIGINALLY SECURED UNLESS INDICATED OTHERWISE IN THESE SPECIFICATIONS OR ON THE PROJECT DRAWINGS. SEE DETAIL

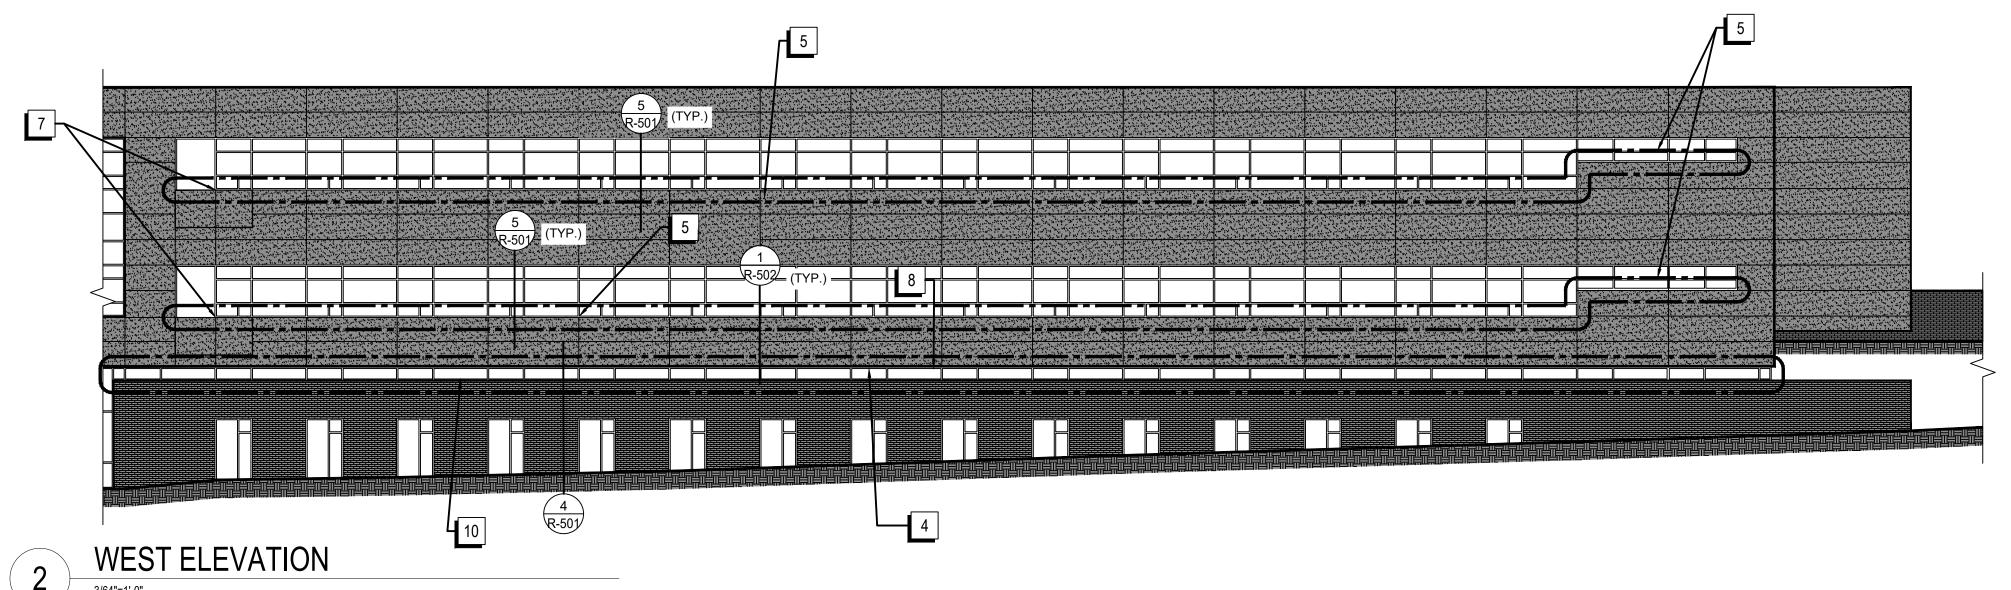

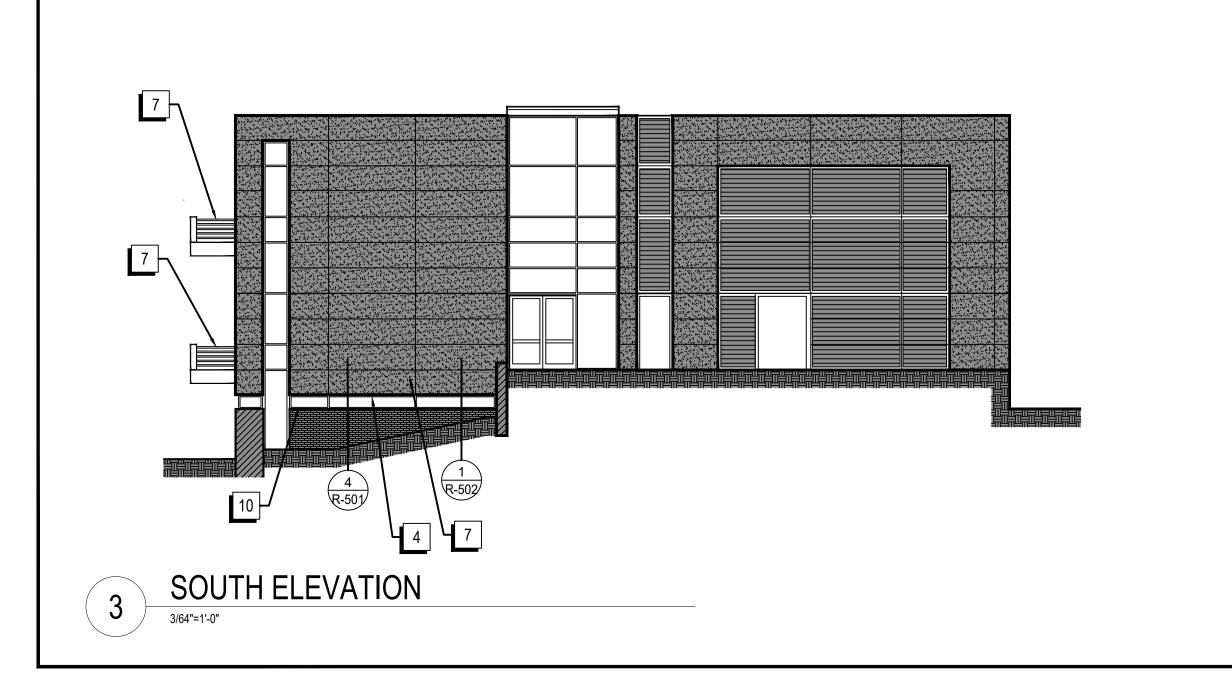

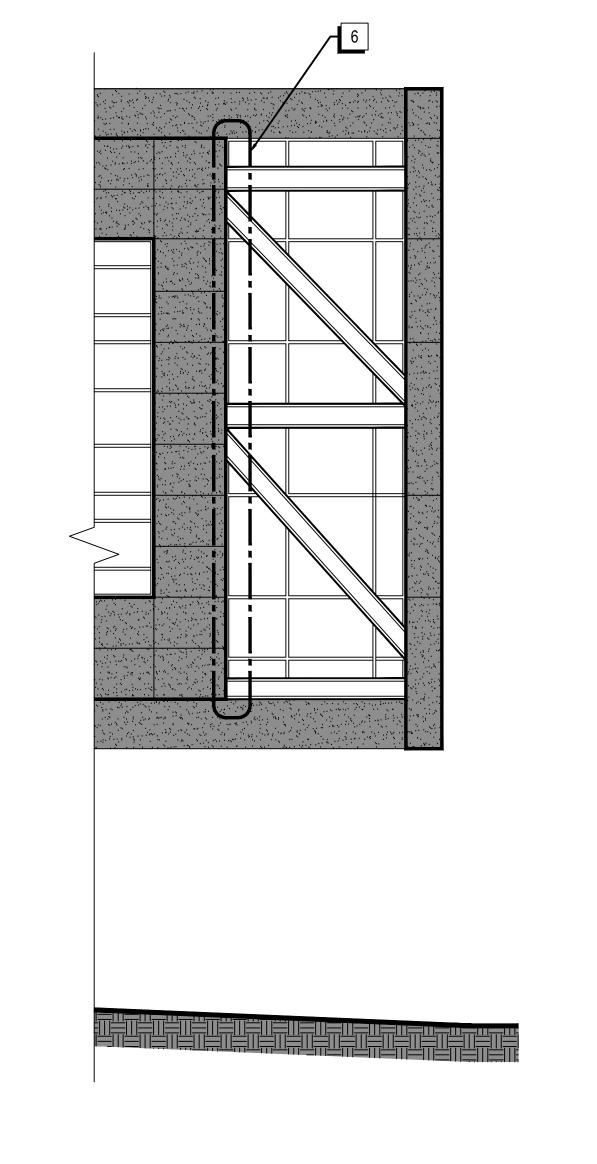





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> Project No. FH196033 Terracon NC License No.: F-0869

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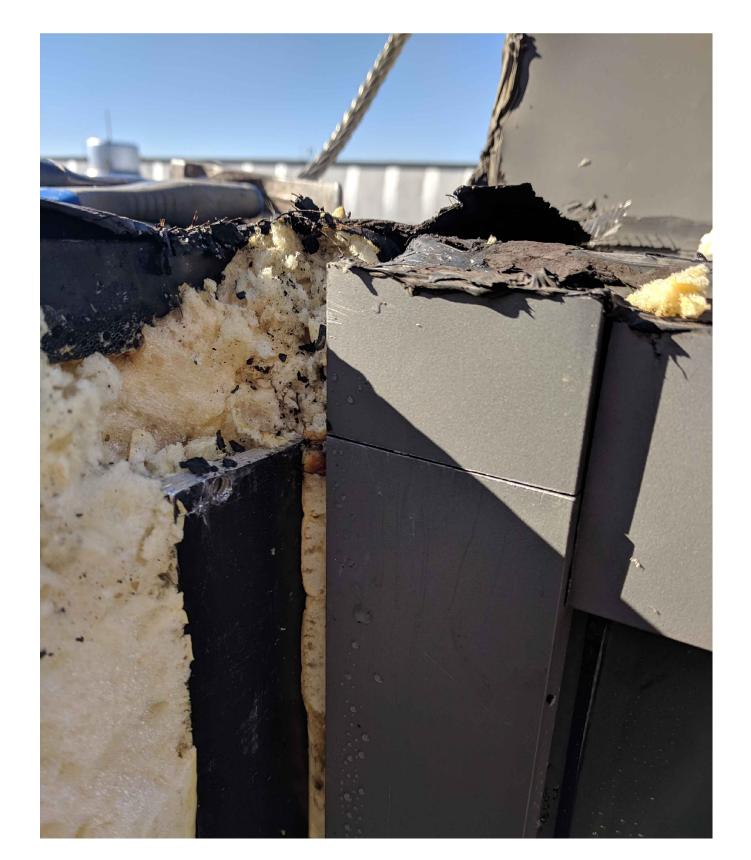
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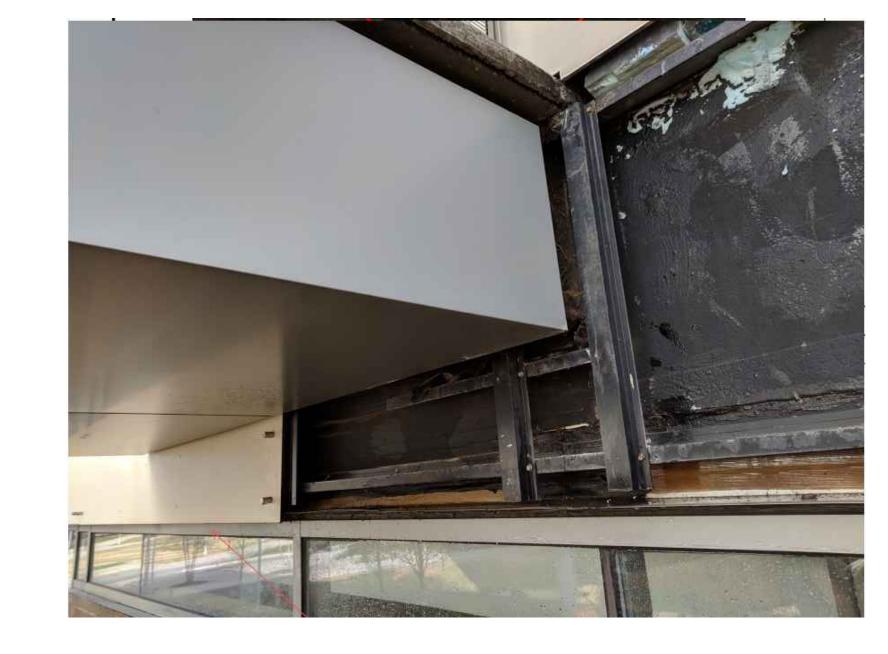
ROOF PLAN & ELEVATIONS

SHEET NUMBER

R-101







9 PHOTO
3/64"=1'-0"

PHOTO
3/64"=1'-0"



9HOTO
3/64"=1'-0"

PHOTO 3/64"=1'-0"

4 PHOTO
3/64"=1'-0"

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EXISTING CONDITIONS

P_201

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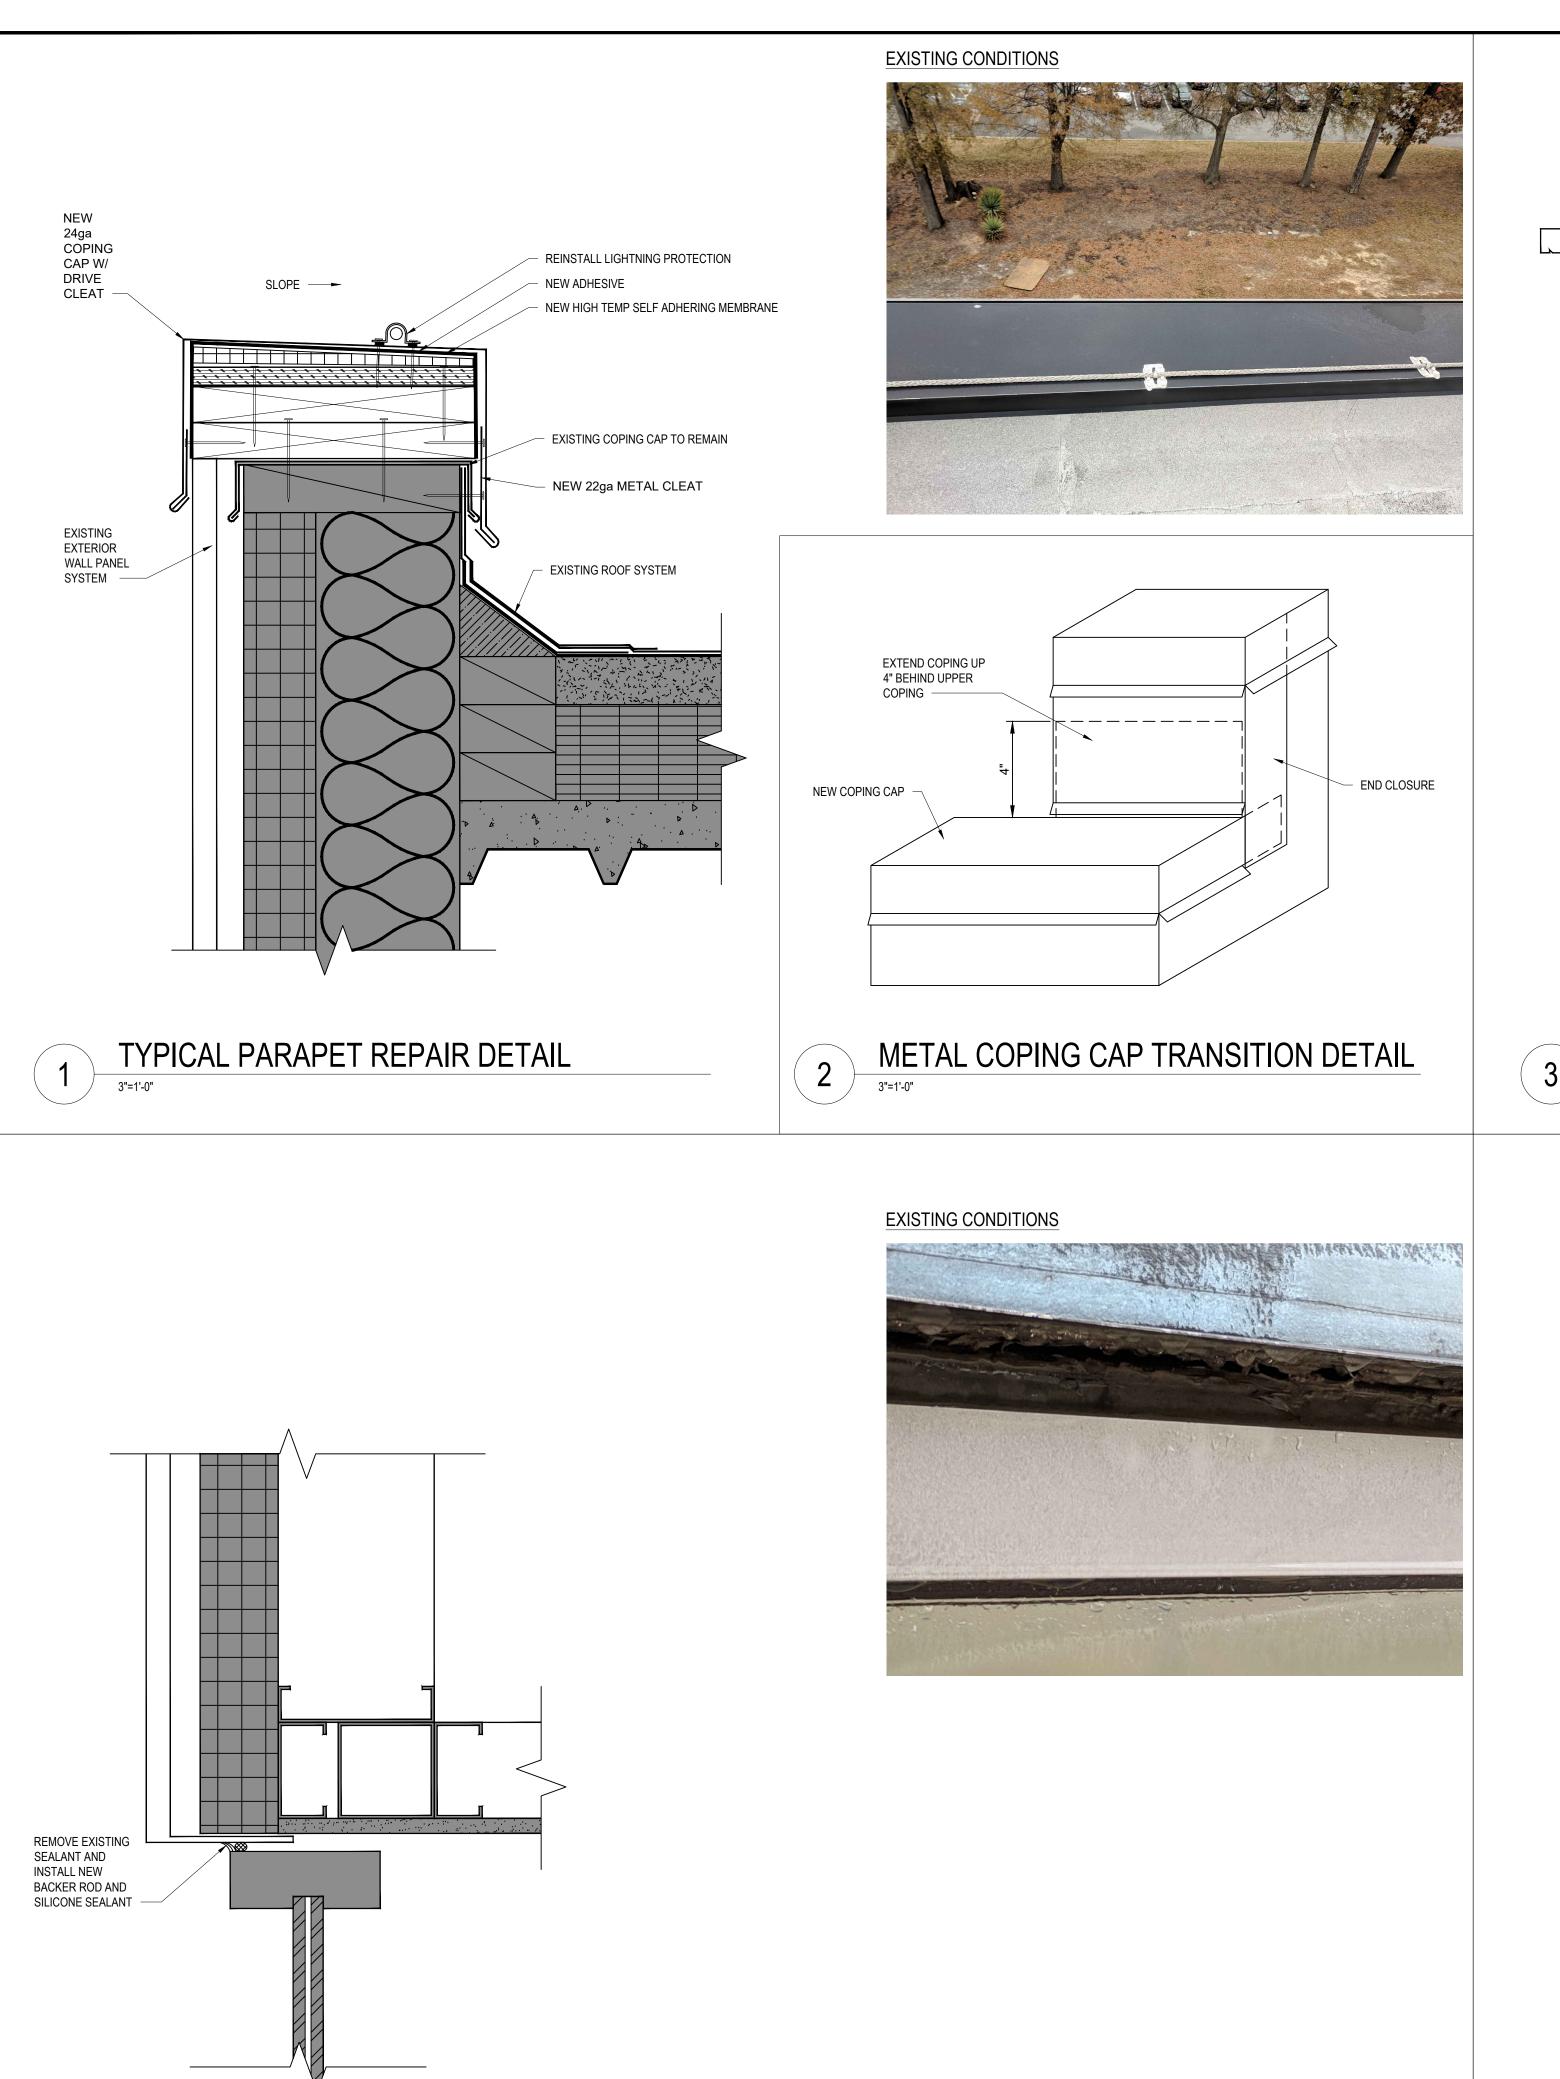
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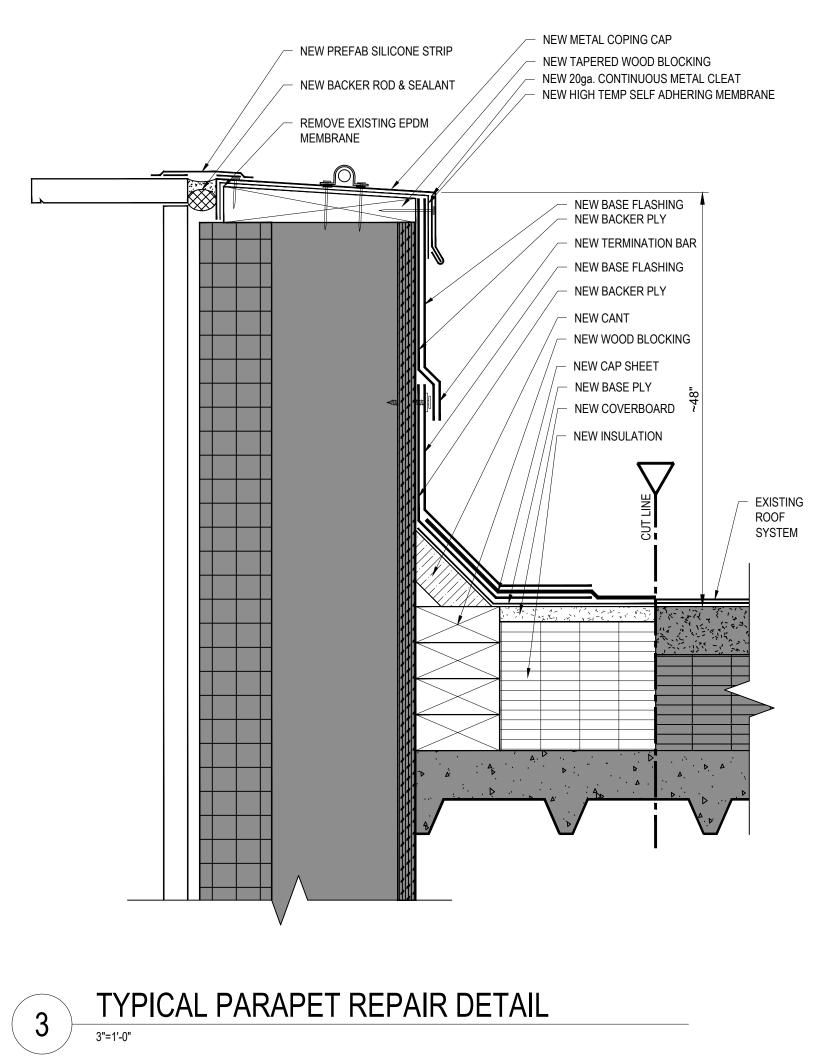
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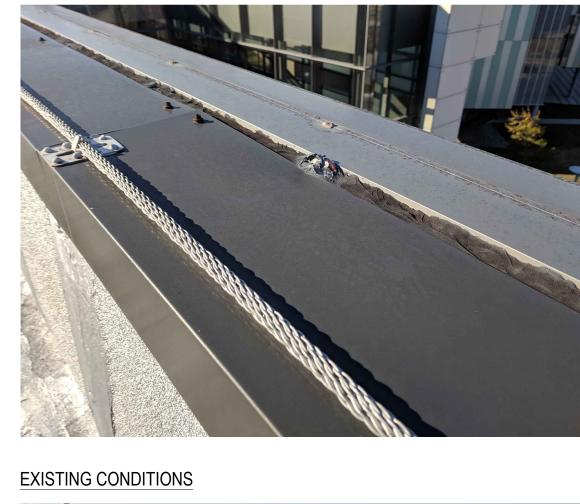
CONSTRUCTION DOCUMENTS
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4 SEALANT REPAIR @ CLERESTORY STOREFRONT WEST ELEVATION
3"=1'-0"









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Project No. FH196033

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ENGINEER STATE LICENSE SEAL

EXISTING CONDITIONS

08.31.2023

CONSTRUCTION DOCUMENTS


NOT FOR CONSTRUCTION

APR REVIEWER: CMQ

TERRACON'S PROJECT NUMBER: FY226137

SHEET TITLE:


DETAILS

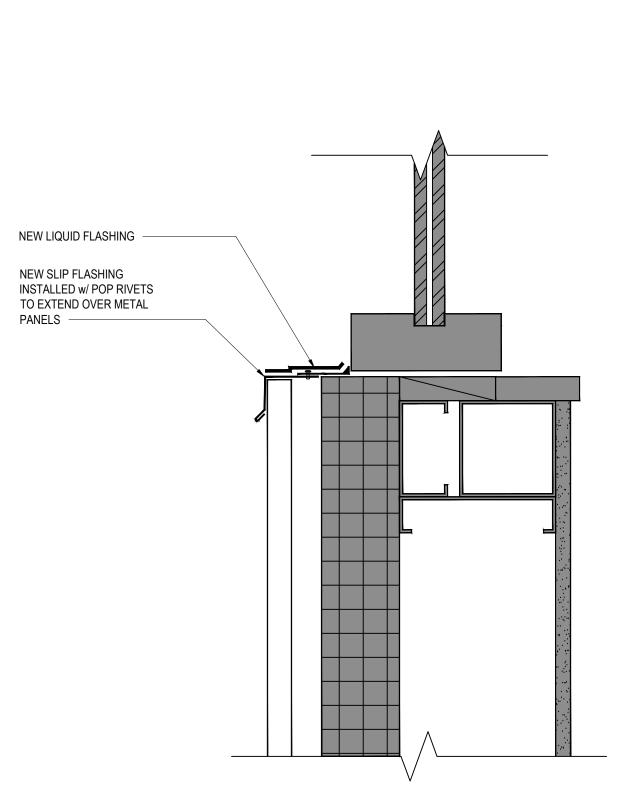

5 METAL PANEL SLIP FLASHING @ STOREFRONT SYSTEM
3"=1'-0"

EXISTING CONDITIONS



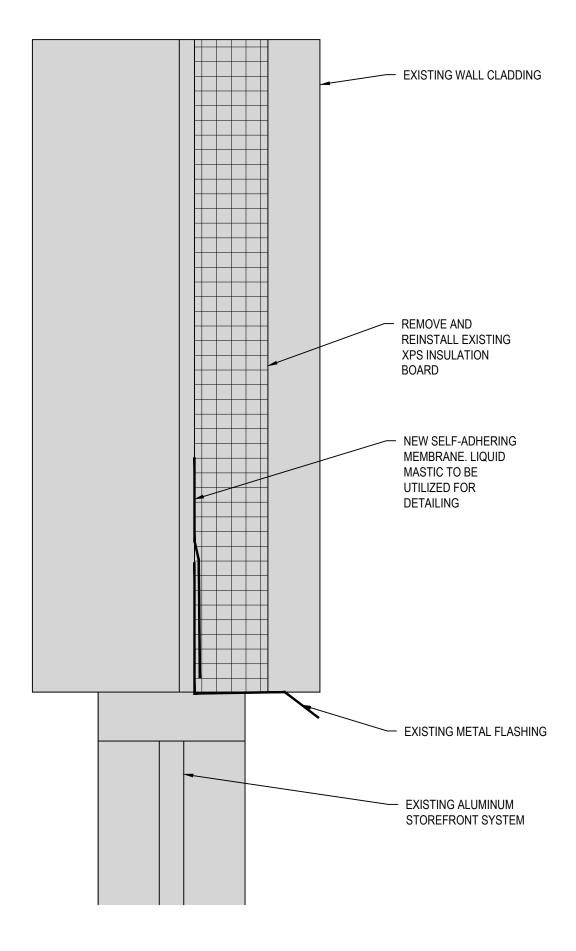

SECTION

3"=1'-0"

ierracon

7327-G WEST FRIENDLY AVENUE
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N.C. A&T STATE UNIVERSITY
TOR ACADEMIC HALL EXTERIOR
FACADE REPAIR PROJECT

116 DANIEL STREETGREENSBORO, NC 27401

ISSUE DATE:

08.31.2023

ISSUE FO

CONSTRUCTION DOCUMENTS
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ADDENDUM:

No.: DATE: DESCRIPTION:

PROJECT TEAM:

SSS DRAWN BY:

LJG APR REVIEWER:

CMQ
TERRACON'S PROJECT NUMBER:

FY226137

SHEET TITLE:

DETAILS

SHEET NUMBER:

R-502